



## Stormwater Management Report

Upgrades to Northmead Public School

**Project Reference: 132567**

January 2025

Prepared For: School Infrastructure NSW

52A Moxhams Road, Northmead

**Meinhardt**

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REV	DATE	WRITTEN BY	REVIEWED BY	APPROVED BY
00	19.12.2024	BK	LM	BL
01	09.01.2025	BK	LM	BL
02	24.01.2025	BK	LM	BL
03	05.02.2025	BK	LM	BL
04	12.02.2025	BK	LM	BL
05	26.02.2025	BK	LM	BL

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### **3. Introduction**

This Stormwater Management Report has been prepared to accompany a Review of Environmental Factors (REF) for the Department of Education (DoE) for upgrades to Northmead Public School (the activity) under Part 5 of the Environmental Planning and Assessment Act 1979 (EP&A Act) and State Environmental Planning Policy (Transport and Infrastructure) 2021 (SEPP TI).

This document has been prepared in accordance with the Guidelines for Division 5.1 assessments (the Guidelines) by the Department of Planning, Housing and Infrastructure.

This report examines and takes into account the relevant environmental factors in the Guidelines and Environmental Planning and Assessment Regulations 2021 under Section 170, Section 171 and Section 171A of the EP&A Regulation.

#### **3.1 Proposed Activity Description**

The proposed activity for upgrades to Northmead Public School includes:

- One (1) new single storey classroom building comprising of four (4) general learning spaces (GLS), two (2) special program spaces, a singular learning commons space and a singular multi-purpose space.
- Minor internal alterations to an existing Admin Building (known as Building A); and
- Removal of existing portable classroom buildings containing six (6) classrooms.

#### **3.2 Activity Site**

The project site is located at 52A Moxhams Road, Northmead and is legally described as:

- Lot 1 DP 366405;
- Lot 1 DP 176742;
- Lot 1 DP 20061; and
- Lot 1 DP 209810.

Northmead Public School is located on the southern side of Moxhams Road and on the western side of Kleins Road.

Figure 1 provides an aerial photograph of the site.



Figure 1 Aerial photograph

## 4. REF Reporting Requirements

This report has been prepared in accordance with environmental mitigation measures and technical stormwater management plan to meet the City of Parramatta Council requirements for the proposed activity. The REF deliverable requirements are presented in Table 1.

Item	REF Requirement	Relevant Section of Report
1	<i>Stormwater Management Plan</i>	<i>Section 5.1 and 6.0 consider design solutions to mitigate water quality by treatment devices.</i>

Table 1. Relevant REF Requirements

## 5. Flood assessment

### 5.1 Existing Scenario

The subject site is located within the Parramatta Council Local Government Area (LGA). Available Flood maps indicate that Northmead Public School is partially affected by overland flows from Thomas Street and Kleins Road and during the PMF event, overland flows run across the school site towards the western boundary, then flow through a few properties west of the site, and eventually discharge onto Allambie Avenue.

As specified Flood Assessment and Management report with Rev.02 by JHA, the existing site is affected by shallow overland sheet flow of less than 0.15m depth with the majority of flood depths onsite in PMF event and the site is not affected by overland flow during 1% AEP events (Figure 3). Therefore, FFLs set at least 500mm above ground level are deemed sufficient to protect the site from the PMF level in the Existing Scenario (Figure 2).

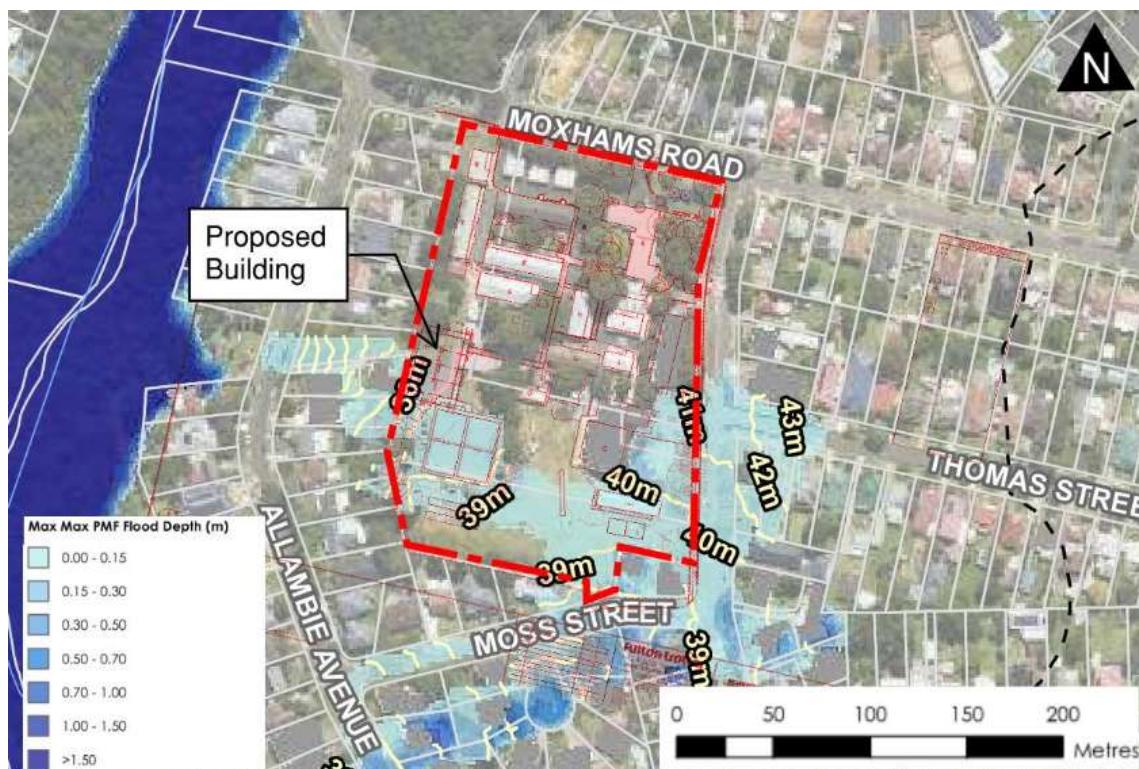


Figure 2. Peak flood levels and depths at the site in the PMF event, pre-development of school.

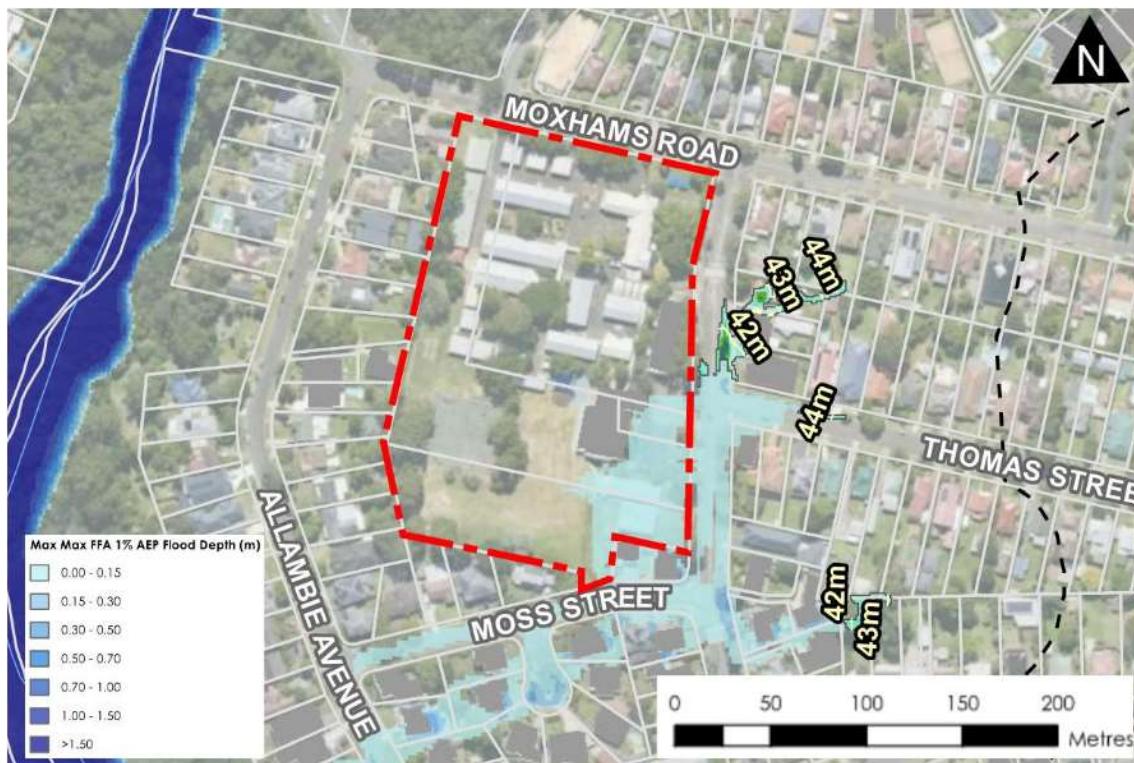


Figure 3. Peak flood levels and depths at the site in the 1% AEP event, pre-development of school.

## 5.2 Post-Development Scenario

As in the PMF depths within the school site are generally less than 0.15m, while the pooling flood waters around the perimeter of the proposed building area of a similar depth, ranging generally between 0~0.15m.

According to the flood report by JHA, there is a possibility that surface runoff and overland flow coming across the school site from Kleins Road can be trapped along the existing fence. The proposed building slightly encroaches on the internal PMF flow path as shown in Figure 4. It is notable that the building's floor level is set at 37.55m AHD, which is 0.55m above the adjacent PMF level of 37.00m AHD.

In order to mitigate flood impact at the site, the civil plan shows a minimum of 500mm masonry walls at the rear of the proposed building and a minimum of 500mm high open space with 0.1m mesh or any approved product by SINSW or the builder to divert the water flow quickly and improve overland flow path with less blockage.

To mitigate and improve site conditions, we suggest adequate excavation and earthwork along the boundary to mitigate flood impact and drain out quickly during PMF events (Figure 4).

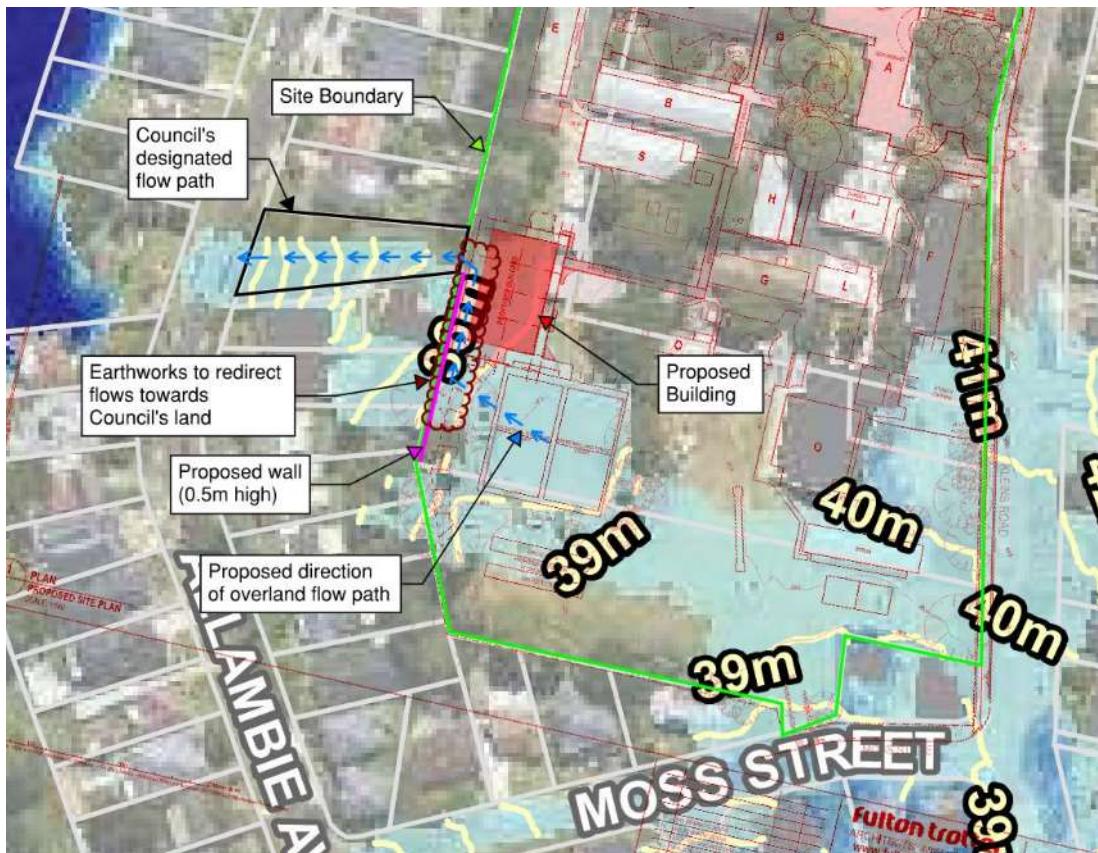


Figure 4. Peak flood levels and depths at the site in the PMF event, post-development of school.

## 6. Stormwater Quantity Management

### 6.1 Stormwater Drainage Works

Stormwater works proposed consist of:

- A pit and pipe system within the site area to convey minor flows (in accordance with the Major/Minor stormwater strategy approach defined in Australian Rainfall and Runoff). Roof drainage system has been designed, and documented by the Hydraulic Engineer, and is directly discharged to OSD tank near the proposed building after filter treatment on Moxhams Road.
- A detention tank by Atlan is provided (with water quality treatment cartridges contained within the tank) in order to limit post-development flows to less than PSD flows from the stormwater management policy.
- Overland flow paths and trench drains are provided to cater for upstream catchments to bypass the development site, and to convey major storm flows within the development area along the existing swales at the rear of the proposed building and discharge the surface runoff adjacent to the boundary via the existing headwall and on the surface at the same time.

The proposed stormwater adjustments are shown in Figure 5.

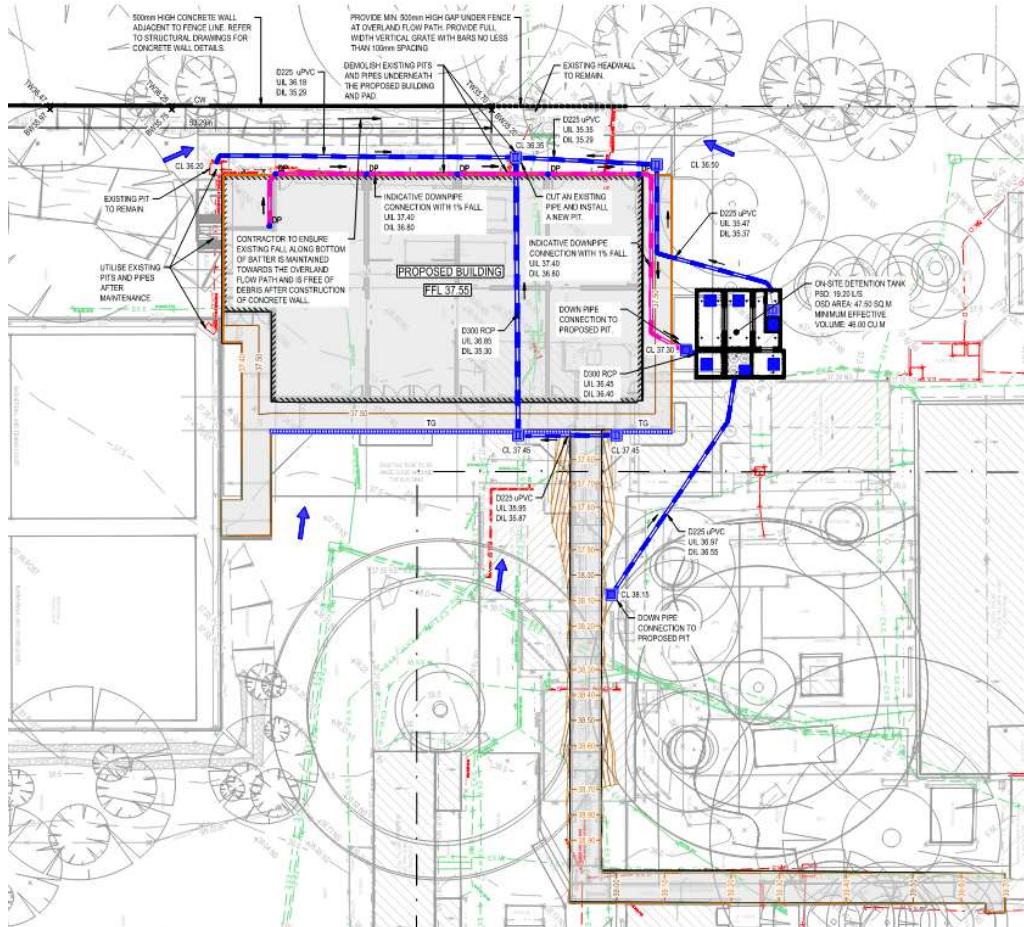


Figure 5. Stormwater System for Proposed Development.

## 6.2 On Site Detention

Council requires the provision of an on-site detention system to ensure that new developments do not increase peak stormwater flows in any downstream area during major storms up to and including 100-year ARI events.

The Upper Parramatta River Catchment Trust (UPRCT) “On-site Stormwater Detention Handbook-Fourth Edition” in Page 3-3 sets out the steps in determining the applicable permissible site discharge (PSD) to the proposed development and the size of the OSD tank to be required.

### ***PSD & SSR – Building Catchment***

- PSD:
  - Primary Orifice Outlet ( $SRD_L$ ):  $40 \text{ L/s/ha} \times 0.101 \text{ ha} = 4.04 \text{ L/s}$
  - Secondary Orifice Outlet ( $SRD_U$ ):  $150 \text{ L/s/ha} \times 0.101 \text{ ha} = 15.15 \text{ L/s}$
- SSR:
  - Primary Orifice Outlet (EDD):  $300 \text{ m}^3/\text{ha} \times 0.101 \text{ ha} = 30.3 \text{ m}^3$
  - Secondary Orifice Outlet (Total):  $455 \text{ m}^3/\text{ha} \times 0.101 \text{ ha} = 45.96 \text{ m}^3$

Storm event	PSD	SSR
Primary Orifice Outlet ( $SRD_L$ )	40 L/s/ha	300 m <sup>3</sup> /ha
Secondary Orifice Outlet ( $SRD_U$ )	150 L/s/ha	455 m <sup>3</sup> /ha

Table 2. PSD and SSR from On-site Stormwater Detention Handbook-Fourth Edition by UPRCT

Storm event	OSD Post-Development Flow (L/s)	OSD Bypass Flow(L/s)
1.5-year ARI	4.04	0
100-year ARI	19.19	0

Table 3. Peak Discharge Results in UPRCT Calculation Sheet.

The OSD requirement for the development was calculated using the URPCT Calculation Sheet to determine the size of the proposed piped network and the respective OSD in order to satisfy major/minor system requirements in accordance with the UPRCT requirements and shown on Table 2.

These parameters were used in determining the PSD and SSR applicable to the proposed development. The calculation for the sizing of the OSD tank is attached in Appendix E.

The total catchment areas proposed to drain into the OSD is 0.101 hectare. The required OSD tank volume calculated using UPRCT calculation spreadsheet is 45.96 m<sup>3</sup>. All roof and covered walkway are proposed to drain into the OSD tank as per the catchment plan. Most of this runoff will drain into the

storm filter chamber first to undergo treatment (further discussed in Section 6). Water shall flow above the access hatch (RL 36.95m and 35.60mAHD) when it reaches the maximum volume of the storage.

OSD TANK	Diameter (mm)
Primary Orifice Outlet (SRD <sub>L</sub> )	49
Secondary Orifice Outlet (SRD <sub>U</sub> )	95

Table 3. Orifice Plate Diameter

Discharge is controlled via an orifice plate in OSD tank. These are installed at the outlet in order to satisfy post development conditions under council regulations.

The OSD tank plans and details are provided in Appendix D.

The design criterion for below ground pipe drainage has been adopted from UPRCT “On-site Stormwater Detention Handbook-Fourth Edition” and are listed as follows:

- Minor Extended Detention Storage 1.5-year ARI
- Major OSD systems (Total storage) 100-year ARI

### 6.3 Catchment Plan

The proposed catchment plan for the site is presented in Figure 6 and further detailed in Appendix C. The proposed site's catchment is comprised of roof and covered walkway drainage. Flows coming from the roof will be conveyed through downpipes which will all discharge into the proposed OSD tank storage.

The total catchment area across the proposed site is approximately 0.101 hectares comprised of roof and covered walkway zone. 100% of the total site area is proposed to drain into the proposed OSD tank. This is comprised of two roof catchment areas (Grey and blue hatches).

As per UPRCT “On-site Stormwater Detention Handbook-Fourth Edition” Clause 5.1, no more than 30% of the total area shall bypass the OSD tank. This control yields a maximum bypass of 0.0303 hectare which is 30% of the total site area. As shown in the catchment plan, there is no bypass zone for the proposed development area and simply diverts the water flow from the upstream catchment area around the proposed building.

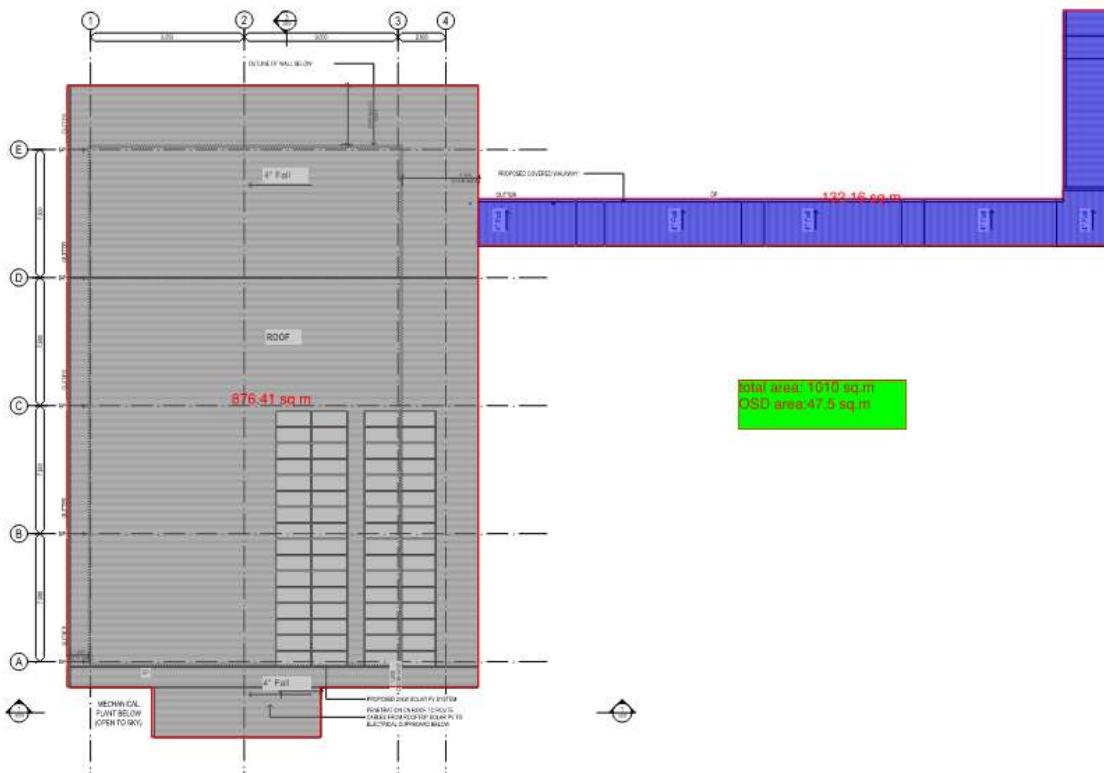


Figure 6. Site Catchment Plan

## 7. Stormwater Quality Strategy

To meet UPRCT requirements for stormwater management, the water quality strategy will need to include treatment of the stormwater prior to discharge to the nominated point of connection, reducing water borne pollutants as per all relevant guidelines.

Treating and reducing stormwater has multiple environmental benefits including improving urban amenity, reducing pollutant loadings downstream in receiving waters, retarding peak stormwater flow rates and reducing irrigation demands from potable water supply.

All roof catchments are required to discharge to the point of connection via On-site detention before the treatment chamber.

### 7.1 Water Quality Treatment Train

Modelling of the pollutant loads for the proposed development has been carried out using MUSIC. Diagrammatic illustrations of the model setup are presented in Figure 7 below.

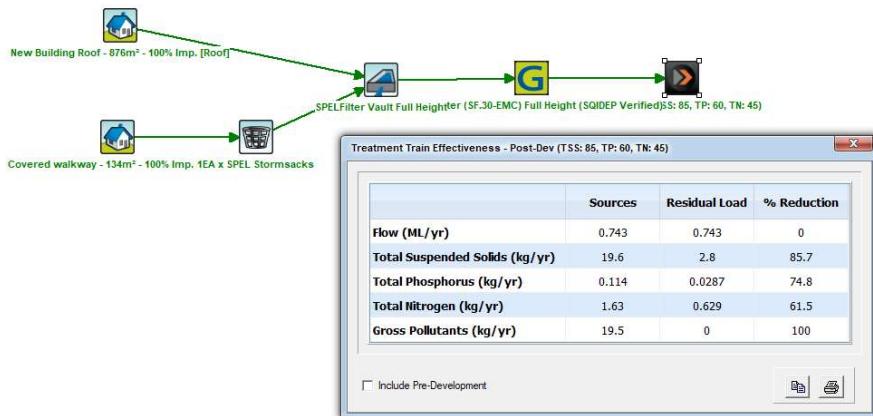


Figure 7. Music Modelling Treatment Train (OSD).

The model has been set up to inclusively incorporate all relevant catchments of the development to represent realistic site conditions for pollutant generation and treatment.

## 7.2 Stormwater Quality Treatment Devices

The stormwater management requirements for the development are dependent on the adequate treatment measures to mitigate and exceed stormwater borne pollutant reduction targets as per the relevant guidelines. The treatment systems have been nominated in the table below (or approved equivalents):

Treatment System	Capacity/Area	Quantity
Atlanfilter (SF 30 EMC-M, 850mm tall)	0.006cu.m./s high flow by-pass	3
Atlan StormSack	0.011cu.m./s high flow by-pass	1

Table 4. WSUD Treatment System

## 7.3 Treatment Device Specifications

The Atlanfilter shown in Figure 9 below is a proprietary treatment device that acts as a filter removing pollutants. This system is generally used to filter storm water from various pollutants prior to entering waterways. 3EA for OSD which is 850mm in height will be installed in the OSD tank. Figure 9 shows a diagram of how an Atlanfilter works.

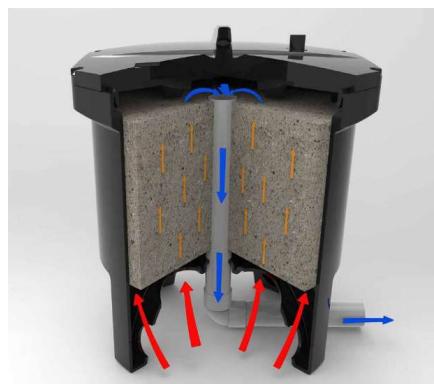


Figure 9. Atlanfilter by Atlan

The stormsack is installed inside inlet pits that act as Gross Pollutant Traps. This 200-micron filter system shown in Figure 10 below is generally used to remove trash, debris and other pollutants from runoff prior to entering waterways. 1 Stormsack will be installed inside the drainage pit adjacent to the proposed covered walkway to the southeast.



Figure 10. Stormsack by Atlan

## 7.4 MUSIC Modelling Results

The results from the MUSIC model validate that the proposed treatment measures reduce Total Suspend Solids by more than 85% and nutrients, Phosphorus by more than 60%, and Nitrogen by more than 45% for the proposed development. The results are summarised in the figure below.

Target Guideline	Water-Borne Pollutant	Reduction Target	Result	Target Met
WSUD Best Practice Guiding Principles	Total Suspended Solids	85% Reduction	85.7% Reduction	Yes
	Total Phosphorous	60% Reduction	74.8% Reduction	Yes
	Total Nitrogen	45% Reduction	61.5% Reduction	Yes
	Gross Pollutants	90% Reduction	100% Reduction	Yes

Table 5. MUSIC Modelling Results Summary (OSD)

## 8. Sediment and erosion management

The site is to be provided with sediment fence, straw bales, and filters.

Although the construction of a sediment basin may be considered unnecessary during the early works stage for sediment runoff in the minor storm event (6 months ARI and 1yr ARI), the provision of a grassed overland flow zone provides an area of sediment storage that will reduce the likelihood of sediment runoff. Sediment runoff during minor storm events would be temporarily stored in the vegetated open space with straw bales after headwall discharge (See Figure 11 below). The open space with straw bales would need to be regularly maintained and cleaned after each rainfall event.

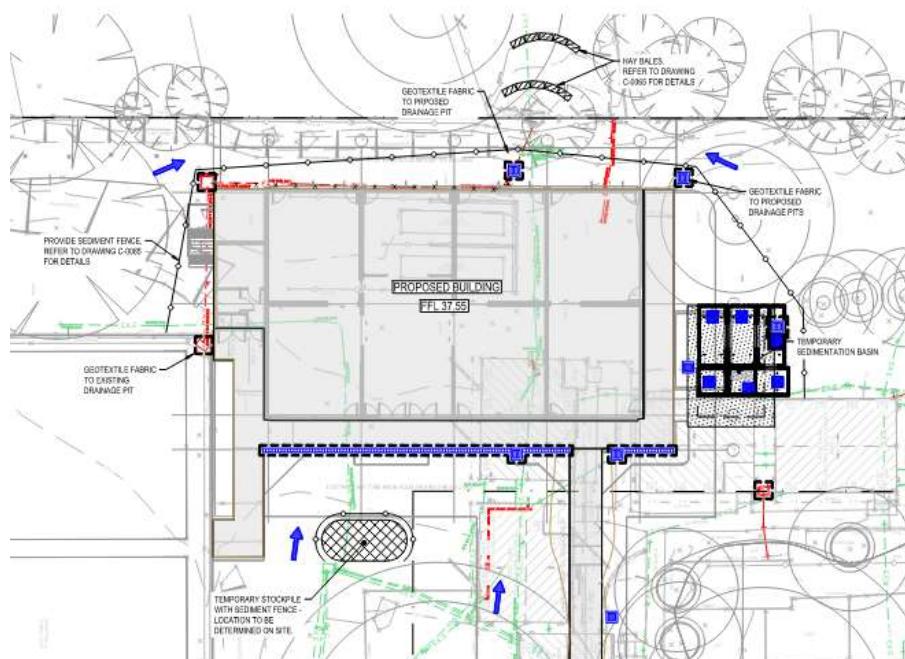


Figure 11. Sediment and erosion control

## 9. Bulk Earthworks

During bulk earthworks, 150mm topsoil removal, platform for the proposed covered walkway, OSD, stormwater pipes and pits are expected except the area below the suspended slab. The total volume of bulk is relatively reasonable with approximately 9.15cu.m fill required which are based on 60.11cu.m cut and 69.26cu.m fill respectively.

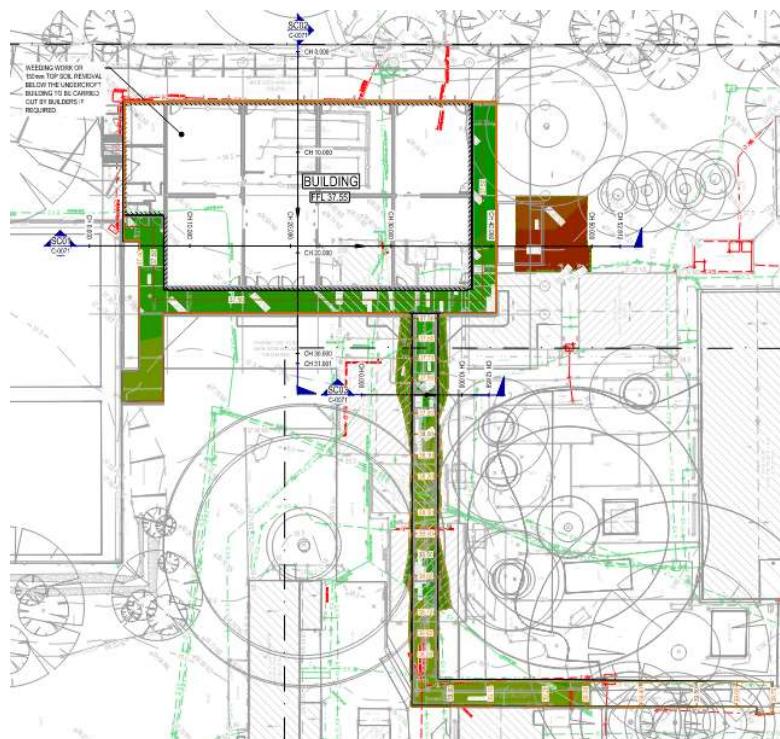


Figure 12. Bulk earthworks

## 10. Construction Management

During the construction phase, the maintenance and monitoring of erosion and sediment control measures remain the responsibility of the project Contractor. Details of the inspection frequency expected will need to be noted within the Operational Environmental Management Plan (EMP) and Operations & Maintenance Manual by a manufacturer (Atlan). If during the construction phase of the activity, it is deemed necessary, monitoring of the erosion and sediment control measures will be undertaken by a qualified consultant to determine the impact of construction activities on the subject site only. In addition, an approved inspector will have an inspection for maintenance purposes during approved work hours and respite period.

- The Out of School Hours Care (OSHC) proposed hours operational hours could be determined closer to date but can consider typical timings 6.30AM-9.00AM (Before school) and 3.00-6.30PM (After school)
- The Exact number of students attending the OSHC could not be confirmed at this stage, however, assume 15% students of the school capacity
- The OSHC is Typically run by external/private providers

## 11. Maintenance Program

A suitable maintenance program is the responsibility of the site Owners for the development in conjunction with correspondence and consultation by appropriate parties, such as project engineers or manufacturers. As a guide, the below programs provide a minimum maintenance protocol for the proposed treatment systems to ensure longevity in their stated performance.

### 11.1 Proprietary Treatment Devices

Proprietary Treatment devices should be maintained in accordance with the manufacturers' specifications, but in general will include 1~6 times inspections with annual maintenance of for full cleaning recommended and every 12 months minor services for Atlan filter. Treatment Devices are generally (depending on model) cleaned as outlined below:

- It is sometimes appropriate to de-water the system before attempting to suck the pollutants out of the holding chamber. This can be done onto adjacent ground or into council's sewer systems, with the authority's consent.
- It is recommended that additional monitoring for "Stormsack" is conducted following moderate to extreme rainfall events, especially previous months have had litter or no rainfall.

Generally, the need for maintenance can be determined easily by opening the unit from the surface and inspecting it.

Refer to the manufacturer's maintenance agreement and specifications for additional information.

## 12. Mitigation Measures

A summary of mitigation measures is outlined below and detailed in the relevant report sections.

Mitigation Number/ Name	When is Measure to be complied with	Mitigation Measure	Reason For Mitigation Measure
Section 5 / Flood Assessment	Prior to commencement of Flood Construction. Prior to commencement of Operation.	Flood Mitigation – Sufficient drainage provisions should be provided behind the proposed building overland flow during 1% with 0.5m high masonry walls and Min. AEP and PMF events. 0.5m high open space for quick waterflow during PMF events.	To mitigate flood impact
Section 7.2 / Stormwater Quality Treatment Devices	Prior to commencement of any works during Design. Prior to commencement of Operation.	Stormwater Quality Treatment – Treatment measures are not expected to meet the council to significantly impact the surrounding requirements. receivers and are predicted to comply with design criteria.	To improve water quality
Section 8 / Sediment and Erosion Management	Prior to commencement of Construction. Prior to commencement of Operation.	Sediment and erosion control – Sediment and erosion measures are not anticipated to significantly impact construction and early the site by mitigation of sediment basin, work stage. straw bales, inlet traps & filters.	To mitigate sediment and erosion during
Section 10 / Construction Management	Prior to commencement of Construction.	All works will be scheduled in accordance with the following: Works to be scheduled taking into the subject site. account approved works hours, any restrictions relevant to specific tools / activities and respite periods etc.	To minimize the impact of construction activities on
Section 11 / Maintenance Program	Prior to commencement of any works during Design. Prior to commencement of Operation.	Maintenance Program – Treatment device replacement by the minimum manufacturer is not expected to impact protocol for the proposed the surrounding receivers.	To identify and provide a treatment systems.

## 13. Evaluation of Environmental Impacts

This report has been prepared to assess the potential environmental impacts that could arise from the development of The Northmead Public School at 52A Moxhams Road, Northmead. Water quality and sediment & erosion control are adequately adopted throughout the site during early works and construction phase by water quality devices, sediment fences, sediment basins and proper mitigation measures and inspection and maintenance work will be scheduled during off peak hours and approved work hours.

Based on the identification of potential issues, and an assessment of the nature and extent of the impacts of the proposed development, it is determined that:

- The extent and nature of potential impacts are minor environmental impacts in terms of adequate stormwater management system with WSUD devices adjacent to the neighbouring property and will not have significant adverse effects on the locality, community and the environment.
- Potential impacts can be appropriately mitigated or managed to ensure that there is minimal effect on the locality, community.

Therefore, there are no significant impacts on the approval of a Review of Environmental Factors.

## 14. References

- AS/NZ 3500.3:2003 Stormwater Drainage  
Architectural plans by Fulton Trotter;  
UPRCT "On-site Stormwater Detention Handbook-Fourth Edition"  
eWater – *MUSIC Version 6.2*  
Watercom – *DRAINS Version 2023.07*  
Atlan Filter Operation & Maintenance Manual (Atlan)  
Atlan Stormsack Operation & Maintenance Manual (Atlan)  
Atlan Vault Technical Guideline (Atlan)

## Appendix A – Survey



# MOXHAMS

## ROAD

**HORIZONTAL DATUM:**  
CO-ORDINATE SYSTEM: MG  
MARKS ADOPTED: SSM 1657



A scale bar at the bottom left shows markings from 0 to 5. Below it, the text "SCALE 1:100" is printed. To the right, the word "CLIENT:" is followed by the text "DEPARTMENT OF EDUCATION" and "SCHOOL INFRASTRUCTURE".

**PLAN SHOWING SURVEY OF UNDERGROUND SERVICES  
OVER OVER LOT 1 IN DP176742, LOT 1 DP20061, LOT 1  
DP209810 & LOT 1 IN DP366405  
No.52A MOXHAMS ROAD  
NORTHMEAD, NSW, 2152**



**CMS SURVEYORS PTY LTD**  
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 [info@cmssurveyors.com.au](mailto:info@cmssurveyors.com.au)  
 [www.cmssurveyors.com.au](http://www.cmssurveyors.com.au)

SURVEYED BS/TH	DRAWN GP	CHECKED BS/TH	APPROVED RM
SURVEY INSTRUCTION 6482C	SCALE 1:100@A1	DATE OF SURVEY 25-28/09/23 & 4/11/24	
WING ME	<b>6482Cservice Northmead PS (2763)</b>	SHEET	ISSUE
LE 6482Cservice 2 Northmead PS (2763).dwg		2 OF 14	<b>2</b>

BENCH MARK  
SSM 165787  
E. 314073.940  
N. 6259802.140  
RL 44.972 (AHD)

## MOXHAMS

## ROAD

## ROAD

## (BITUMEN FORMATION)

## KLEINS

SEE SHEET 1 FOR NOTES &amp; LEGEND

HORIZONTAL DATUM:  
CO-ORDINATE SYSTEM: MGA 2020 (GROUND)  
MARKS ADOPTED: SSM 165787 & SSM 165850

VERTICAL DATUM:  
DATUM: AUSTRALIAN HEIGHT DATUM (AHD)  
B.M. ADOPTED: SSM 165787  
R.L. 44.972 (CLASS B)  
SOURCE: S.C.I.M.S. (18/08/2023)



SCALE 1:100


CLIENT:  
DEPARTMENT OF EDUCATION  
SCHOOL INFRASTRUCTURE NSW  
LGA: CITY OF PARRAMATTA

PLAN SHOWING SURVEY OF UNDERGROUND SERVICES  
OVER LOT 1 IN DP176742, LOT 1 DP20061, LOT 1  
DP209810 & LOT 1 IN DP366405  
No.52A MOXHAMS ROAD  
NORTHMEAD, NSW, 2152



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SURVEYED BS/TH	DRAWN GP	CHECKED BS/TH	APPROVED RM
SURVEY INSTRUCTION 6482C	SCALE 1:100@A1	DATE OF SURVEY 25/09/23 & 4/11/24	
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CAD FILE 6482Service 2 Northmead PS (2763).dwg			

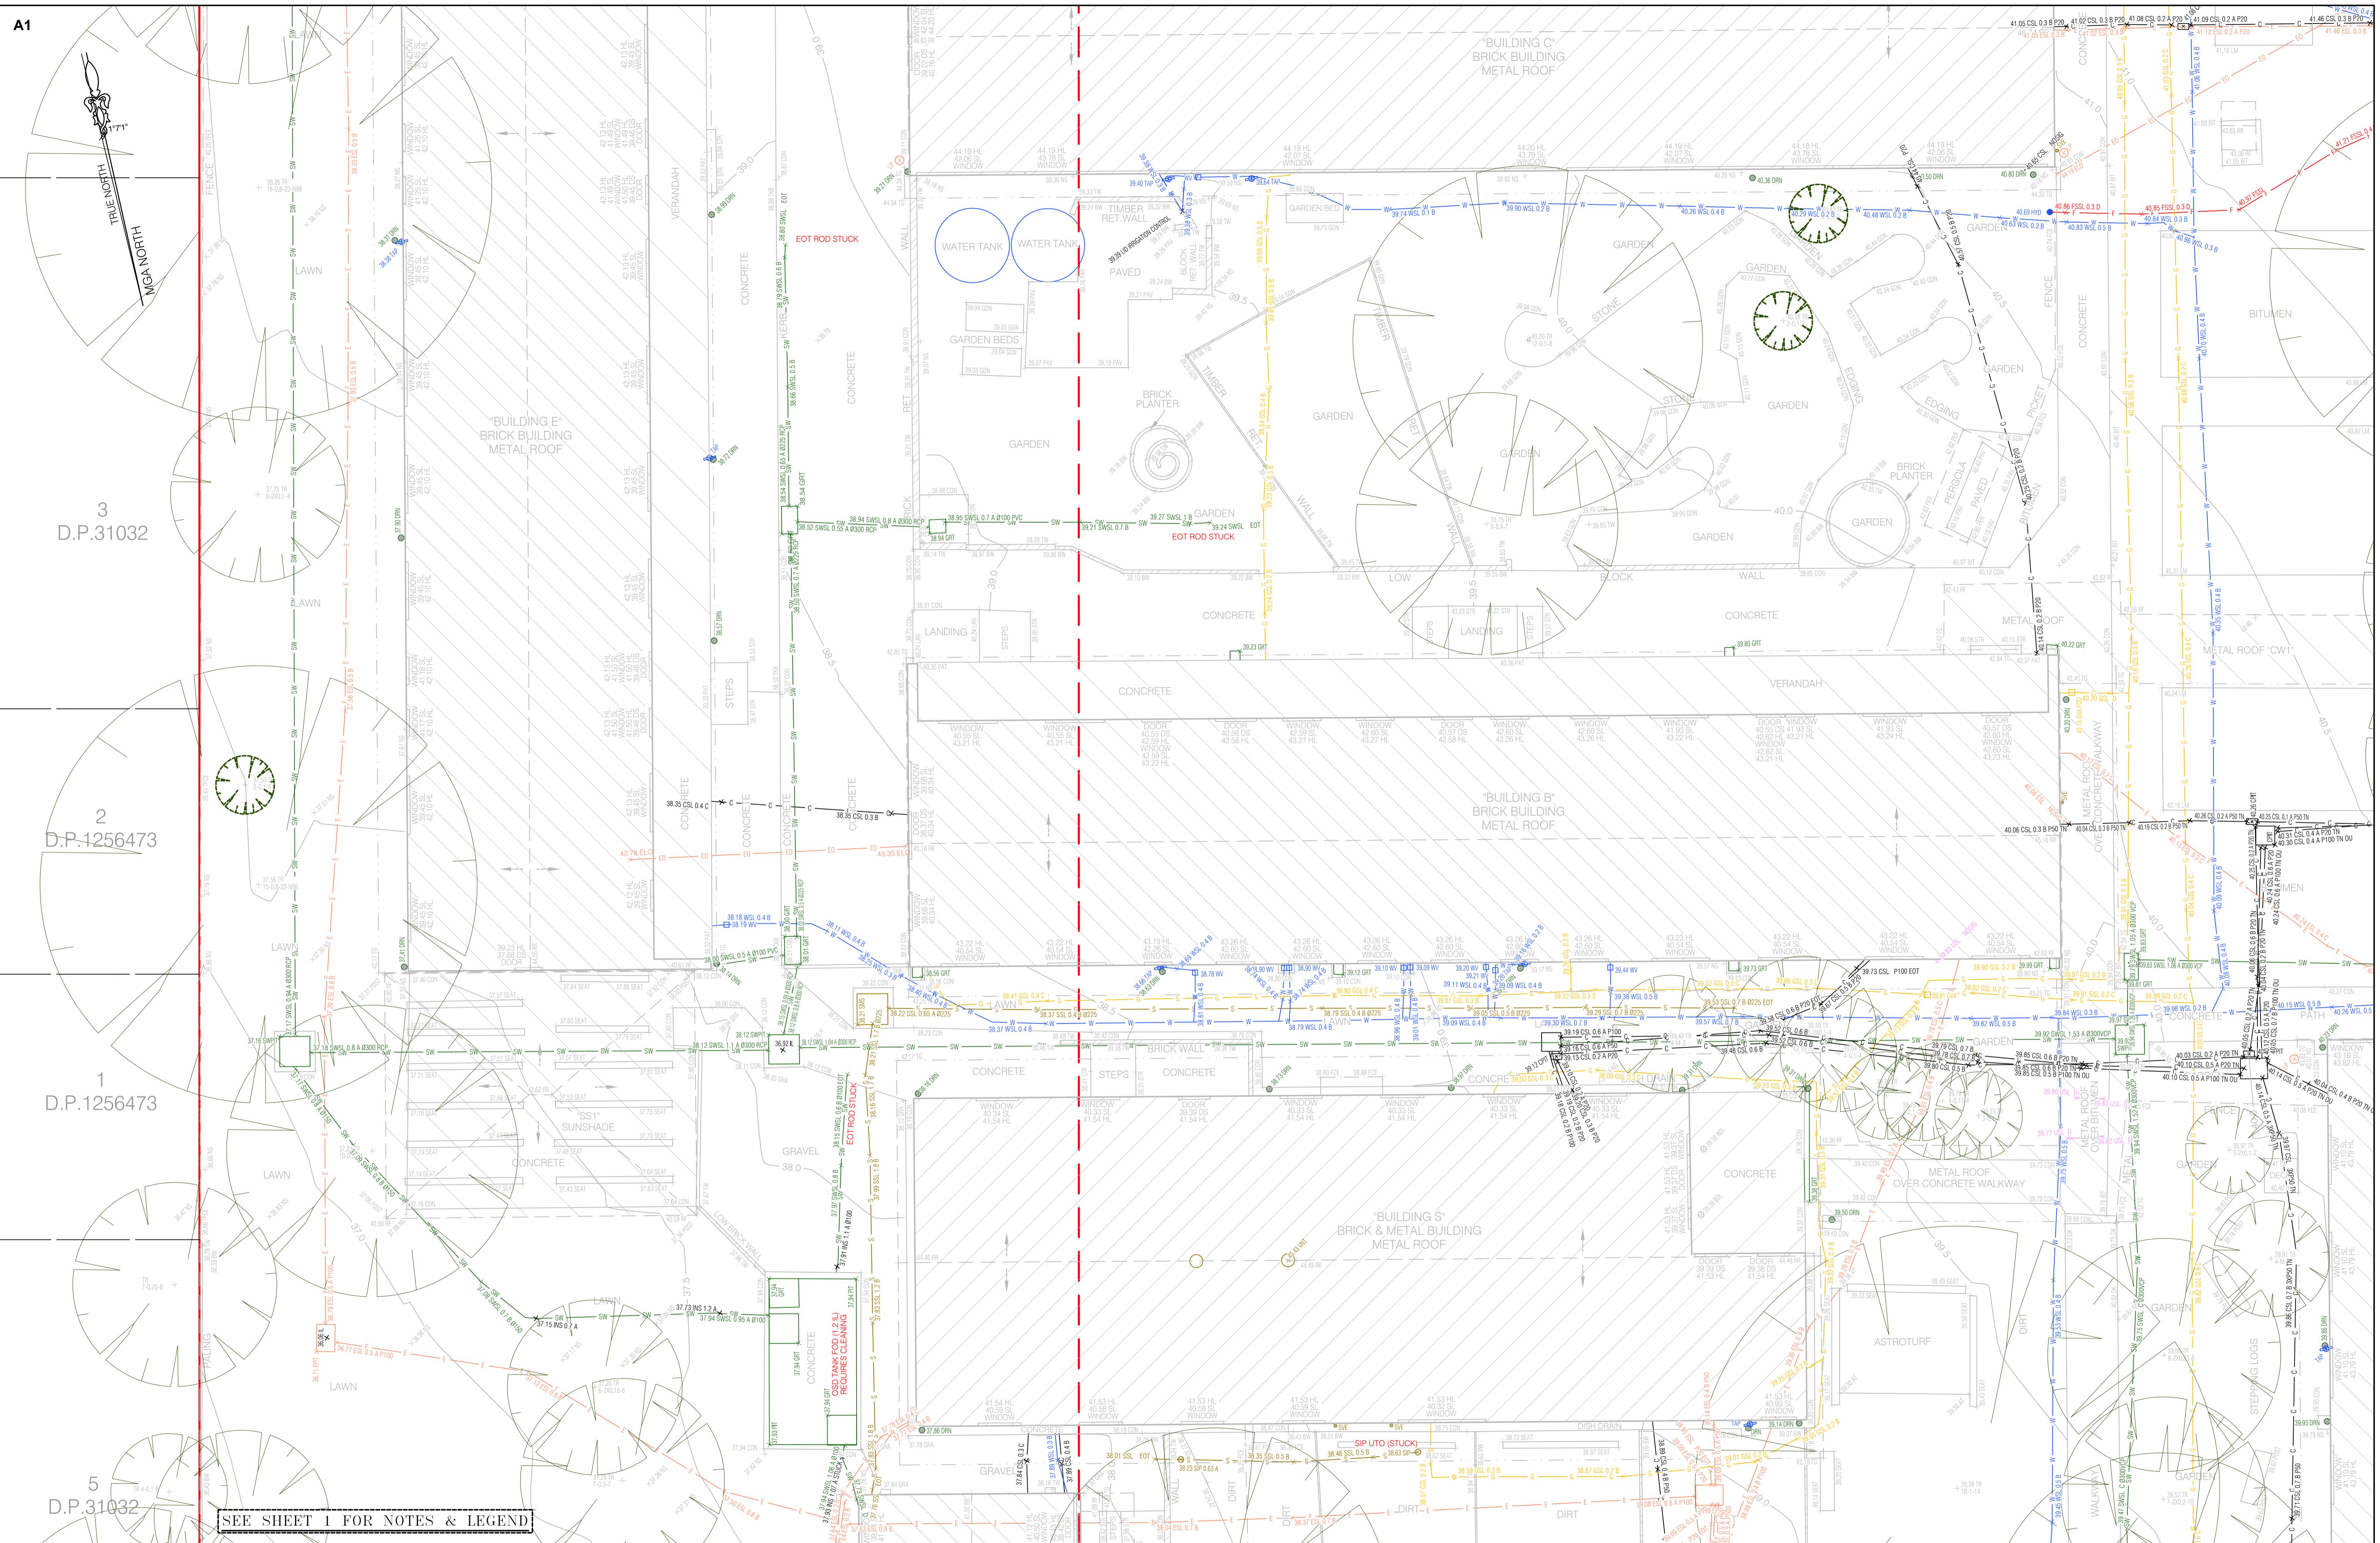


2 ADDITIONAL SERVICES & DETAIL ON LOT X DP31032 ADDED 12/11/2024

1 FIRST ISSUE 20/10/2023

HORIZONTAL DATUM:  
CO-ORDINATE SYSTEM: MGA 2020 (GROUND)  
MARKS ADOPTED: SSM 165787 & SSM 165850

VERTICAL DATUM:  
DATUM: AUSTRALIAN HEIGHT DATUM (AHD)  
B.M. ADOPTED: SSM 165787  
R.L. 44.972 (CLASS B)  
SOURCE: S.C.I.M.S. (18/08/2023)

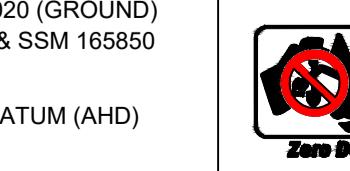


Zero Damage - Zero Risk


[www.b4ydi.com.au](http://www.b4ydi.com.au)

0 1 2 3 4 5  
SCALE 1:100

**CLIENT:**  
**DEPARTMENT OF EDUCATION**  
**SCHOOL INFRASTRUCTURE NSW**

**LGA: CITY OF PARRAMATTA**

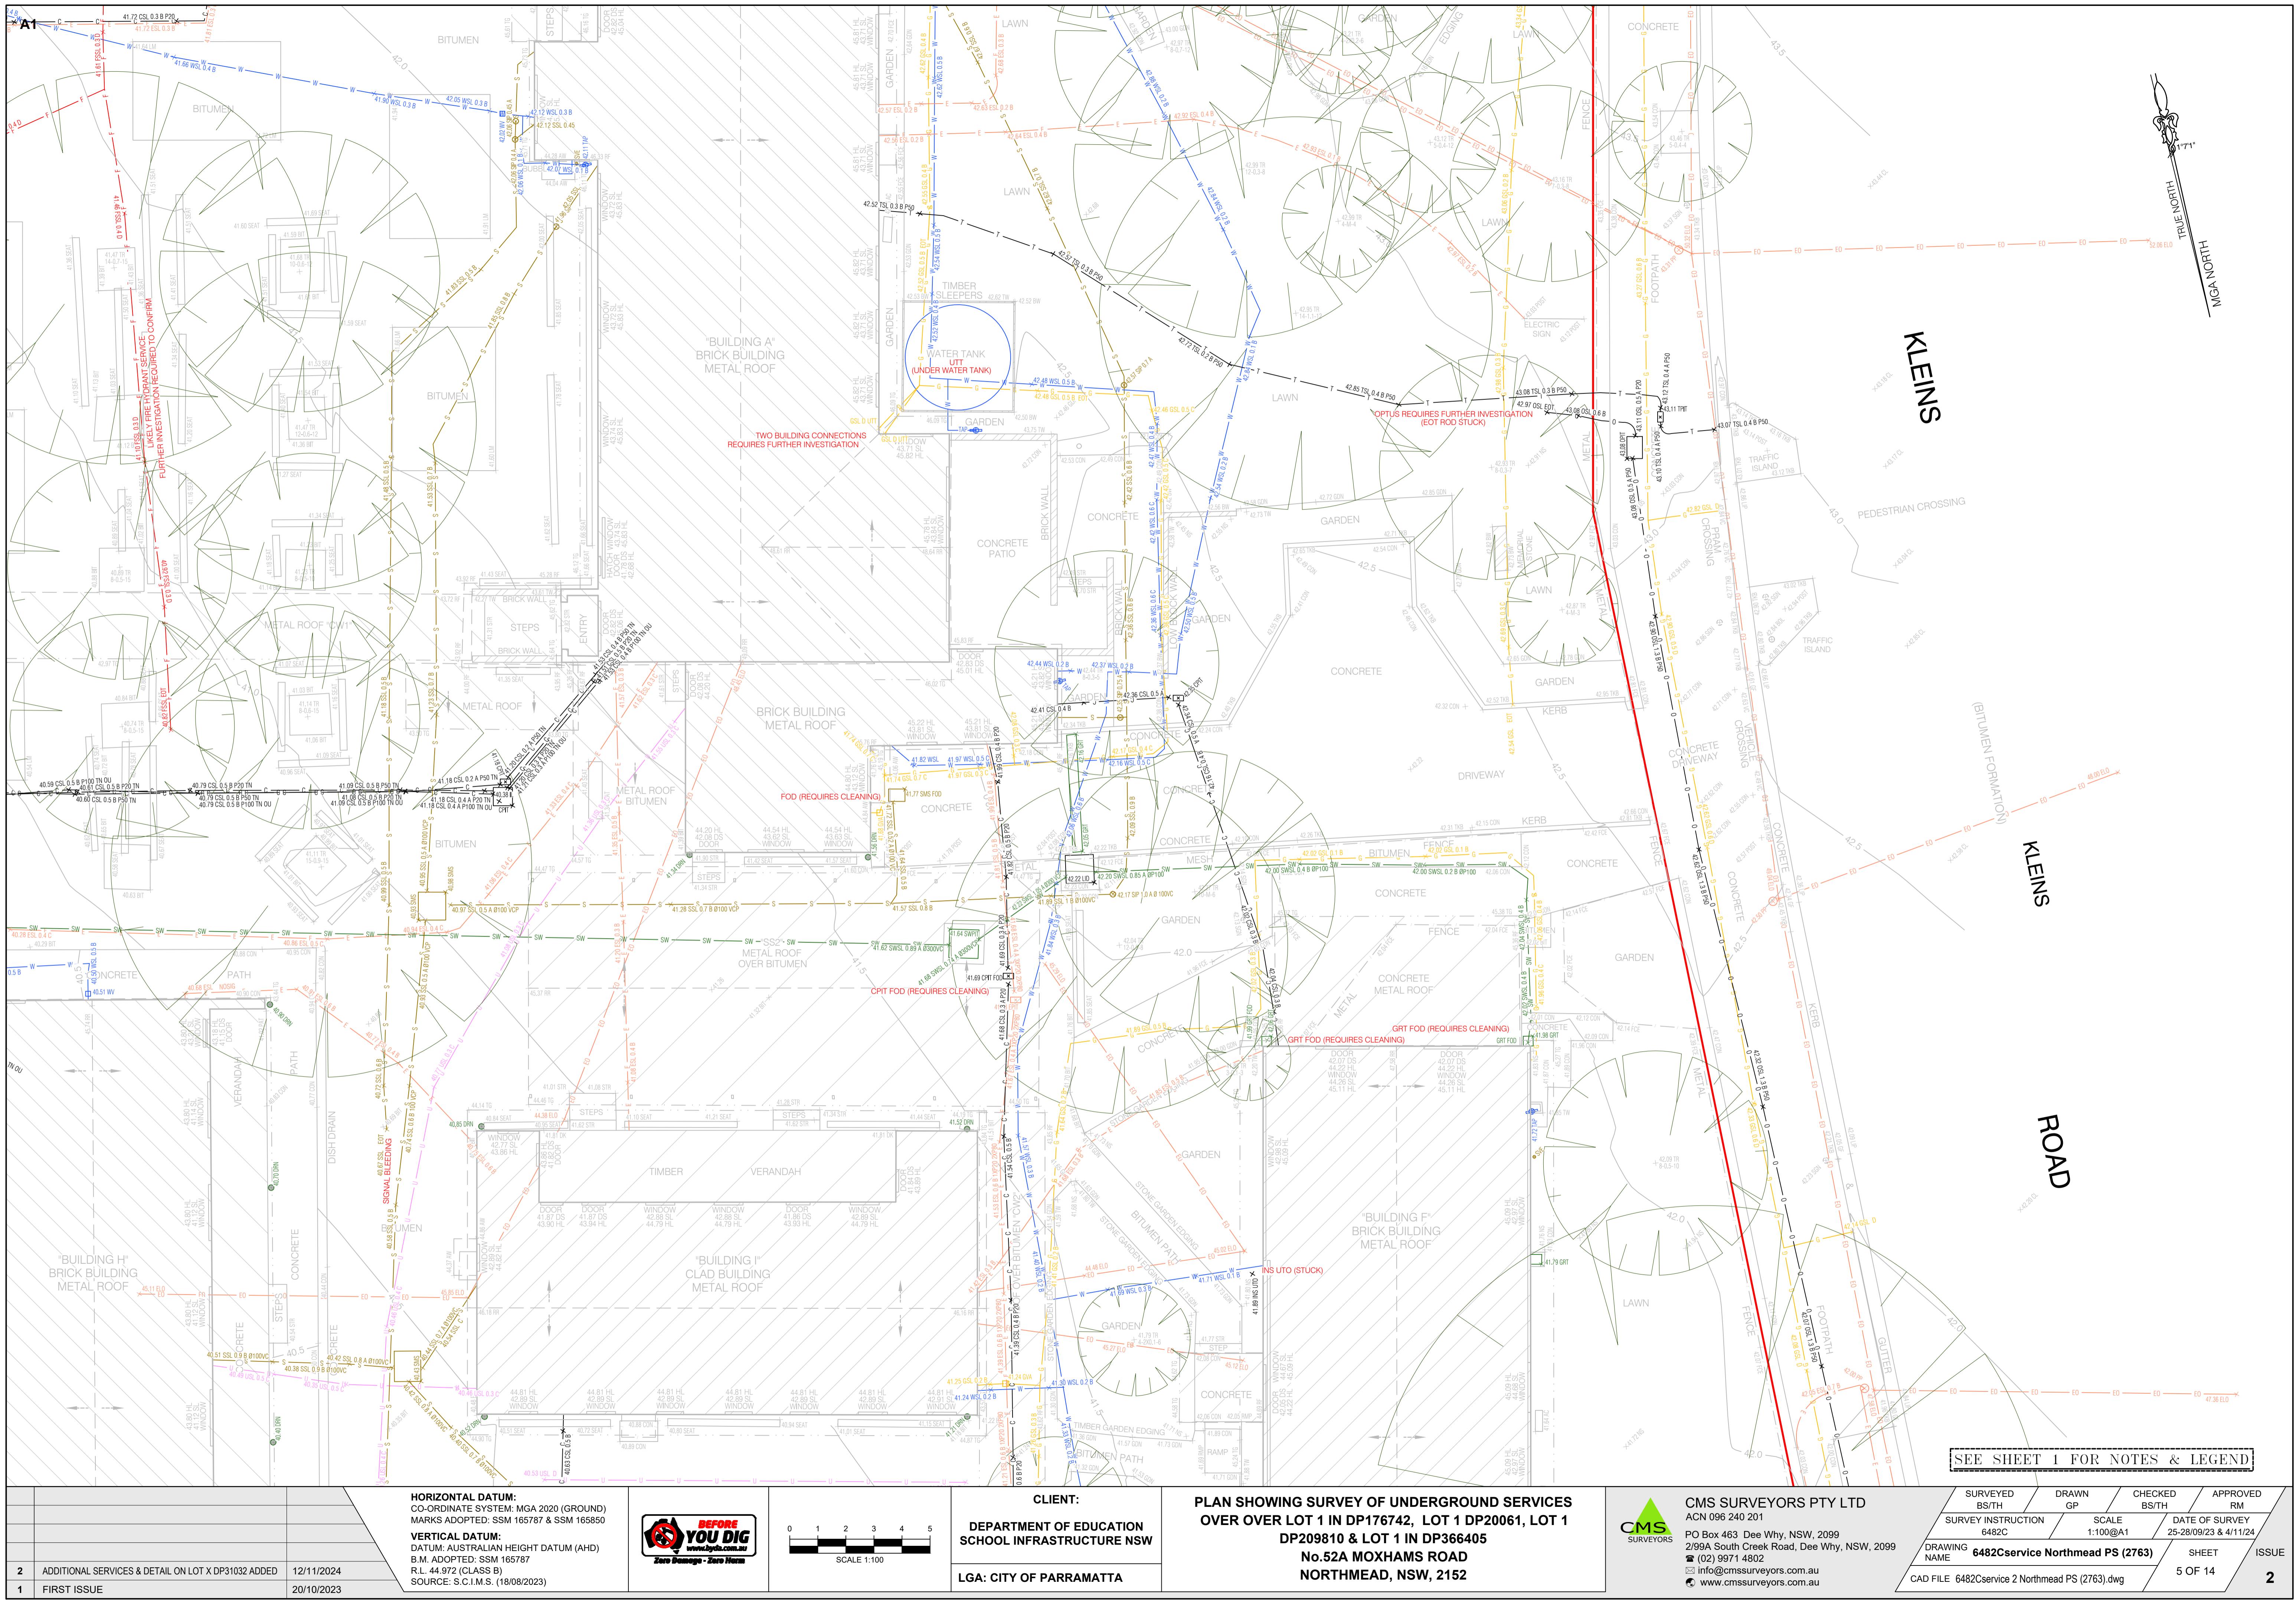

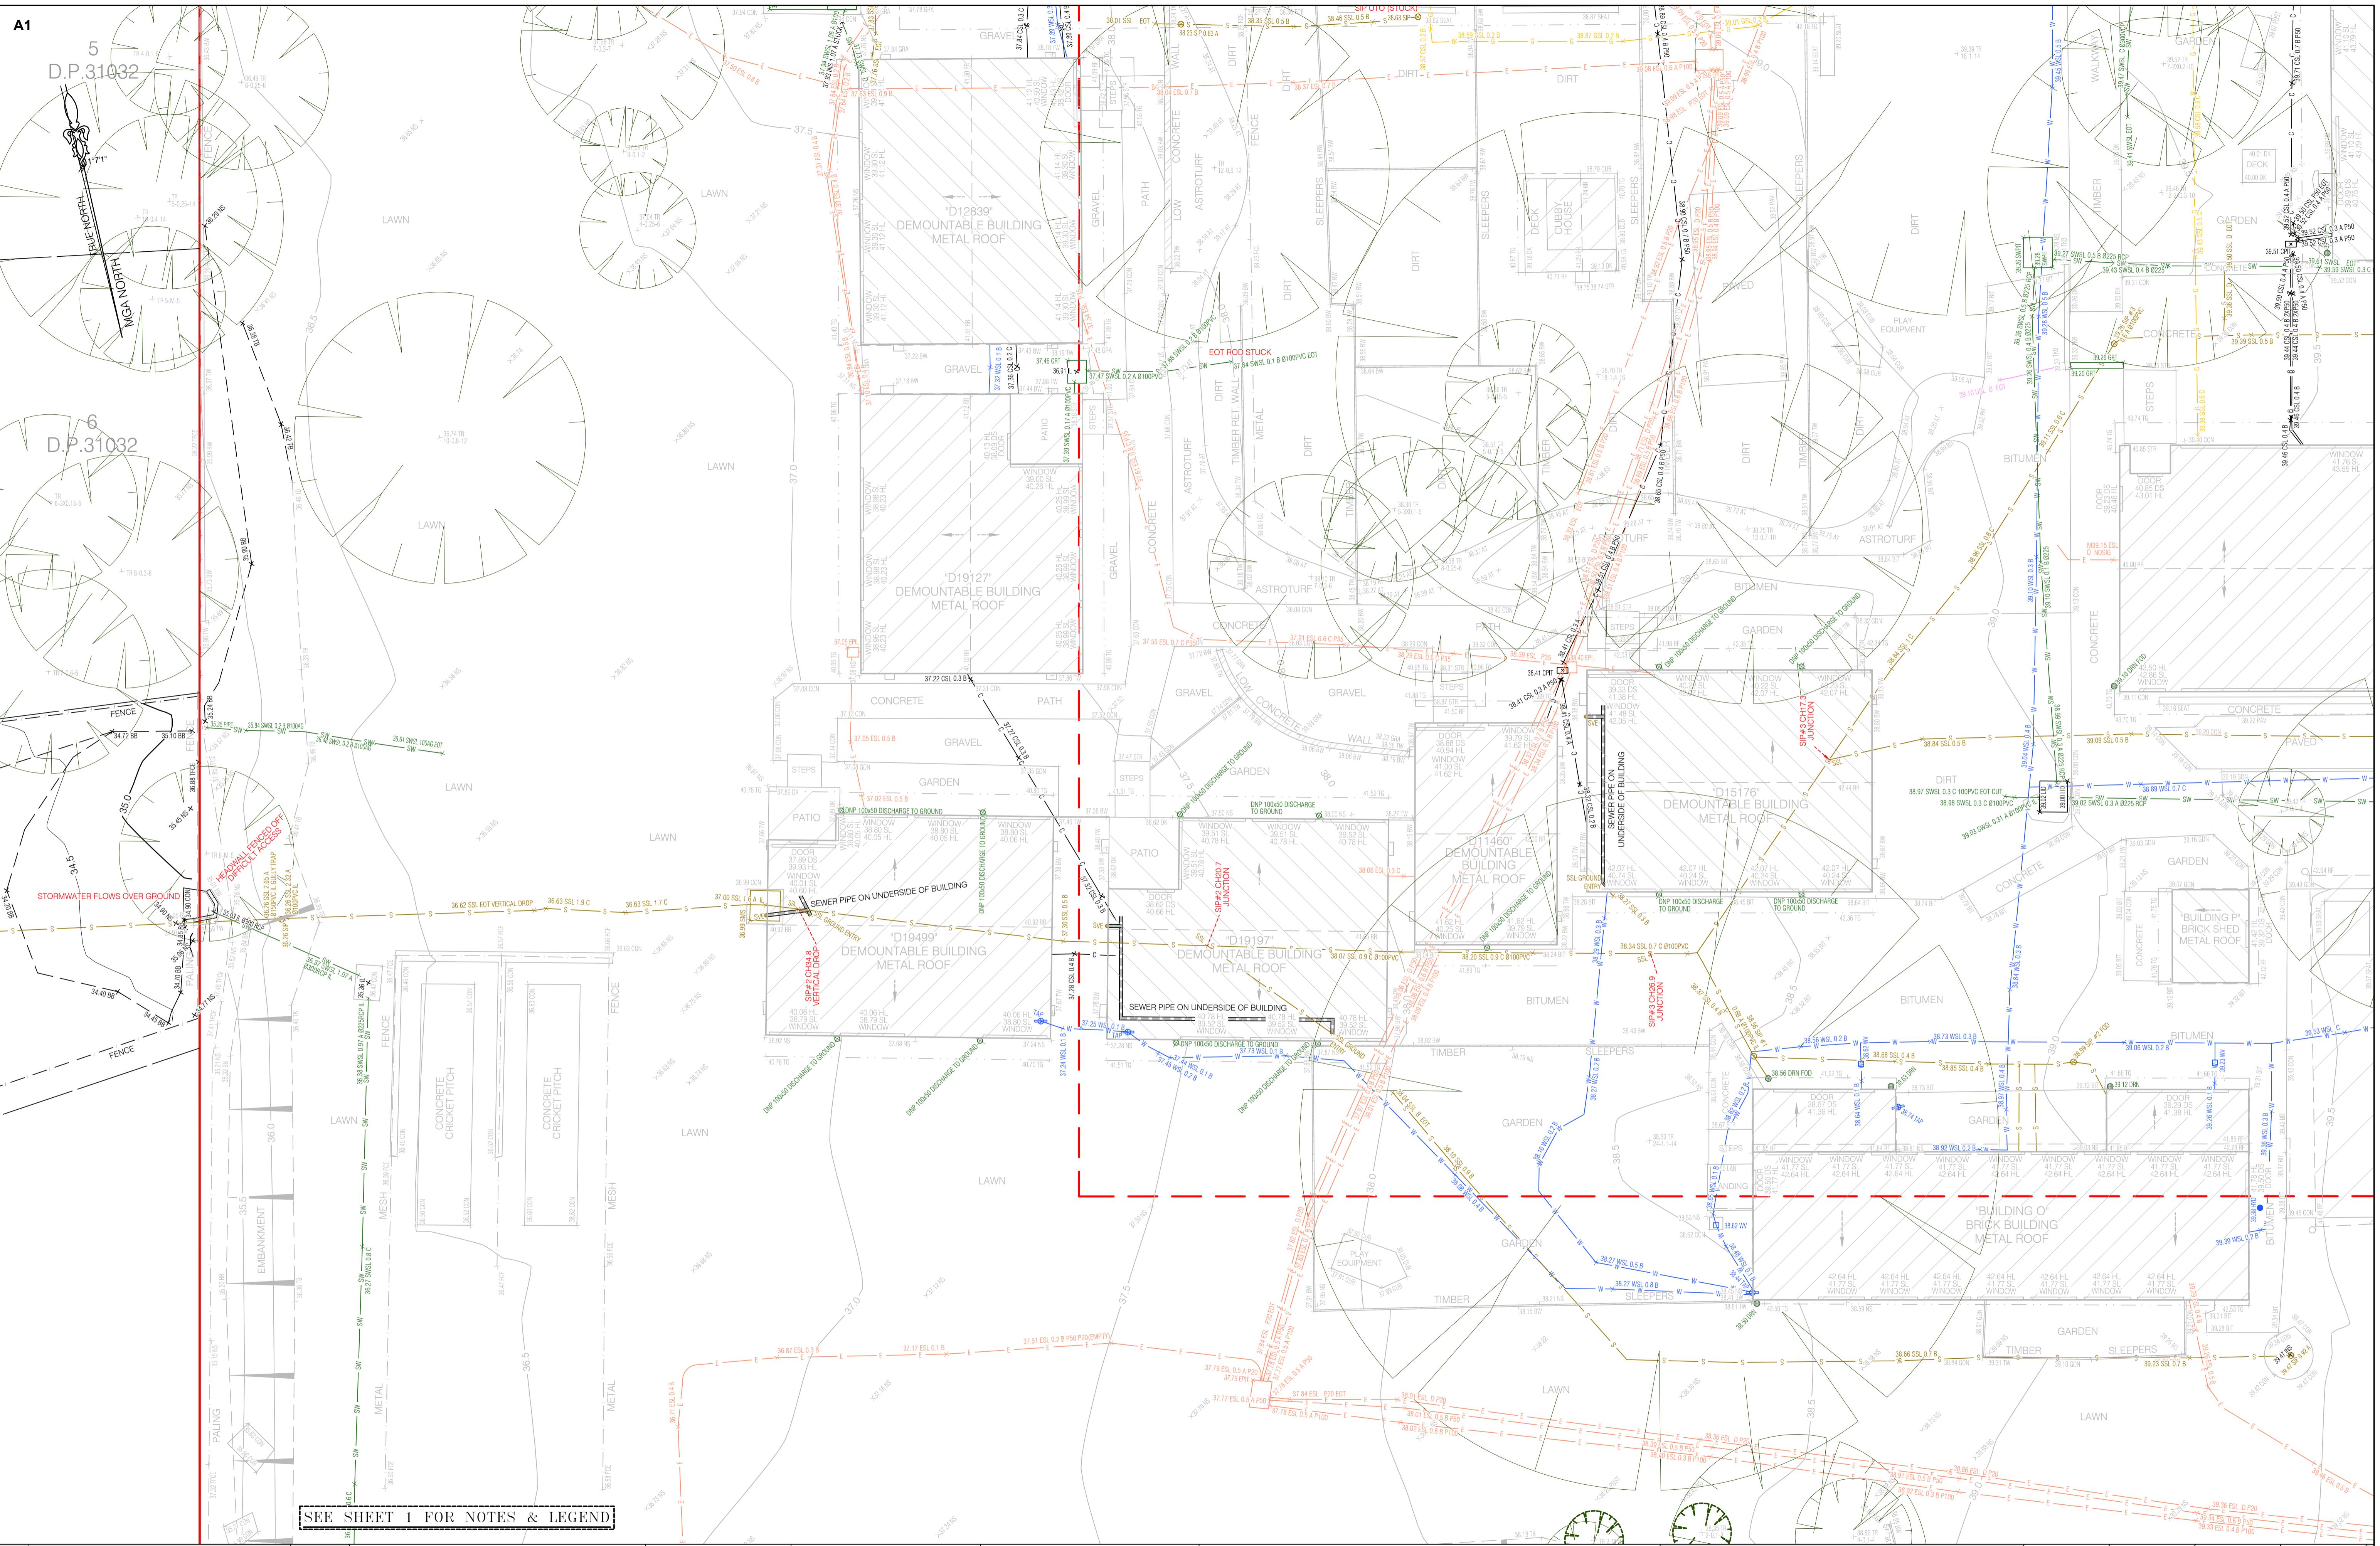

2 ADDITIONAL SERVICES & DETAIL ON LOT X DP31032 ADDED 12/11/2024

1 FIRST ISSUE 20/10/2023

HORIZONTAL DATUM:  
CO-ORDINATE SYSTEM: MGA 2020 (GROUND)  
MARKS ADOPTED: SSM 165787 & SSM 165850

VERTICAL DATUM:  
DATUM: AUSTRALIAN HEIGHT DATUM (AHD)  
B.M. ADOPTED: SSM 165787  
R.L. 44.972 (CLASS B)  
SOURCE: S.C.I.M.S. (18/08/2023)



Zero Damage - Zero Harm


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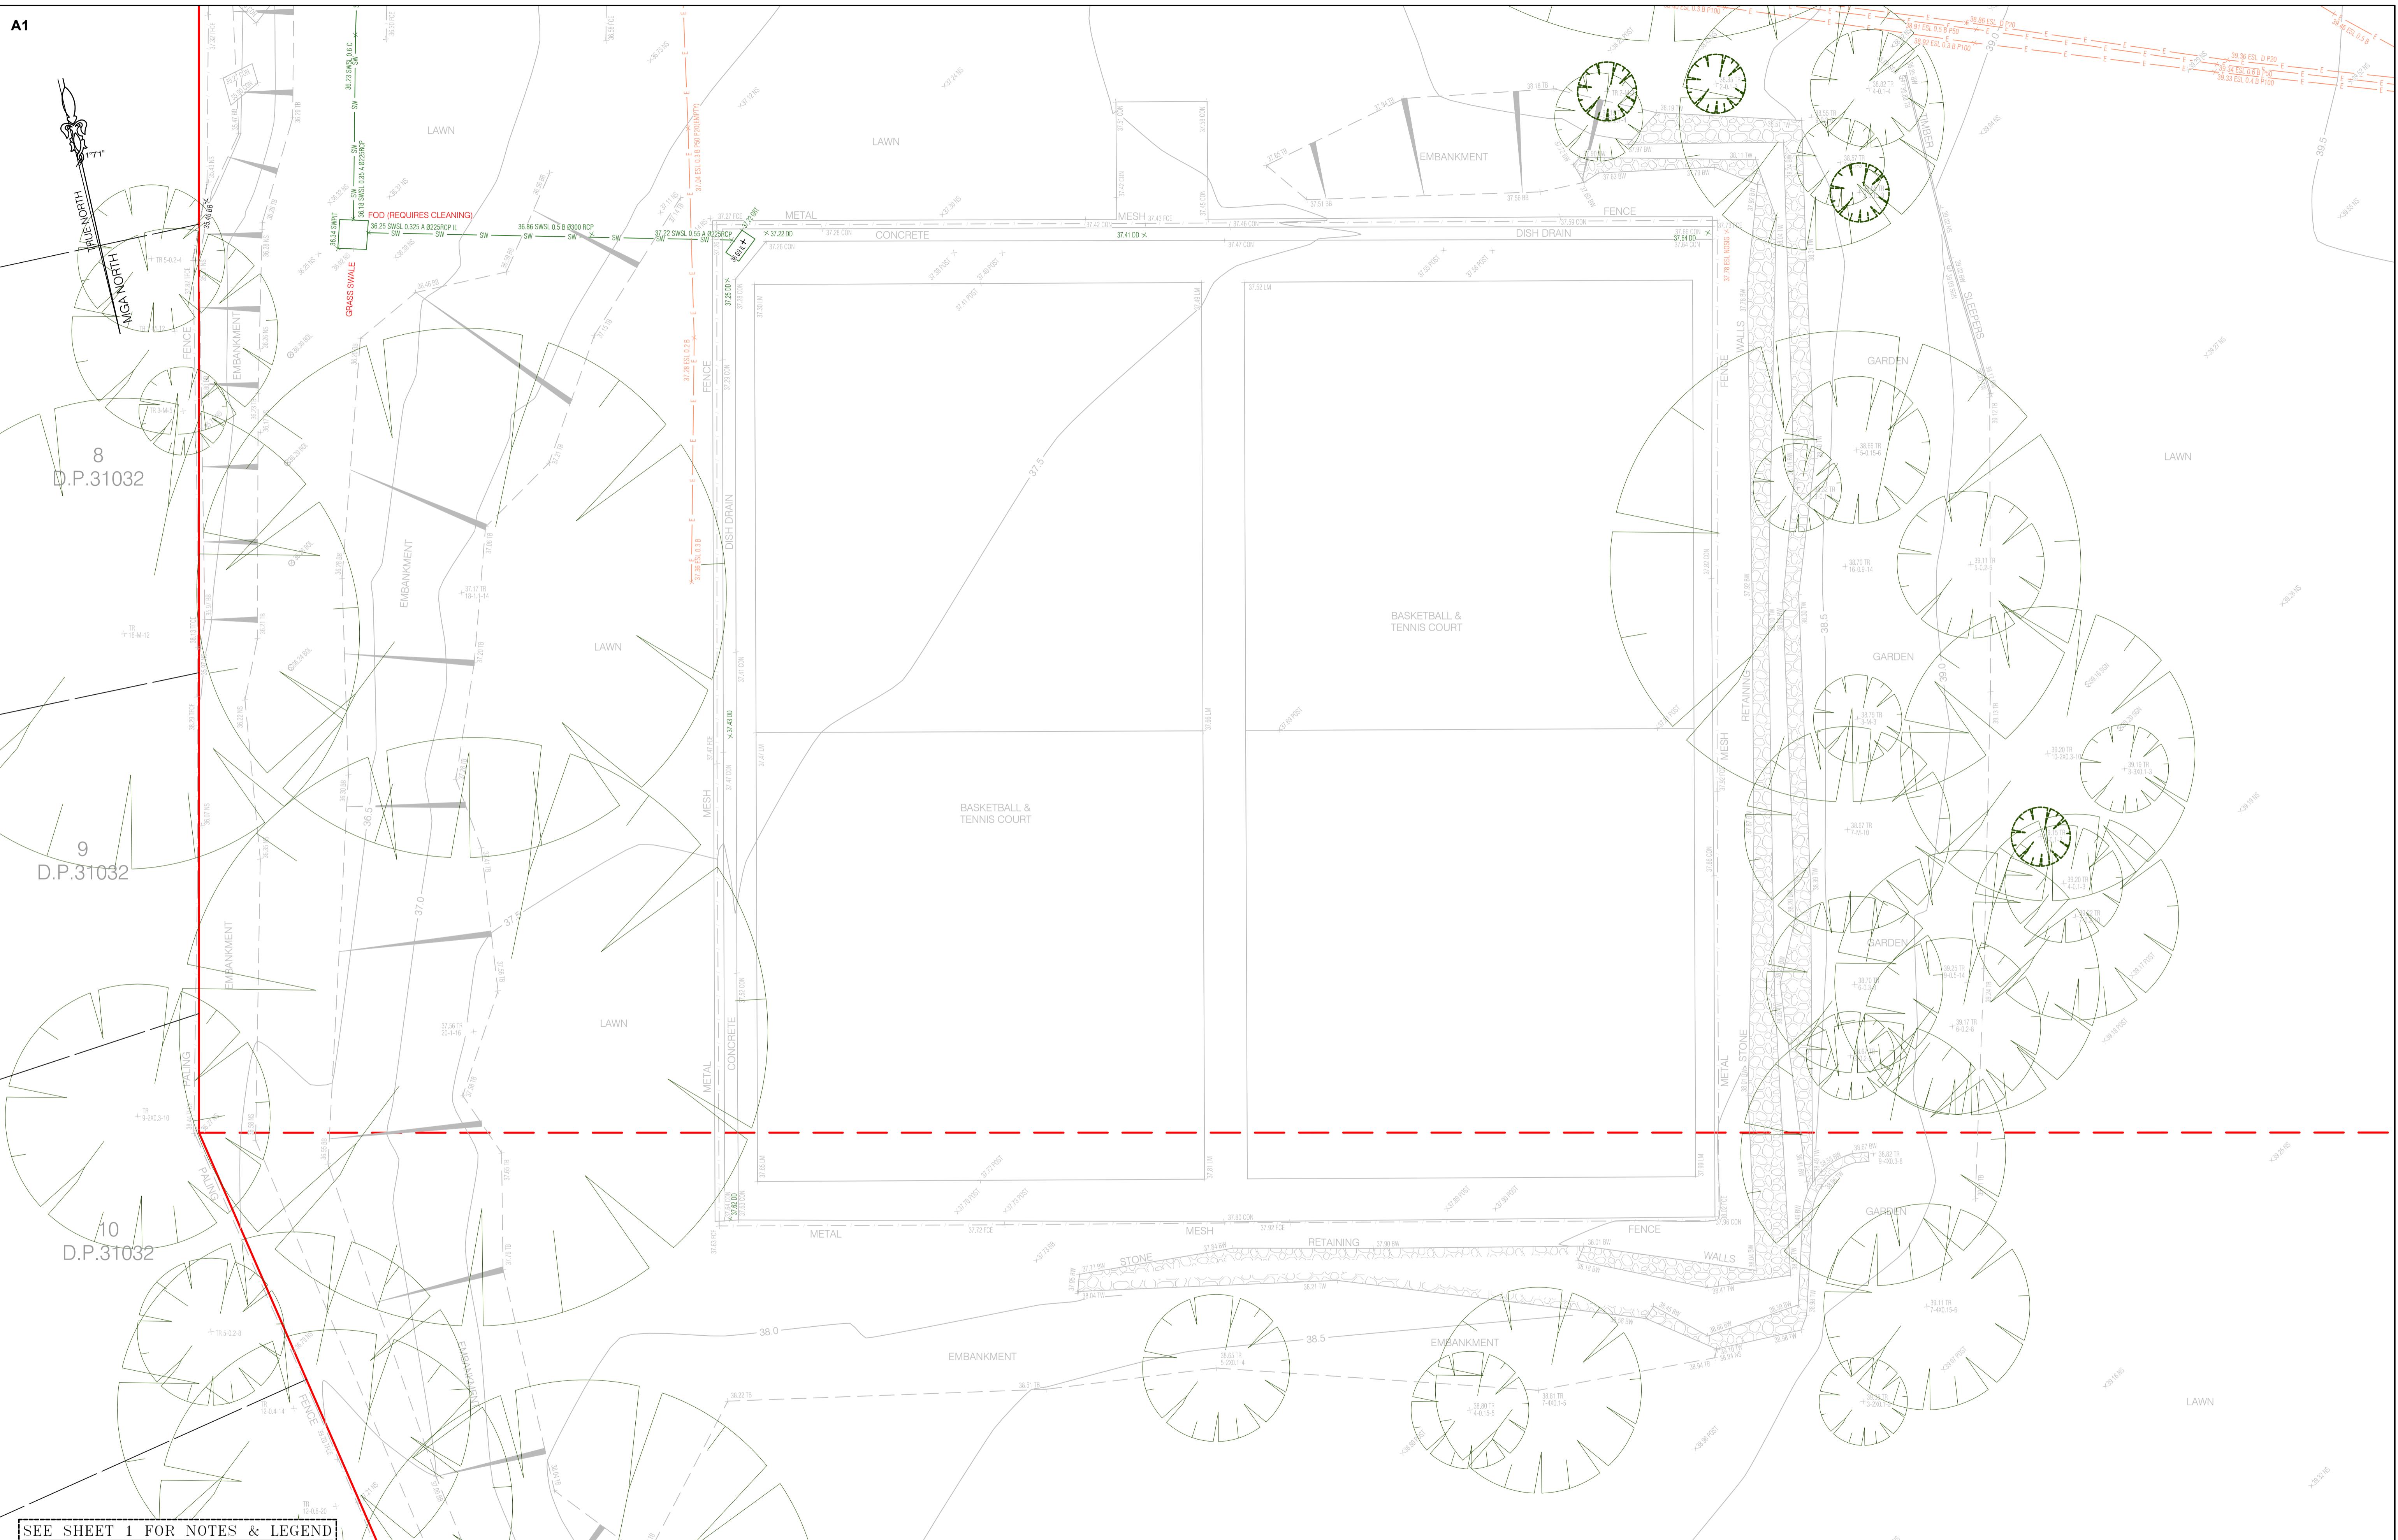
**CLIENT:**  
DEPARTMENT OF EDUCATION  
SCHOOL INFRASTRUCTURE NSW  
**LGA: CITY OF PARRAMATTA**

**PLAN SHOWING SURVEY OF UNDERGROUND SERVICES  
OVER OVER LOT 1 IN DP176742, LOT 1 DP20061, LOT 1  
DP209810 & LOT 1 IN DP366405  
No.52A MOXHAMS ROAD  
NORTHMEAD, NSW, 2152**

**CMS SURVEYORS PTY LTD**  
ACN 096 240 201  
PO Box 463, Dee Why, NSW, 2099  
2/99A South Creek Road, Dee Why, NSW, 2099  
(02) 9971 4802  
info@cmssurveyors.com.au  
www.cmssurveyors.com.au

SURVEYED BS/TH	DRAWN GP	CHECKED BS/TH	APPROVED RM
SURVEY INSTRUCTION 6482C	SCALE 1:100@A1	DATE OF SURVEY 25/8/2023 & 4/11/24	
DRAWING NAME 6482Service Northmead PS (2763)	CAD FILE 6482Service 2 Northmead PS (2763).dwg	SHEET 6 OF 14	ISSUE 2



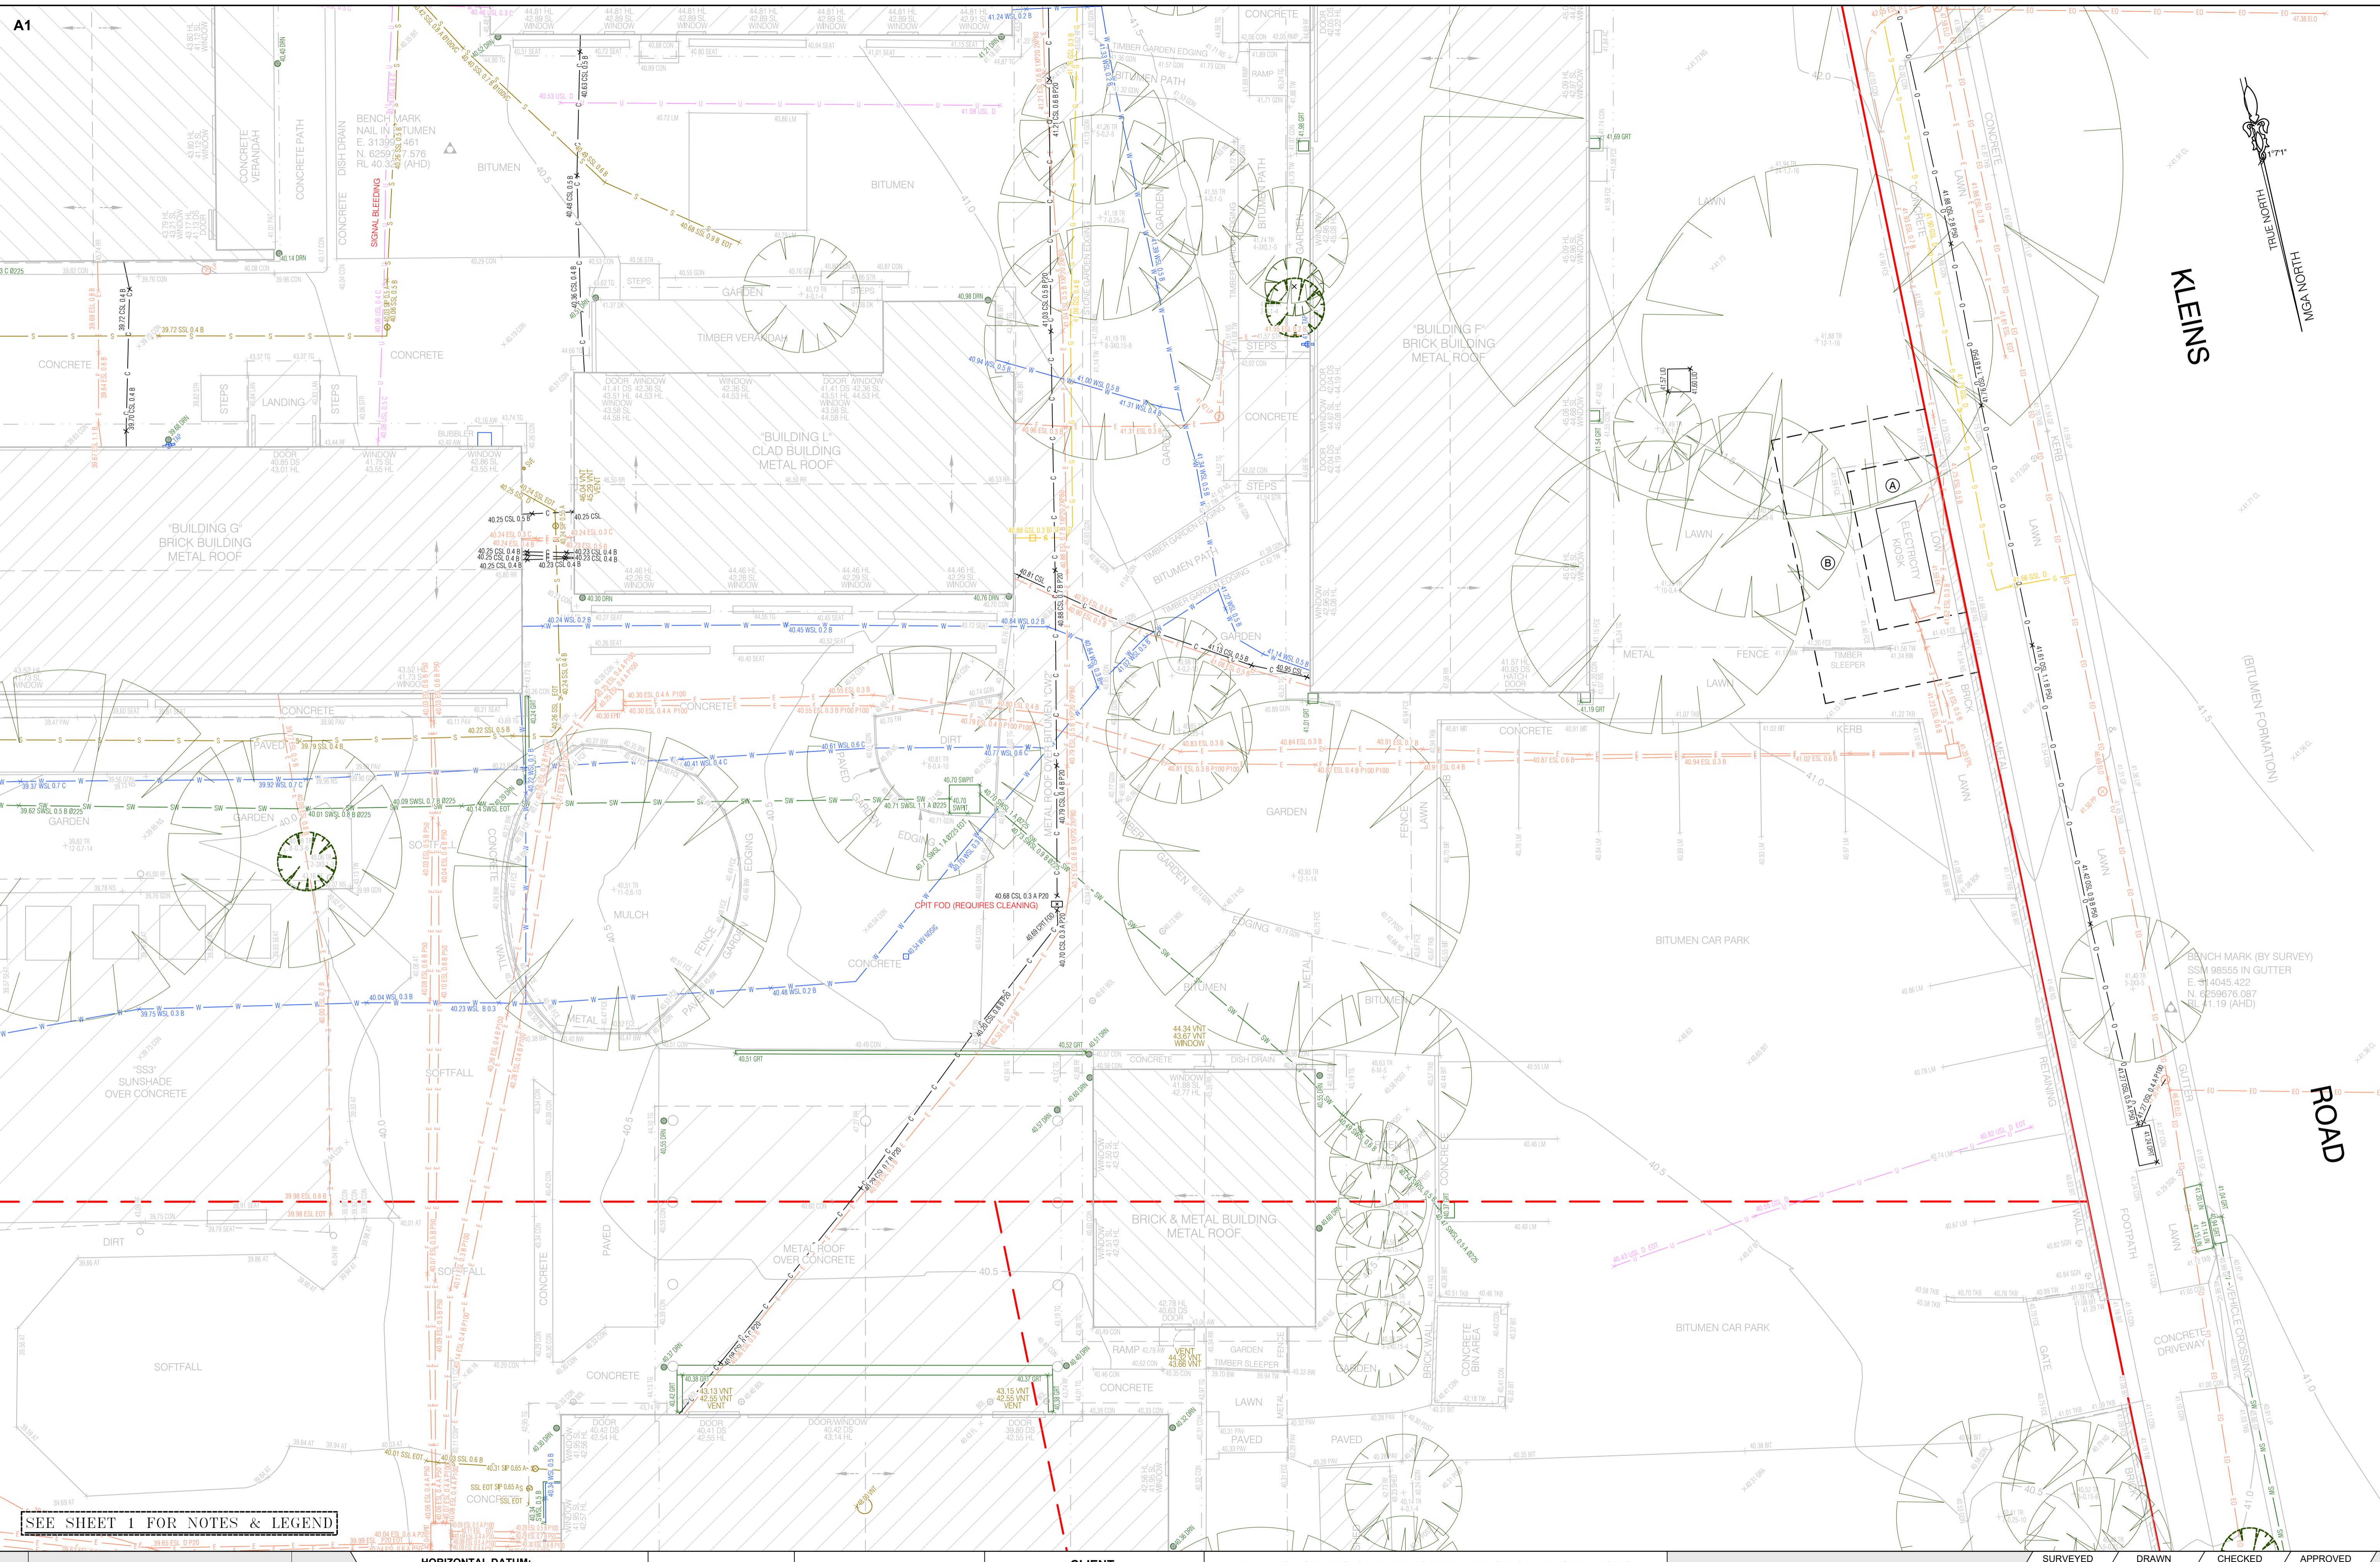

2	ADDITIONAL SERVICES & DETAIL ON LOT X DP31032 ADDED	12/11/2024
1	FIRST ISSUE	20/10/2023

**HORIZONTAL DATUM:**  
CO-ORDINATE SYSTEM: MGA 2020 (GROUND)  
MARKS ADOPTED: SSM 165787 & SSM 165850


**VERTICAL DATUM:**  
DATUM: AUSTRALIAN HEIGHT DATUM (AHD)  
B.M. ADOPTED: SSM 165787  
R.L. 44.972 (CLASS B)  
SOURCE: S.C.I.M.S. (18/08/2023)



0 1 2 3 4 5  
SCALE 1:100


**CLIENT:**  
DEPARTMENT OF EDUCATION  
SCHOOL INFRASTRUCTURE NSW

LGA: CITY OF PARRAMATTA

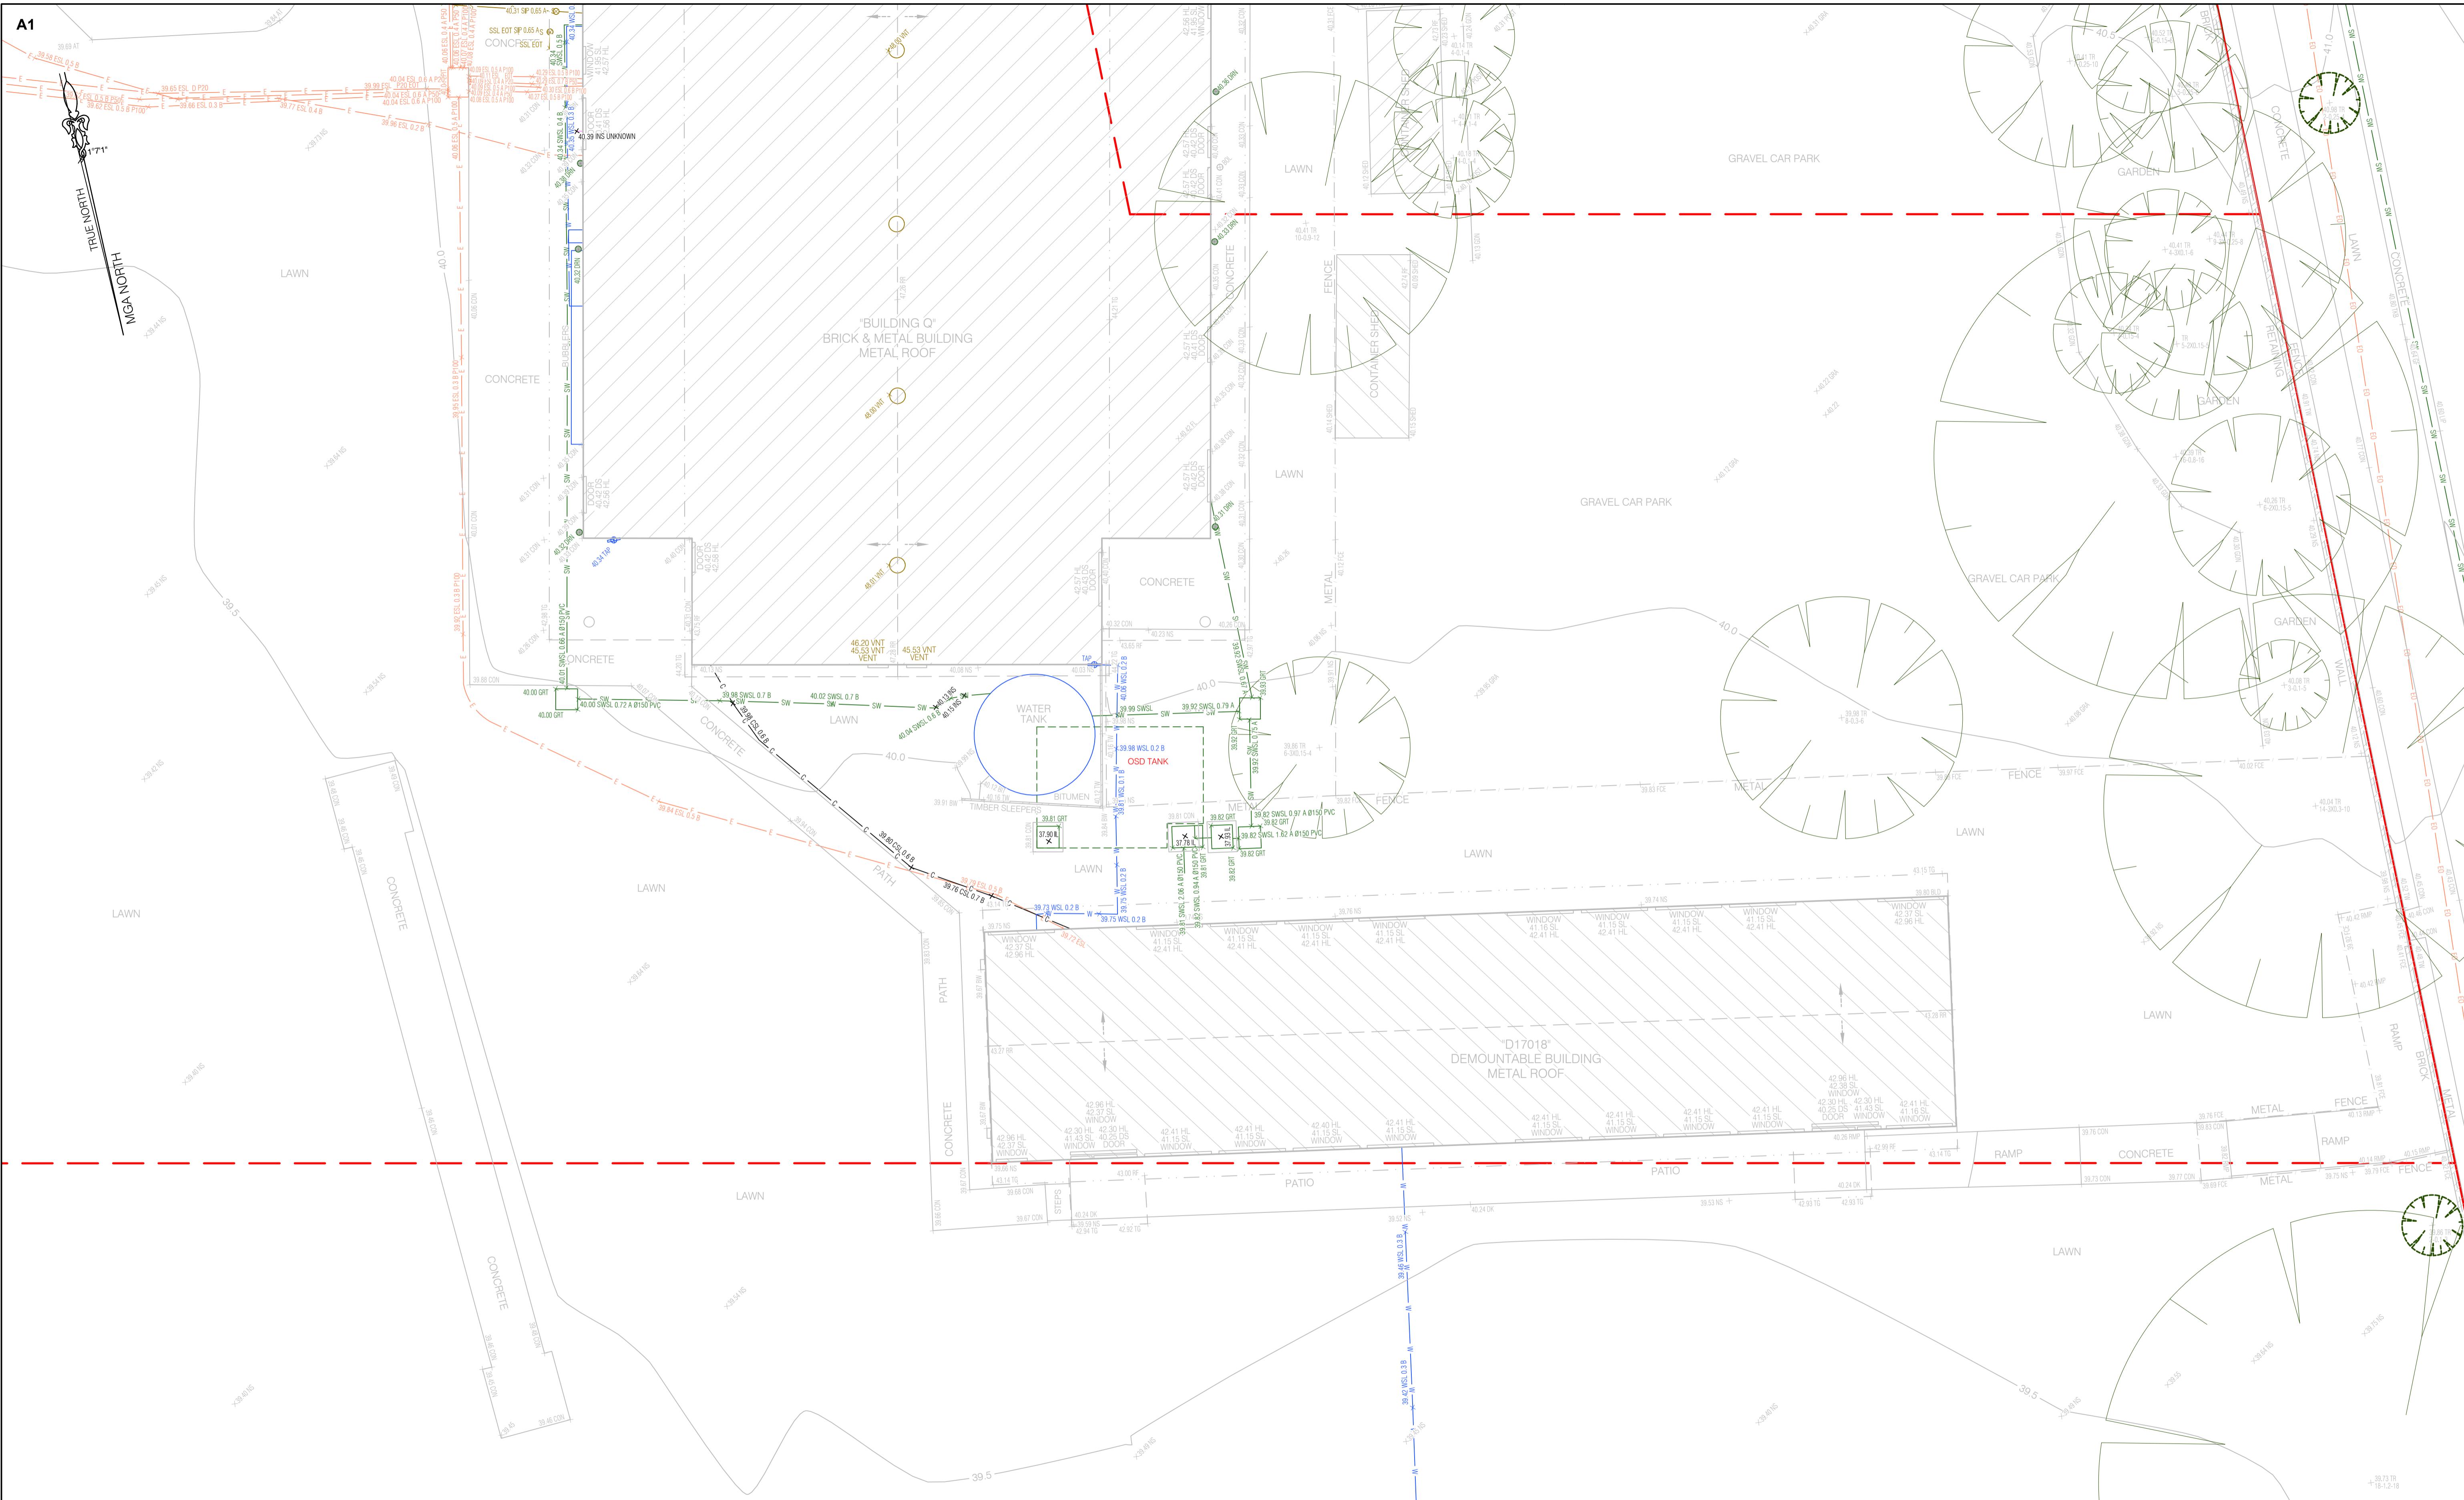

SEE SHEET 1 FOR NOTES & LEGEND

		<p><b>HORIZONTAL DATUM:</b> CO-ORDINATE SYSTEM: MGA 2020 (GROUND) MARKS ADOPTED: SSM 165787 &amp; SSM 165850</p> <p><b>VERTICAL DATUM:</b> DATUM: AUSTRALIAN HEIGHT DATUM (AHD) B.M. ADOPTED: SSM 165787</p> <p>2 ADDITIONAL SERVICES &amp; DETAIL ON LOT X DP31032 ADDED 12/11/2024 R.L. 44.972 (CLASS B) SOURCE: S.C.I.M.S. (18/08/2023)</p> <p>1 FIRST ISSUE 20/10/2023</p>	 <p>BEFORE YOU DIG www.bysa.com.au Zero Damage - Zero Harm</p>	 <p>CMS SURVEYORS PTY LTD ACN 096 240 201 PO Box 463 Dee Why, NSW, 2099 2/99A South Creek Road, Dee Why, NSW, 2099 ☎ (02) 9971 4802 ✉ info@cmssurveyors.com.au 🌐 www.cmssurveyors.com.au</p>	<p>0 1 2 3 4 5</p> <p>SCALE 1:100</p>	<p><b>CLIENT:</b> <b>DEPARTMENT OF EDUCATION SCHOOL INFRASTRUCTURE NSW</b></p> <p><b>PLAN SHOWING SURVEY OF UNDERGROUND SERVICES OVER OVER LOT 1 IN DP176742, LOT 1 DP20061, LOT 1 DP209810 &amp; LOT 1 IN DP366405 No.52A MOXHAMS ROAD NORTHMEAD, NSW, 2152</b></p> <p><b>LGA: CITY OF PARRAMATTA</b></p>	<p>SURVEYED BS/TH DRAWN GP CHECKED BS/TH APPROVED RM</p> <p>SURVEY INSTRUCTION 6482C SCALE 1:100@A1 DATE OF SURVEY 25-28/09/23 &amp; 4/11/24</p> <p>DRAWING NAME 6482Cservice Northmead PS (2763) SHEET 9 OF 14</p> <p>CAD FILE 6482Cservice 2 Northmead PS (2763).dwg</p>
2							2

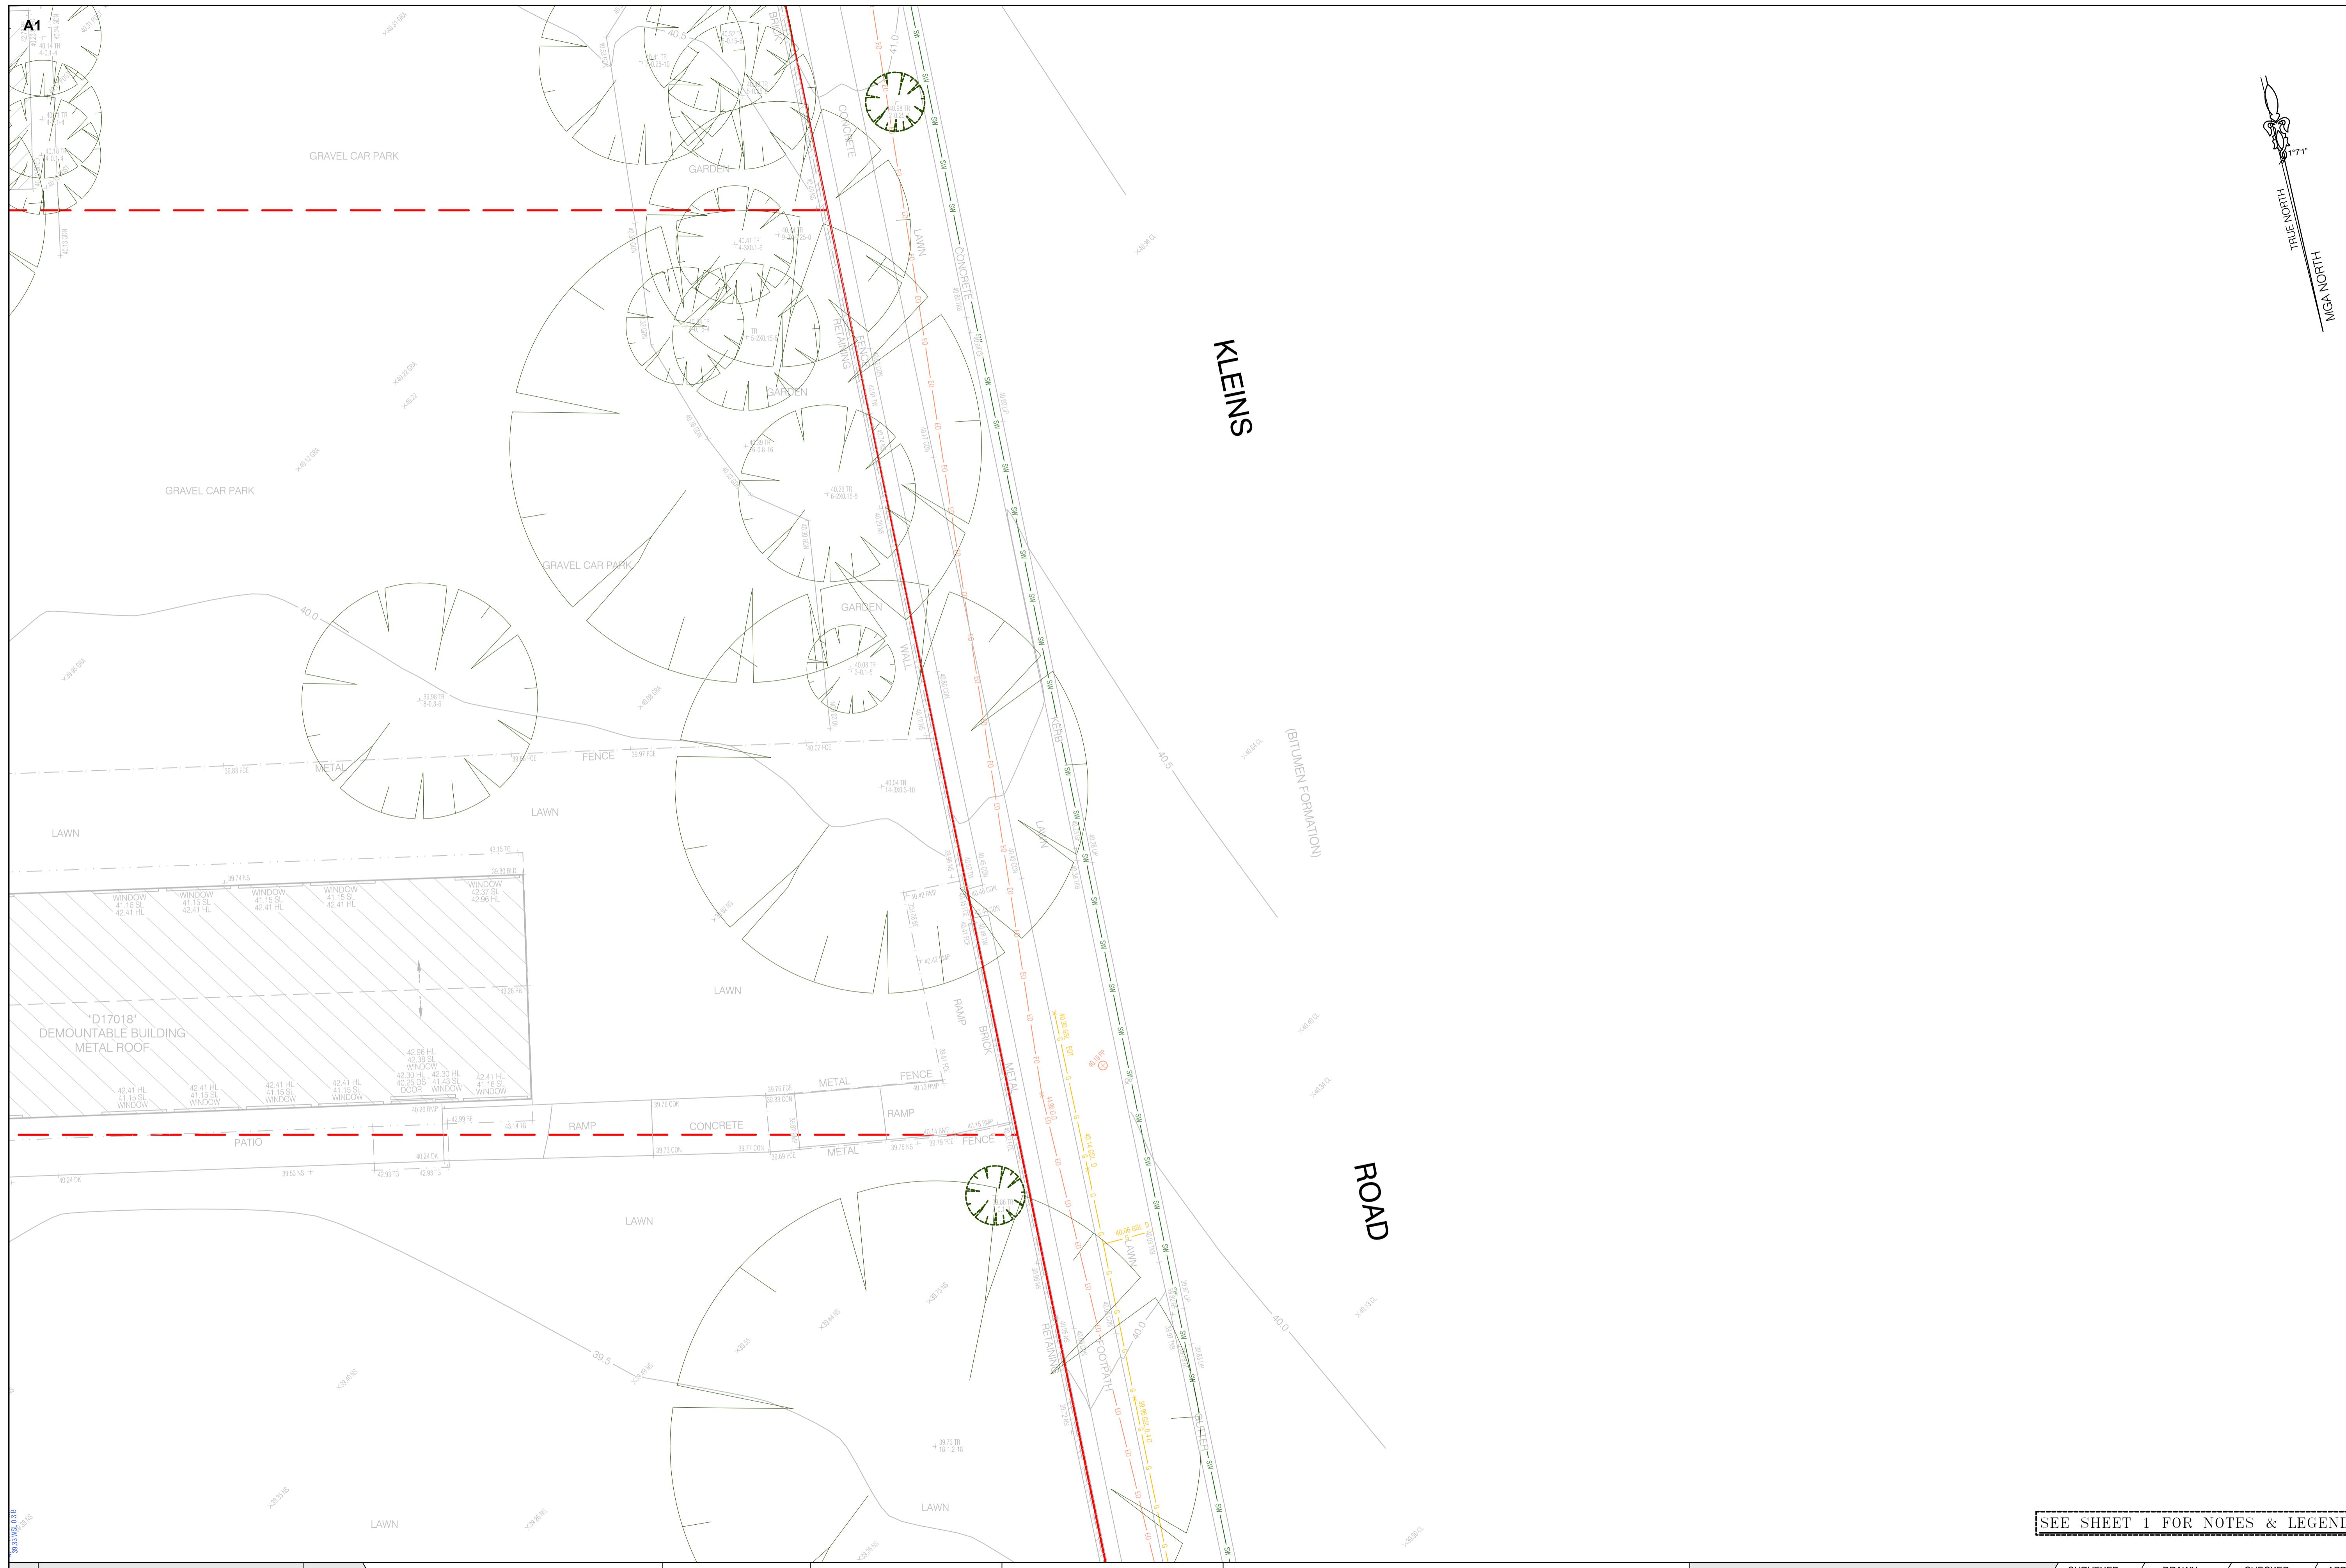

<b>2</b>	ADDITIONAL SERVICES & DETAIL ON LOT X DP31032 ADDED	12/11/2024
<b>1</b>	FIRST ISSUE	20/10/2023



**HORIZONTAL DATUM:**  
CO-ORDINATE SYSTEM: MGA 2020 (G)  
MARKS ADOPTED: SSM 165787 & SSM

**VERTICAL DATUM:**  
DATUM: AUSTRALIAN HEIGHT DATUM  
B.M. ADOPTED: SSM 165787

R.L. 44.972 (CLASS B)  
SOURCE: S.C.I.M.S. (18/08/2023)


CLIENT:  
DEPARTMENT OF EDUCATION  
SCHOOL INFRASTRUCTURE  
LGA: CITY OF PARRAMATTA

**PLAN SHOWING SURVEY OF UNDERGROUND SERVICES  
OVER OVER LOT 1 IN DP176742, LOT 1 DP20061, LOT 1  
DP209810 & LOT 1 IN DP366405  
No.52A MOXHAMS ROAD  
NORTHMEAD, NSW, 2152**



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 [www.cmssurveyors.com.au](http://www.cmssurveyors.com.au)

SEE SHEET 1 FOR NOTES & LEGEND			
SURVEYED BS/TH	DRAWN GP	CHECKED BS/TH	APPROVED RM
SURVEY INSTRUCTION 6482C	SCALE 1:100@A1	DATE OF SURVEY 25-28/09/23 & 4/11/24	
DRAWING NAME	<b>6482Cservice Northmead PS (2763)</b>		SHEET
FILE	6482Cservice 2 Northmead PS (2763).dwg		10 OF 14
			<b>2</b>

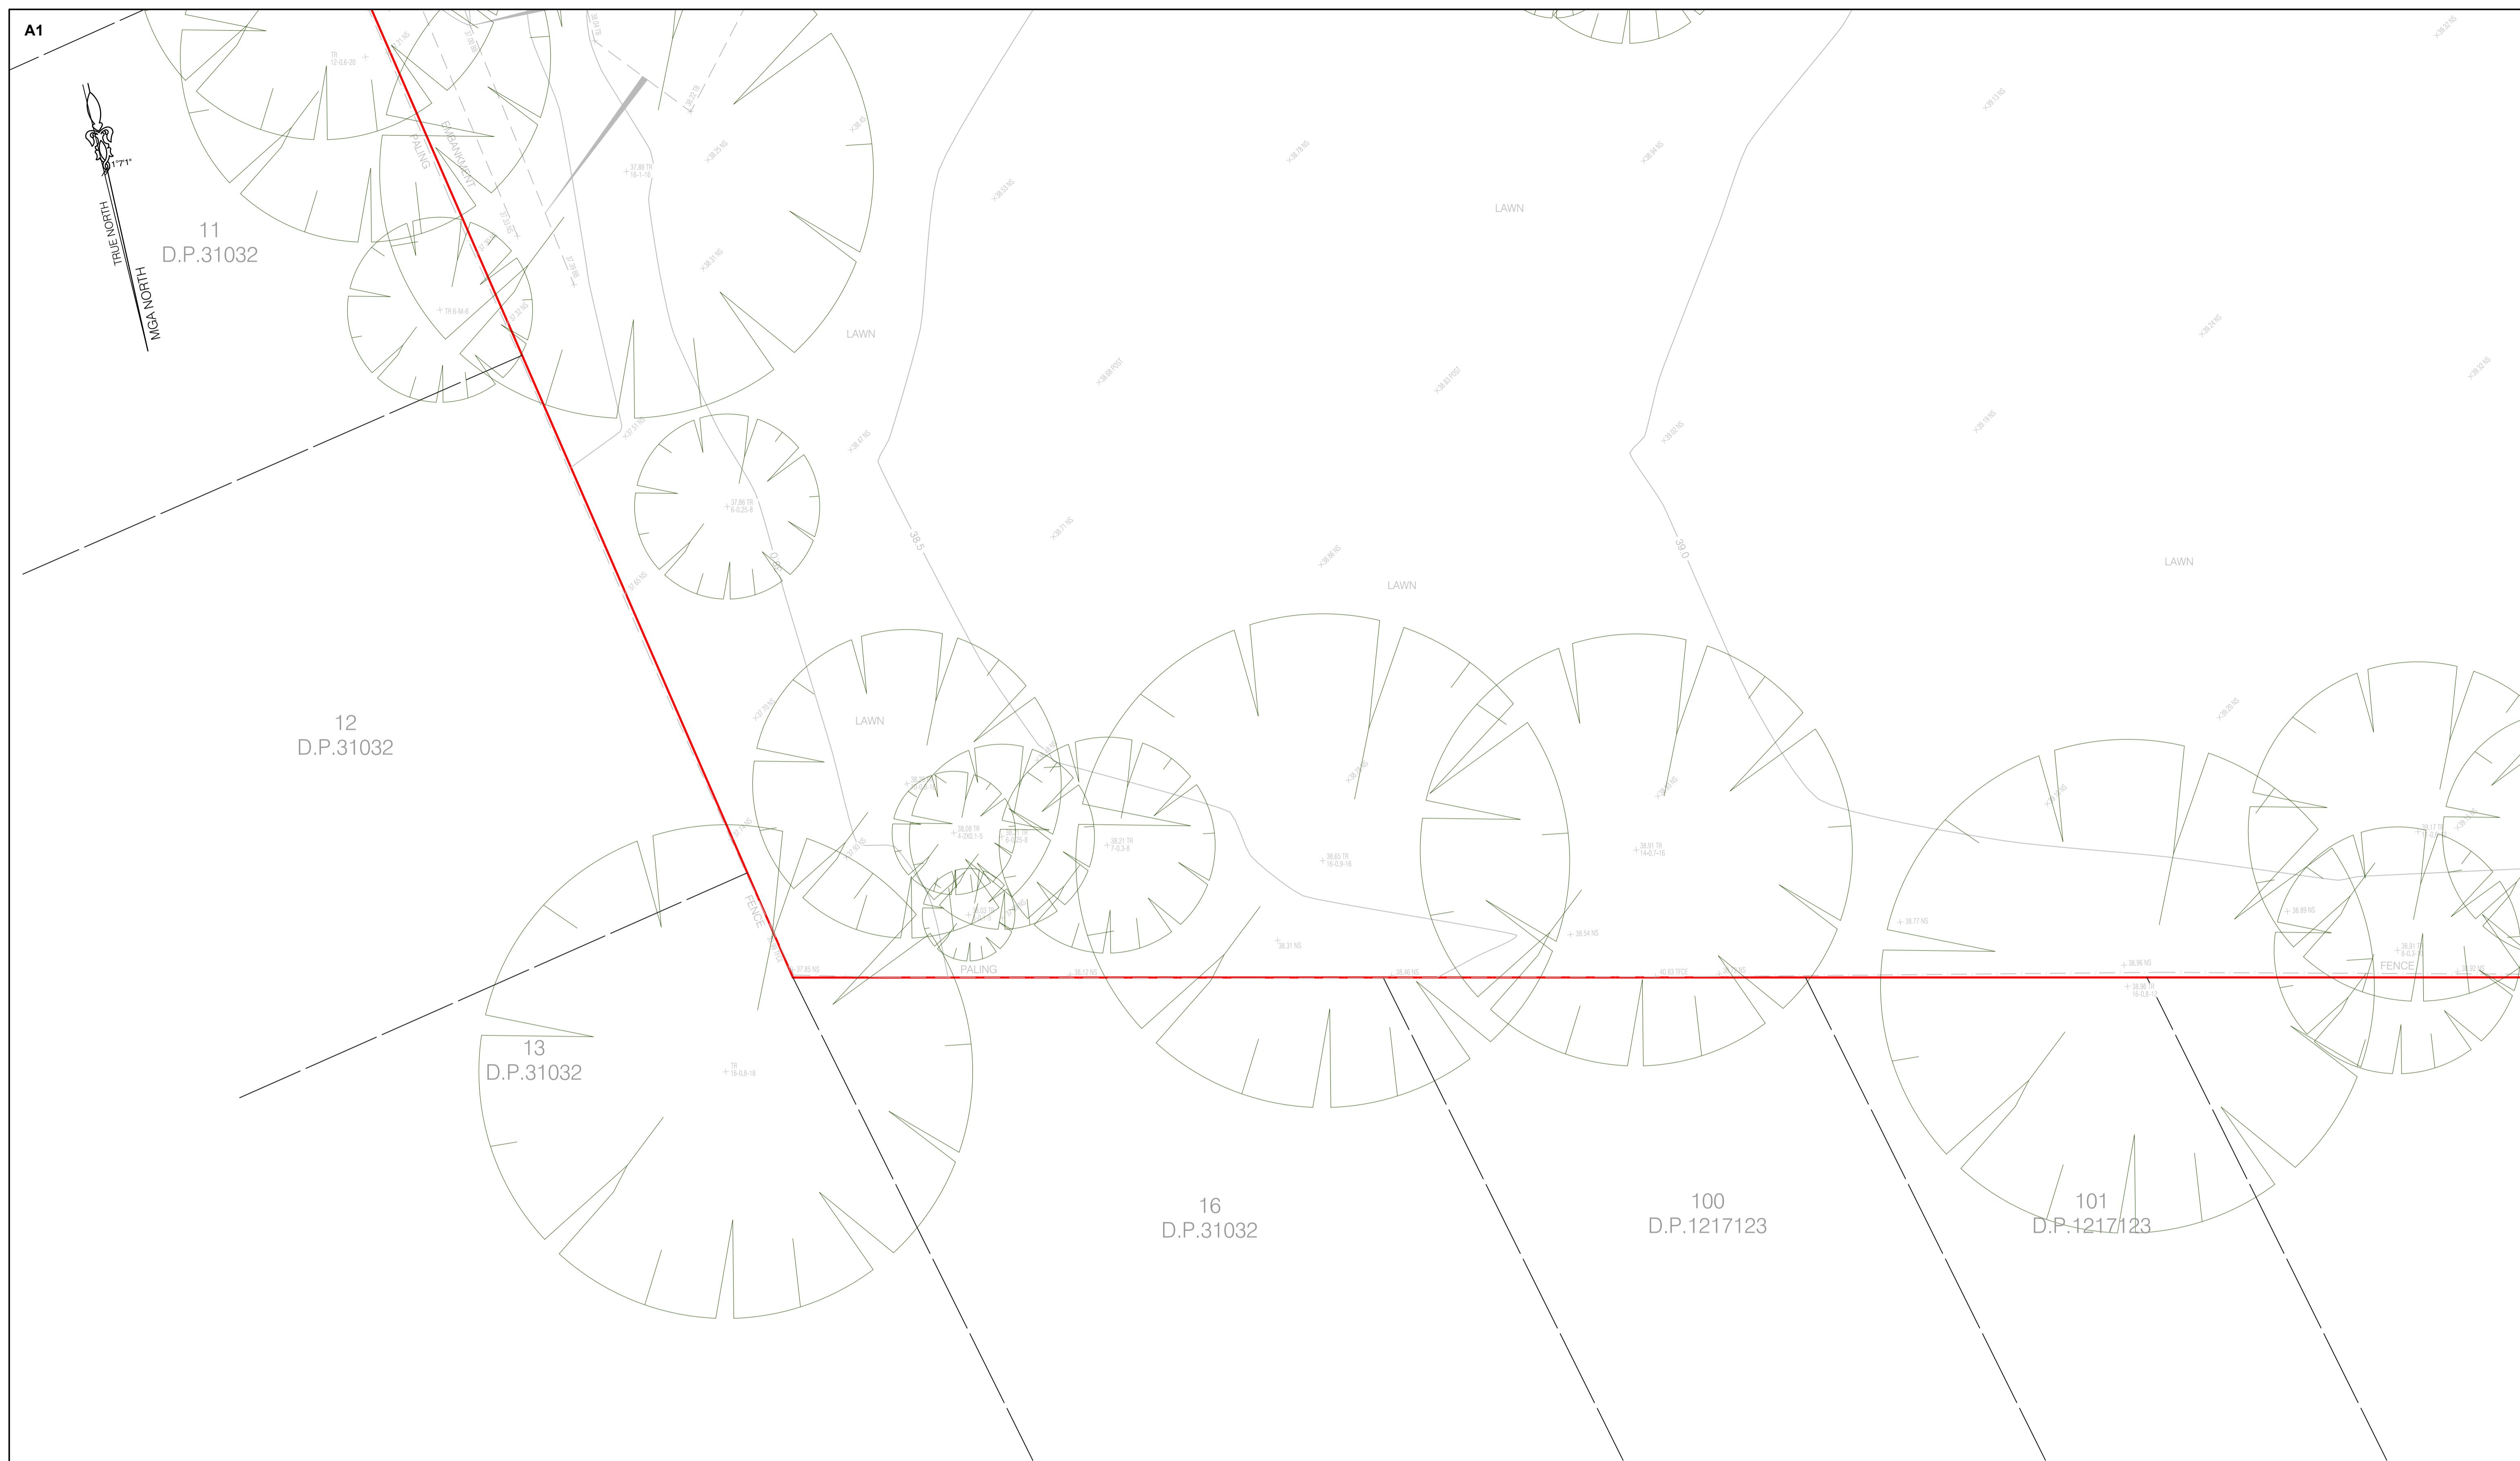

SEE SHEET 1 FOR NOTES & LEGEND


			<b>HORIZONTAL DATUM:</b> CO-ORDINATE SYSTEM: MGA 2020 (GROUND) <b>MARKS ADOPTED:</b> SSM 165787 & SSM 165850   <b>VERTICAL DATUM:</b> DATUM: AUSTRALIAN HEIGHT DATUM (AHD) <b>B.M. ADOPTED:</b> SSM 165787 R.L. 44.972 (CLASS B) <b>SOURCE:</b> S.C.I.M.S. (18/08/2023)	<b>CLIENT:</b> <b>DEPARTMENT OF EDUCATION</b> <b>SCHOOL INFRASTRUCTURE NSW</b>   <b>CMS SURVEYORS PTY LTD</b> ACN 096 240 201 PO Box 463 Dee Why, NSW, 2099 2/99A South Creek Road, Dee Why, NSW, 2099  (02) 9971 4802  info@cmssurveyors.com.au  www.cmssurveyors.com.au	<b>SURVEYED</b> BS/TH  <b>DRAWN</b> GP  <b>CHECKED</b> BS/TH  <b>APPROVED</b> RM	
		<b>PLAN SHOWING SURVEY OF UNDERGROUND SERVICES</b> <b>OVER OVER LOT 1 IN DP176742, LOT 1 DP20061, LOT 1</b> <b>DP209810 &amp; LOT 1 IN DP366405</b> <b>No.52A MOXHAMS ROAD</b> <b>NORTHMEAD, NSW, 2152</b>				
2	ADDITIONAL SERVICES & DETAIL ON LOT X DP31032 ADDED	12/11/2024		<b>SURVEY INSTRUCTION</b> 6482C <b>SCALE</b> 1:100@A1  <b>DRAWING NAME</b> <b>6482Cservice Northmead PS (2763)</b> <b>SCALE 1:100</b>	<b>DATE OF SURVEY</b> 25-28/09/23 & 4/11/24  <b> SHEET</b> 11 OF 14	<b>ISSUE</b> <b>2</b>
1	FIRST ISSUE	20/10/2023				

A1



SEE SHEET 1 FOR NOTES & LEGEND

		HORIZONTAL DATUM: CO-ORDINATE SYSTEM: MGA 2020 (GROUND) MARKS ADOPTED: SSM 165787 & SSM 165850  VERTICAL DATUM: DATUM: AUSTRALIAN HEIGHT DATUM (AHD) B.M. ADOPTED: SSM 165787 R.L. 44.972 (CLASS B) SOURCE: S.C.I.M.S. (18/08/2023)		0 1 2 3 4 5 SCALE 1:100	CLIENT: <b>DEPARTMENT OF EDUCATION SCHOOL INFRASTRUCTURE NSW</b>	<b>PLAN SHOWING SURVEY OF UNDERGROUND SERVICES OVER LOT 1 IN DP176742, LOT 1 DP20061, LOT 1 DP209810 &amp; LOT 1 IN DP366405 No.52A MOXHAMS ROAD NORTHMEAD, NSW, 2152</b>	SURVEYED BS/TH DRAWN GP CHECKED BS/TH APPROVED RM  SURVEY INSTRUCTION 6482C SCALE 1:100@A1 DATE OF SURVEY 25-28/09/23 & 4/11/24  DRAWING NAME <b>6482Cservice Northmead PS (2763)</b> SHEET 12 OF 14  CAD FILE <b>6482Cservice 2 Northmead PS (2763).dwg</b>
2	ADDITIONAL SERVICES & DETAIL ON LOT X DP31032 ADDED	12/11/2024	CMS SURVEYORS PTY LTD ACN 096 240 201 PO Box 463 Dee Why, NSW, 2099 2/99A South Creek Road, Dee Why, NSW, 2099 Tel (02) 9971 4802 Email info@cmssurveyors.com.au Website www.cmssurveyors.com.au				
1	FIRST ISSUE	20/10/2023					

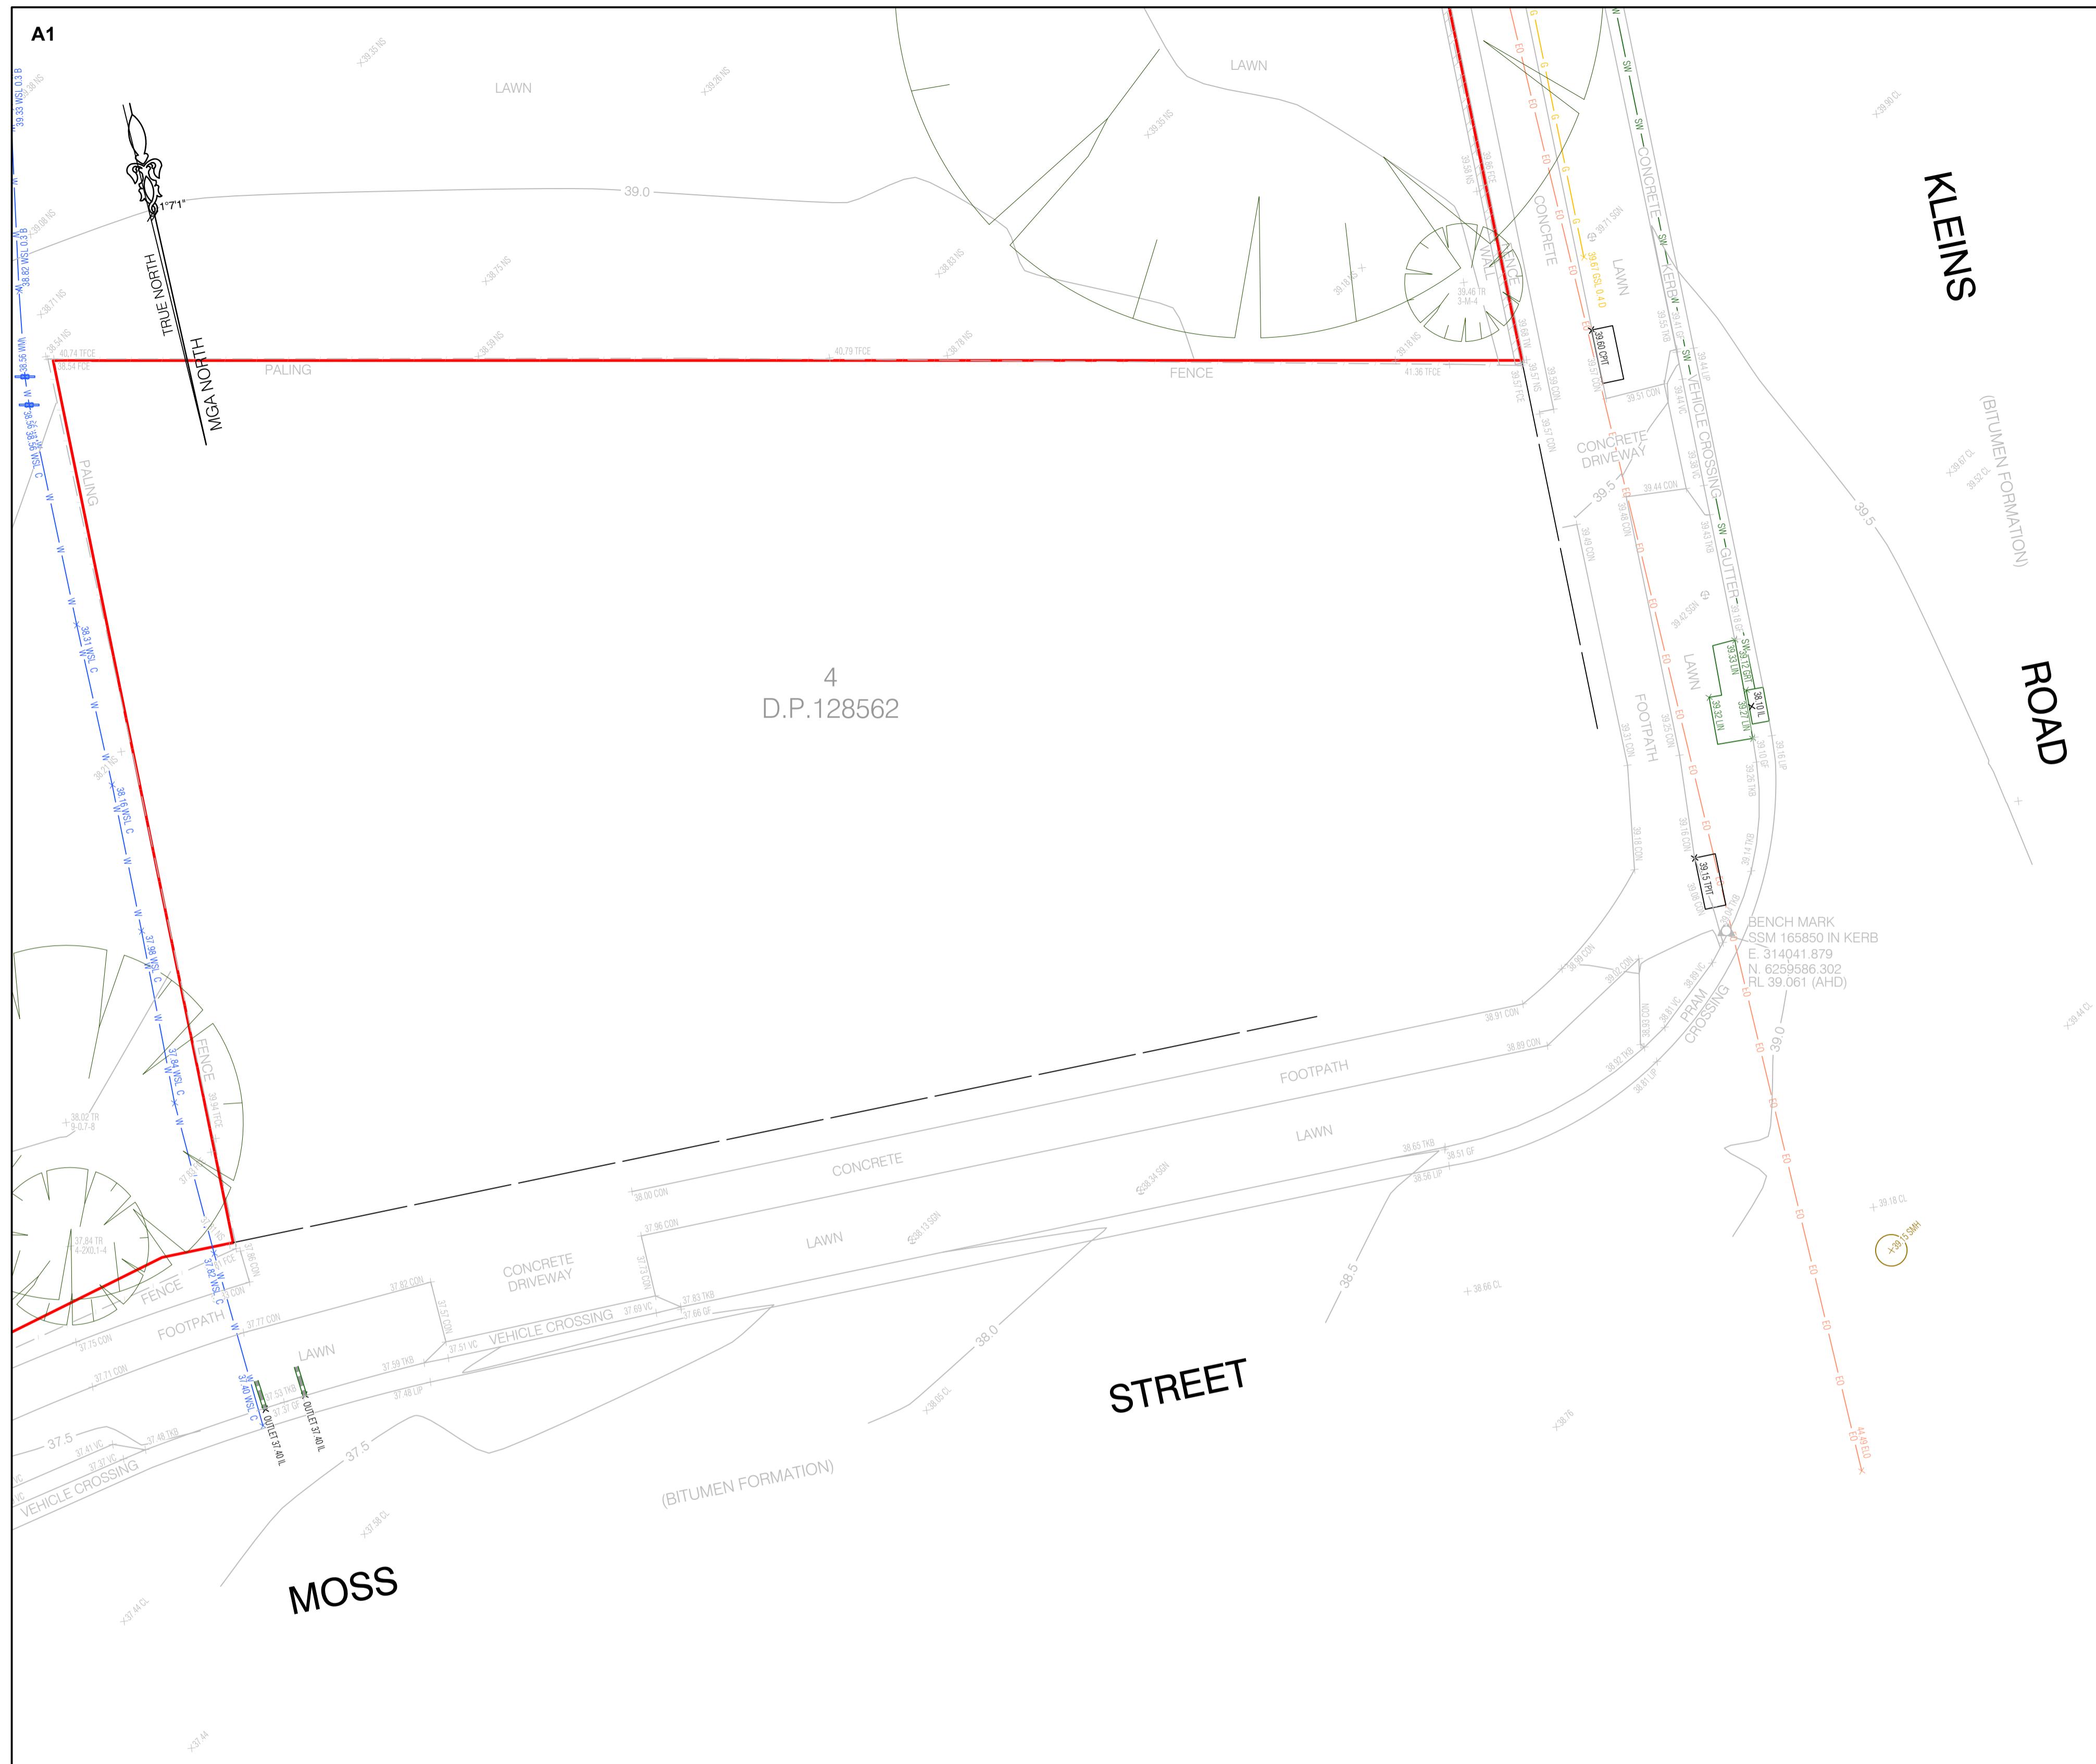

SEE SHEET 1 FOR NOTES & LEGEND

		<p><b>HORIZONTAL DATUM:</b> CO-ORDINATE SYSTEM: MGA 2020 (GROUND) MARKS ADOPTED: SSM 165787 &amp; SSM 165850</p> <p><b>VERTICAL DATUM:</b> DATUM: AUSTRALIAN HEIGHT DATUM (AHD) B.M. ADOPTED: SSM 165787 R.L. 44.972 (CLASS B) SOURCE: S.C.I.M.S. (18/08/2023)</p>		 <p><b>CLIENT:</b> <b>DEPARTMENT OF EDUCATION</b> <b>SCHOOL INFRASTRUCTURE NSW</b></p> <p><b>PLAN SHOWING SURVEY OF UNDERGROUND SERVICES</b> <b>OVER LOT 1 IN DP176742, LOT 1 DP20061, LOT 1</b> <b>DP209810 &amp; LOT 1 IN DP366405</b> <b>No.52A MOXHAMS ROAD</b> <b>NORTHMEAD, NSW, 2152</b></p> <p><b>CMS SURVEYORS PTY LTD</b> ACN 096 240 201 PO Box 463 Dee Why, NSW, 2099 2/99A South Creek Road, Dee Why, NSW, 2099 (02) 9971 4802 info@cmssurveyors.com.au www.cmssurveyors.com.au</p> <p><b>SURVEYED BS/TH</b> <b>DRAWN GP</b> <b>CHECKED BS/TH</b> <b>APPROVED RM</b></p> <p><b>SURVEY INSTRUCTION</b> <b>SCALE</b> <b>DATE OF SURVEY</b></p> <p>6482C 1:100@A1 25-28/09/23 &amp; 4/11/24</p> <p><b>DRAWING NAME</b> <b>6482Cservice Northmead PS (2763)</b> <b>SHEET</b></p> <p>13 OF 14</p> <p><b>CAD FILE</b> 6482Cservice 2 Northmead PS (2763).dwg</p>
2	ADDITIONAL SERVICES & DETAIL ON LOT X DP31032 ADDED	12/11/2024		
1	FIRST ISSUE	20/10/2023		

A1

CONCRETE

ALLAMBIE

AVENUE

MGA NORTH

771°

TRUE NORTH

6  
D.P.31032X  
D.P.310322  
D.P.8108658  
D.P.31032

SEE SHEET 1 FOR NOTES &amp; LEGEND

**HORIZONTAL DATUM:**  
CO-ORDINATE SYSTEM: MGA 2020 (GROUND)  
MARKS ADOPTED: SSM 165787 & SSM 165850

**VERTICAL DATUM:**  
DATUM: AUSTRALIAN HEIGHT DATUM (AHD)  
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R.L. 44.972 (CLASS B)  
SOURCE: S.C.I.M.S. (18/08/2023)

0 1 2 3 4 5  
SCALE 1:100

**CLIENT:**  
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SCHOOL INFRASTRUCTURE NSW

LGA: CITY OF PARRAMATTA

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SURVEYED BS/TH	DRAWN GP	CHECKED BS/TH	APPROVED RM
SURVEY INSTRUCTION 6482C	SCALE 1:100@A1	DATE OF SURVEY 25/09/23 & 4/11/24	
DRAWING NAME 6482Cservice Northmead PS (2763)	sheet 14 OF 14	ISSUE 2	
CAD FILE 6482Cservice 2 Northmead PS (2763).dwg			

2 ADDITIONAL SERVICES &amp; DETAIL ON LOT X DP31032 ADDED 12/11/2024

1 FIRST ISSUE 20/10/2023

## Appendix B – Architectural Plans

# NORTHMEAD PUBLIC SCHOOL

## FOR SCHOOL INFRASTRUCTURE NSW

7068ND01

			Drawing Name	Rev
NPS FTA XX	XX	DR A 0000	COVER SHEET + DRAWING LIST	04
NPS FTA XX	XX	DR A 0001	SPECIFICATIONS SCHEDULE & MATERIAL SELECTIONS	03
NPS FTA 00	00	DR A 1001	EXISTING SITE PLAN	04
NPS FTA 00	00	DR A 1002	DEMOLITION PLAN	03
NPS FTA 00	00	DR A 1003	SITE ANALYSIS PLAN	03
NPS FTA 00	00	DR A 1101	PROPOSED SITE PLAN	04
NPS FTA 00	00	DR A 1201	SITE SECTIONS	02
NPS FTA 00	00	DR A 1401	EXTERNAL WORKS PLAN	03
NPS FTA 00	00	DR A 1402	PROPOSED COVERED WALKWAY	02
NPS FTA 00	00	DR A 1403	PROPOSED COVERED WALKWAY - ROOF	02
NPS FTA 00	00	DR A 1501	PROPOSED STAGING PLAN 01	03
NPS FTA 00	00	DR A 1502	PROPOSED STAGING PLAN 02	03
NPS FTA 00	00	DR A 1503	PROPOSED STAGING PLAN 03	03
NPS FTA 00	00	DR A 1601	PLAYSCAPE CALCULATION	02
NPS FTA 00	00	DR A 1602	AMENITIES STRATEGY	02
NPS FTA 00	00	DR A 1603	ACCESS STRATEGY	01
NPS FTA 00	00	DR A 1604	TREE REMOVAL PLAN	02
NPS FTA 00	00	DR A 1610	INDIGENOUS ARTWORK STRATEGY	03
NPS FTA 00	00	DR A 1630	EXTERNAL MATERIAL AND FINISHES	03
NPS FTA 00	00	DR A 1640	SHADOW DIAGRAMS	02
NPS FTA 00	00	DR A 1650	CONSTRUCTION MANAGEMENT STRATEGY	01
NPS FTA B00A	GF	DR A 2100	BUILDING A - EXISTING GROUND FLOOR PLAN	04
NPS FTA B00A	GF	DR A 2101	BUILDING A - PROPOSED GROUND FLOOR PLAN	03
NPS FTA B00R	GF	DR A 2101	BUILDING R - EXISTING AND PROPOSED GROUND FLOOR PLAN	04
NPS FTA B00T	GF	DR A 2101	BUILDING T - GROUND FLOOR PLAN	04
NPS FTA B00T	LR	DR A 2102	BUILDING T - ROOF PLAN	04
NPS FTA B00T	GF	DR A 2201	BUILDING T - GROUND FLOOR RCP	04
NPS FTA B00T	ZZ	DR A 3201	BUILDING T - ELEVATIONS	04
NPS FTA B00T	ZZ	DR A 3202	BUILDING T - ELEVATIONS	04
NPS FTA B00T	ZZ	DR A 3303	BUILDING T - SECTIONS	04
NPS FTA B00T	ZZ	DR A 4001	BUILDING T - WALL TYPE DETAILS / PARTITION DETAILS	04
NPS FTA B00T	ZZ	DR A 4201	BUILDING T - WALL SECTIONS 01	04
NPS FTA B00T	ZZ	DR A 4202	BUILDING T - WALL SECTIONS 02	04
NPS FTA B00T	ZZ	DR A 4401	BUILDING T - STAIR AND RAMP DETAILS	02
NPS FTA B00T	ZZ	DR A 4501	BALUSTRADE AND HANDRAIL DETAILS	02
NPS FTA B00T	ZZ	DR A 4801	COVERED WALKWAY DETAILS	03
NPS FTA B00T	ZZ	DR A 4901	TYPICAL FASCIA DETAILS	03
NPS FTA B00A	ZZ	DR A 5001	BUILDING A - TECH HUB / PRINCIPAL ROOM	02
NPS FTA B00A	ZZ	DR A 5002	BUILDING A - DEPUTY PRINCIPAL / AP OFFICE	02
NPS FTA B00A	ZZ	DR A 5003	BUILDING A - STAFF ROOM	02
NPS FTA B00T	ZZ	DR A 6001	EXTERNAL DOOR & WINDOW SCHEDULE	03
NPS FTA B00T	ZZ	DR A 6002	INTERNAL DOOR & WINDOW SCHEDULE	03
NPS FTA B00T	ZZ	DR A 9001	BUILDING T - PERSPECTIVES 1	03
NPS FTA B00T	ZZ	DR A 9002	BUILDING T - PERSPECTIVES 2	03





**1 PERSPECTIVES  
3D VIEW 03**



**2 PERSPECTIVES  
3D VIEW 04**

150mm @ A1

100

50

50

100

150mm @ A1

03	100% SCHEMATIC DESIGN	19/12/2024	NK	
02	95% SCHEMATIC DESIGN	19/12/2024	AK	
01	80% SCHEMATIC DESIGN	26/11/2024	AK	

REV. DESCRIPTION DATE INIT.

**fulton trotter**  
ARCHITECTS BRISBANE SYDNEY  
[www.fultontrotter.com.au](http://www.fultontrotter.com.au)

**SYDNEY** Suite 904, Level 9, 2-38 Forrester Street, Surry Hills, NSW 2010  
1 (02) 8383 5151 e. [sydney@fultontrotter.com.au](mailto:sydney@fultontrotter.com.au)

Fulton Trotter Architects ACN 677 264 559 ABN 57 677 264 559  
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	Justine Ebrey ria	NSW 8371	QLD 5313
	John Ward ria	NSW 8371	QLD 3847
	Karen Dimopoulos ria	NSW 7434	QLD 4529
	Paul Suttor ria	NSW 7780	QLD 3168
	Ryan Lovelady ria	NSW 7780	QLD 4500

PROJECT NUMBER: **7068ND01** DIRECTOR: **JW**  
DRAWING NUMBER: **NPS-FTA-B00T-ZZ-DR-A-9002** CHECKED: **03**  
REVISION: **03**

PHASE: **SCHEMATIC DESIGN**  
PROJECT: **SCHOOL INFRASTRUCTURE NSW**  
CLIENT: **NORTHMEAD PUBLIC SCHOOL**  
ADDRESS: **MOXHAMS ROAD, NORTHMEAD, NSW**

Figured dimensions take precedence over scale dimensions. Contractors must verify all dimensions on site before commencing any work or making shop drawings.

PROJECT NUMBER: **7068ND01** DIRECTOR: **JW**  
DRAWING NUMBER: **NPS-FTA-B00T-ZZ-DR-A-9002** CHECKED: **03**  
REVISION: **03**



1 PERSPECTIVES  
3D VIEW 01



2 PERSPECTIVES  
3D VIEW 02

150mm @ A1

100

50







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plot date: Thursday, 19 December 2024 2:47 PM file location: BIMcloud: FTA-SYD-BIM26 - BIMcloud Basic for Archicad 26/7068ND01 Northmead Public School

REV.	DESCRIPTION	DATE	INIT.	
03	100% SCHEMATIC DESIGN	19/12/2024	NK	
02	95% SCHEMATIC DESIGN	10/12/2024	AK	
01		26/11/2024		
P2	100% CONCEPT DESIGN	31/10/2024	NK	
P1	80% CONCEPT DESIGN	18/10/2024	AK	

**fulton trotter**  
ARCHITECTS BRISBANE SYDNEY  
[www.fultontrotter.com.au](http://www.fultontrotter.com.au)  
SYDNEY Suite 904, Level 9, 2-38 Forrester Street, Surry Hills, NSW 2010  
T (02) 8383 5151 E [a.sydney@fultontrotter.com.au](mailto:a.sydney@fultontrotter.com.au)  
Fulton Trotter Architects ACN 677 264 550 ABN 57 677 264 550  
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James Ebrey riai Paul Sutcliffe riai NSW 8371 QLD 3313  
John Ward riai Karen Dimopoulos riai NSW 7434 QLD 4520  
Paul Sutcliffe riai Paul Sutcliffe riai NSW 7780 QLD 42168  
Ryan Lovelady riai Ryan Lovelady riai NSW 7780 QLD 4500

PHASE  
PROJECT CLIENT  
**SCHEMATIC DESIGN**  
SCHOOL INFRASTRUCTURE  
NSW  
NORTHMEAD PUBLIC SCHOOL  
MOXHAMS ROAD,  
NORTHMEAD, NSW

Figured dimensions take precedence over  
scale dimensions. Contractors must verify  
all dimensions on site before commencing  
any work or making shop drawings.  
PROJECT NUMBER DIRECTOR  
**7068ND01** **JW** CHECKED  
DRAWING NUMBER  
**NPS-FTA-B00T-ZZ-DR-A-9001** **03** REVISION

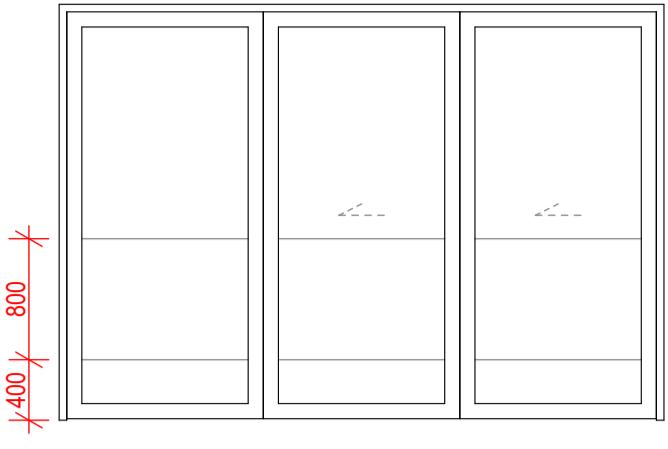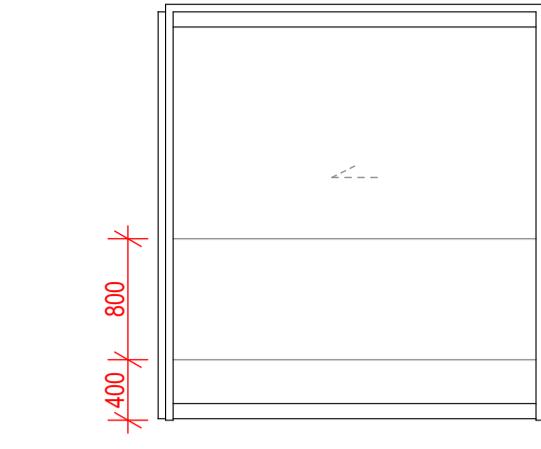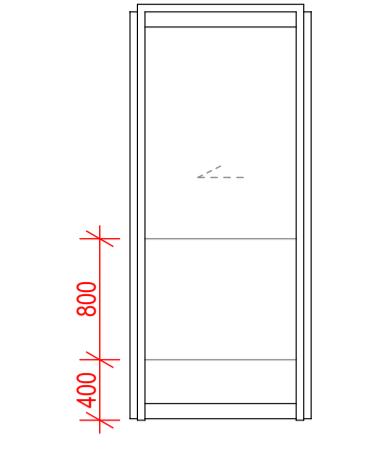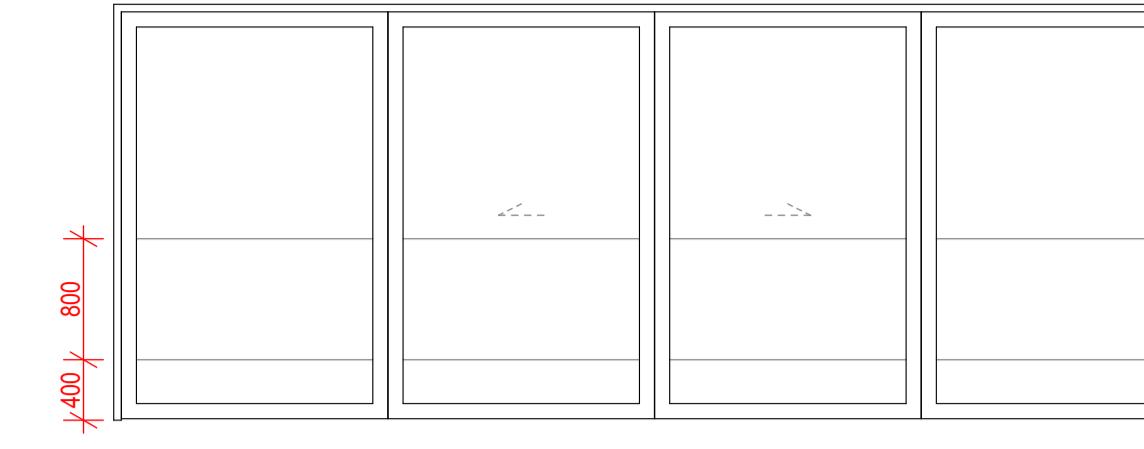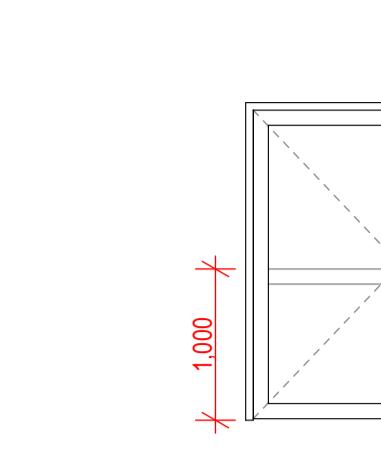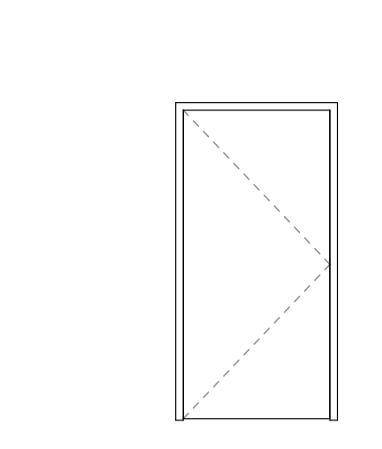						
TYPE CODE	TYPE IN01	TYPE IN02	TYPE IN03	TYPE IN04	TYPE IN05	TYPE IN06
TYPE DESCRIPTION	GLS ENTRY LARGE SLIDING DOOR	INTER-GLS SLIDING DOOR	GLS ENTRY SMALL SLIDING DOOR	MULTIPURPOSE SLIDING DOOR	GLAZED SINGLE DOOR	SINGLE LEAF HINGED DOOR
OVERALL & LEAF SIZE (W X H)	Overall: 4,000mm W x 2,750mm H Leaves: 3 x 1,300mm x 2,690mm	Overall: 2,500mm W x 2,750mm H Leaf: 1 x 2,600mm x 2,690mm	Overall: 1,200mm W x 2,750mm H Leaf: 1 x 1,200mm x 2,690mm	Overall: 7,154mm W x 2,750mm H Leaves: 2 x 1,764mm + 2 x 1,764mm x 2,690mm	Overall: WIDTH VARIES x 2,100mm H Leaf: 1 x 970mm x 2,040mm	Overall: WIDTH VARIES x 2,100mm H Leaf: 1 x 970mm x 2,040mm
FRAME	Type: DW73 - DOOR - SLIDING ACOUSTIC - MULTI Notes:	Type: DW74 - DOOR - SLIDING ACOUSTIC - CAVITY Notes:	Type: DW74 - DOOR - SLIDING ACOUSTIC - CAVITY Notes:	Type: DW75 - DOOR - SLIDING ACOUSTIC - BI-PARTING Notes:	Type: DW07 - DOOR FRAME - ALUMINIUM Notes:	Type: DW07 - DOOR FRAME - ALUMINIUM Notes:
FRAME FINISH						
LEAF	Type: DW73 - DOOR - SLIDING ACOUSTIC - MULTI Notes:	Type: DW74 - DOOR - SLIDING ACOUSTIC - CAVITY Notes:	Type: DW74 - DOOR - SLIDING ACOUSTIC - CAVITY Notes:	Type: DW75 - DOOR - SLIDING ACOUSTIC - BI-PARTING Notes:	Type: DW41 - LEAF - HINGED ALUMINIUM Notes:	Type: DW53 - LEAF - INTERNAL SOLID CORE PAINTED Notes:
LEAF FINISH						
GLAZING	Glazing: GL03 - LAMINATED GLASS TYPE 1 - CLEAR Film: GL33 - VINYL FILM - PRINTED	Glazing: GL03 - LAMINATED GLASS TYPE 1 - CLEAR Film: GL33 - VINYL FILM - PRINTED	Glazing: GL03 - LAMINATED GLASS TYPE 1 - CLEAR Film: GL33 - VINYL FILM - PRINTED	Glazing: GL03 - LAMINATED GLASS TYPE 1 - CLEAR Film: GL33 - VINYL FILM - PRINTED	Glazing: GL03 - LAMINATED GLASS TYPE 1 - CLEAR Film: GL32 - VINYL FILM - COLOURED	Glazing: N/A Film: N/A
NOTES						

150mm @ A1

100

50

150mm @ A1  
50 100  
150mm @ A1  
50 100  
150mm @ A1

plot date: Thursday, 19 December 2024 2:47 PM file location: BIMcloud: FTA-SYD-BIM26 - BIMcloud Basic for Archicad 26/7068ND01 Northmead Public School

REV.	DESCRIPTION	DATE	INIT.
03	100% SCHEMATIC DESIGN	19/12/2024	NK
02	95% SCHEMATIC DESIGN	19/12/2024	AK
01	80% SCHEMATIC DESIGN	26/11/2024	AK

DIRECTORS	NSW 6855 QLD 2950
Greg Lester Frais	QLD 5313
John Ward Frais	NSW 8371 QLD 3847
Karen Dimentious Frais	NSW 7434 QLD 4529
Paul Sene Frais	NSW 7780 QLD 4518
Ryan Lovelady Frais	QLD 4500

VIC 18804

PROJECT NUMBER	DIRECTOR	CHECKED
7068ND01	JW	
DRAWING NUMBER		

REVISION	INTERNAL DOOR & WINDOW SCHEDULE
NPS-FTA-B00T-ZZ-DR-A-6002	03

PHASE	CLIENT	PROJECT
		SCHEMATIC DESIGN
		SCHOOL INFRASTRUCTURE NSW

ADDRESS	PROJECT	PHASE
		NORTHMEAD PUBLIC SCHOOL
		MOXHAMS ROAD, NORTHMEAD, NSW

<b>TYPE CODE</b>	TYPE E01	TYPE E02	TYPE E03	TYPE E04	TYPE E05	TYPE E06
<b>TYPE DESCRIPTION</b>	FIXED GLAZING	SLIDING WINDOW	GLAZED DOUBLE DOOR	GLAZED SINGLE DOOR	SOLID DOOR WITH VISION PANEL	SOLID DOOR (NO VISION PANEL)
<b>OVERALL &amp; LEAF SIZE (W X H)</b>	Overall: WIDTH VARIES x 2,050mm H	Overall: WIDTH VARIES x 2,050mm H	Overall: 2,265mm W x 2,750mm H Leaves: 2 x 970 mm x 2040 mm,	Overall: WIDTH VARIES x 2,750mm H Leaves: 1 x 970 mm x 2040 mm	Overall: WIDTH VARIES x 2,750mm H Leaves: 1 x 1,070 mm x 2040 mm	Overall: WIDTH VARIES x 2,750mm H Leaves: 1 x 1,070 mm x 2040 mm
<b>FRAME</b>	Type: DW03 - FRAME - ALUMINIUM 150MM POCKET GLAZED Notes:	Type: DW01 - FRAME - ALUMINIUM 100MM POCKET GLAZED Notes:	Type: DW07 - DOOR FRAME - ALUMINIUM Notes:	Type: DW07 - DOOR FRAME - ALUMINIUM Notes:	Type: DW07 - DOOR FRAME - ALUMINIUM Notes:	Type: DW07 - DOOR FRAME - ALUMINIUM Notes:
<b>FRAME FINISH</b>						
<b>LEAF</b>	Type: N/A Notes:	Type: DW21 - WINDOW - SLIDING ALUMINIUM Notes:	Type: DW41 - LEAF - HINGED ALUMINIUM Notes:	Type: DW41 - LEAF - HINGED ALUMINIUM Notes:	Type: DW52 - LEAF - EXTERNAL SOLID CORE PAINTED w VISION PANEL Notes:	Type: DW51 - LEAF - EXTERNAL SOLID CORE PAINTED Notes:
<b>LEAF FINISH</b>						
<b>GLAZING</b>	Glazing: GL04 - LAMINATED GLASS TYPE 2 - TINTED Film: N/A	Glazing: GL04 - LAMINATED GLASS TYPE 2 - TINTED Film: GL32 - VINYL FILM - COLOURED	Glazing: GL04 - LAMINATED GLASS TYPE 2 - TINTED Film: GL32 - VINYL FILM - COLOURED	Glazing: GL04 - LAMINATED GLASS TYPE 2 - TINTED Film: N/A	Glazing: GL04 - LAMINATED GLASS TYPE 2 - TINTED Film: N/A	Glazing: GL04 - LAMINATED GLASS TYPE 2 - TINTED Film: N/A
<b>NOTES</b>	REFER TO ELEVATIONS FOR NUMBER OF MULLIONS					

<b>TYPE CODE</b>	TYPE E07	TYPE E08	TYPE E09	TYPE E10	TYPE E11	TYPE E12
<b>TYPE DESCRIPTION</b>	SOLID DOOR (NO VISION PANEL, NO FANLIGHT)	SOLID FIRE DOOR (SINGLE LEAF)	SOLID FIRE DOOR DOUBLE LEAF)	SOLID DOOR (NO VISION PANEL, DOUBLE LEAF)	MECHANICAL LOUvre	FIXED LOUvre WITH INSULATED DOOR BEHIND
<b>OVERALL &amp; LEAF SIZE (W X H)</b>	Overall: WIDTH VARIES x 2,100mm H Leaves: 1 x 1,070 mm x 2040 m	Overall: WIDTH VARIES x 2,750mm H Leaves: 1 x 1,070 mm x 2040 mm	Overall: WIDTH VARIES x 2,100mm H Leaves: 2 x 1,070 mm x 2040 mm	Overall: WIDTH VARIES x 2,750mm H Leaves: 2 x 1,070 mm x 2040 mm	Overall: WIDTH VARIES x 750mm H	Overall: WIDTH VARIES x 2,050mm H
<b>FRAME</b>	Type: DW07 - DOOR FRAME - ALUMINUM Notes:	Type: DW14 - DOOR FRAME - FIRE DOOR Notes:	Type: DW14 - DOOR FRAME - FIRE DOOR Notes:	Type: DW07 - DOOR FRAME - ALUMINIUM Notes:	Type: DW03 - FRAME - ALUMINIUM 150MM POCKET GLAZED Notes:	Type: DW03 - FRAME - ALUMINIUM 150MM POCKET GLAZED Notes:
<b>FRAME FINISH</b>						
<b>LEAF</b>	Type: DW51 - LEAF - EXTERNAL SOLID CORE PAINTED Notes:	Type: DW71 - DOOR - FIRE Notes:	Type: DW71 - DOOR - FIRE Notes:	Type: DW51 - LEAF - EXTERNAL SOLID CORE PAINTED Notes:	Type: DW36 - LOUVRES - FIXED ALUMINIUM TYPE 1 Notes:	Type: DW33 - LOUVRES - 150MM Notes:
<b>LEAF FINISH</b>						
<b>GLAZING</b>	Glazing: GL04 - LAMINATED GLASS TYPE 2 - TINTED Film: N/A	Glazing: N/A Film: N/A	Glazing: N/A Film: N/A	Glazing: N/A Film: N/A	Glazing: N/A Various Colours: Film: N/A	Glazing: N/A Film: N/A
<b>NOTES</b>						

150mm @ A1

100

50

150mm @ A1  
50  
100  
150mm @ A1  
plot date: Thursday, 19 December 2024 2:47 PM file location: BIMcloud: FTA-SYD-BIM26 - BIMcloud Basic for Archicad 26/7068ND01 Northmead Public School


REV.	DESCRIPTION	DATE	INIT.
03	100% SCHEMATIC DESIGN	19/12/2024	NK
02	95% SCHEMATIC DESIGN	19/12/2024	AK
01	80% SCHEMATIC DESIGN	26/11/2024	AK

FULTON TROTTER ARCHITECTS BRISBANE SYDNEY www.fultontrotter.com.au	Sydney Suite 904, Level 9, 26-38 Forrester Street, SWS, NSW 2010 1 (02) 8383 5151 e. sydney@fultontrotter.com.au
DIRECTORS	Greg Trotter (Chair) John Ward (Chair) Kieren Dimentious (Chair) Paul Sene (Chair) Ryan Lovelady (Chair)
PROJECT NUMBER	7068ND01

PHASE	CLIENT	PROJECT
SCHEMATIC DESIGN		
SCHOOL INFRASTRUCTURE NSW		


NORTHMEAD PUBLIC SCHOOL  
MOXHAMS ROAD,  
NORTHMEAD, NSW

EXTERNAL DOOR & WINDOW SCHEDULE	N
Figured dimensions take precedence over scale dimensions. Contractors must verify all dimensions on site before commencing any work or making shop drawings.	
PROJECT NUMBER	DIRECTOR
7068ND01	JW
DRAWING NUMBER	NK
REVISION	
NPS-FTA-B00T-ZZ-DR-A-6001	03

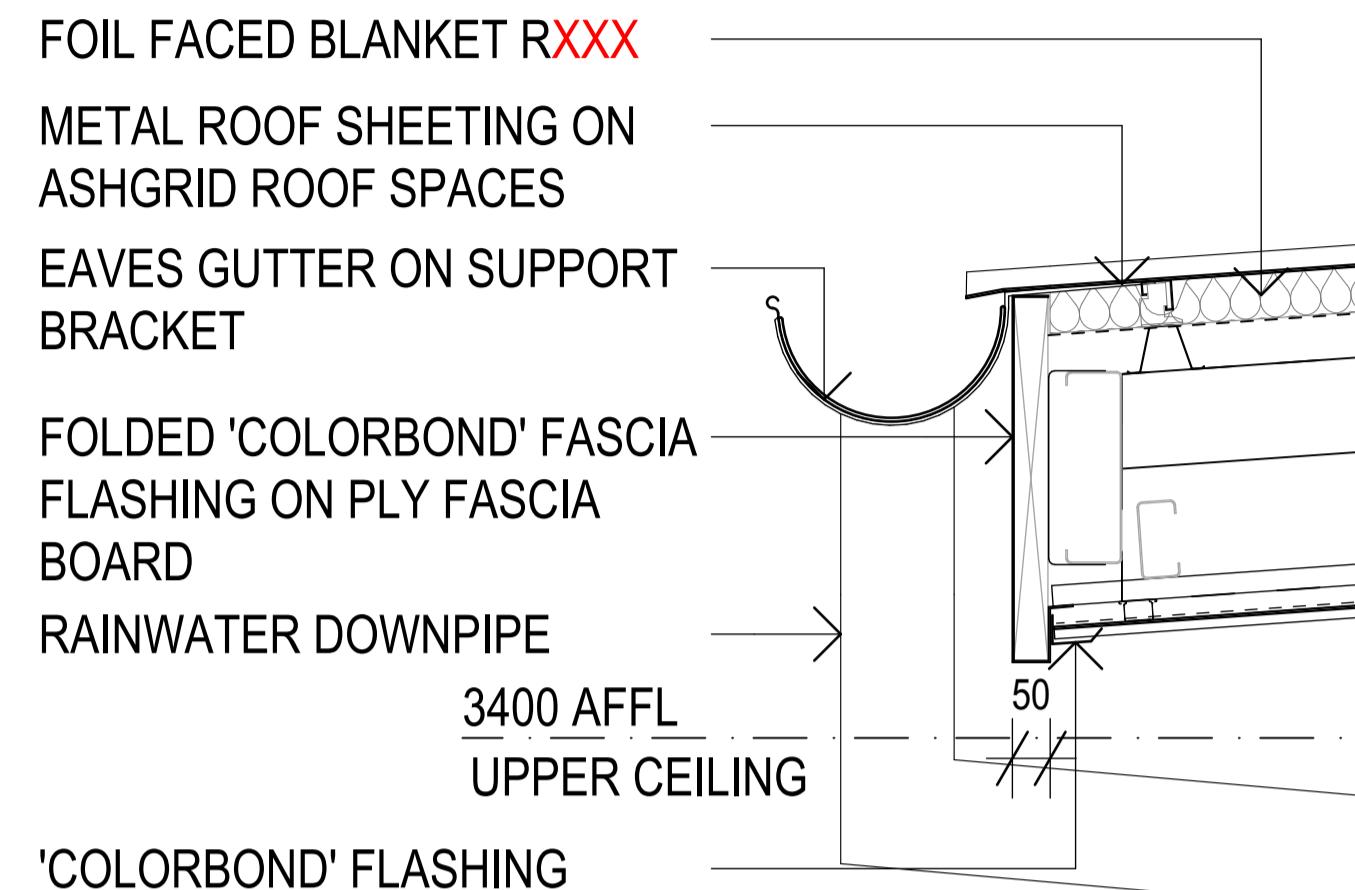

**1 DETAIL SECTION**  
**TYPICAL FASCIA DETAILS 01**

SCALE: 1:10

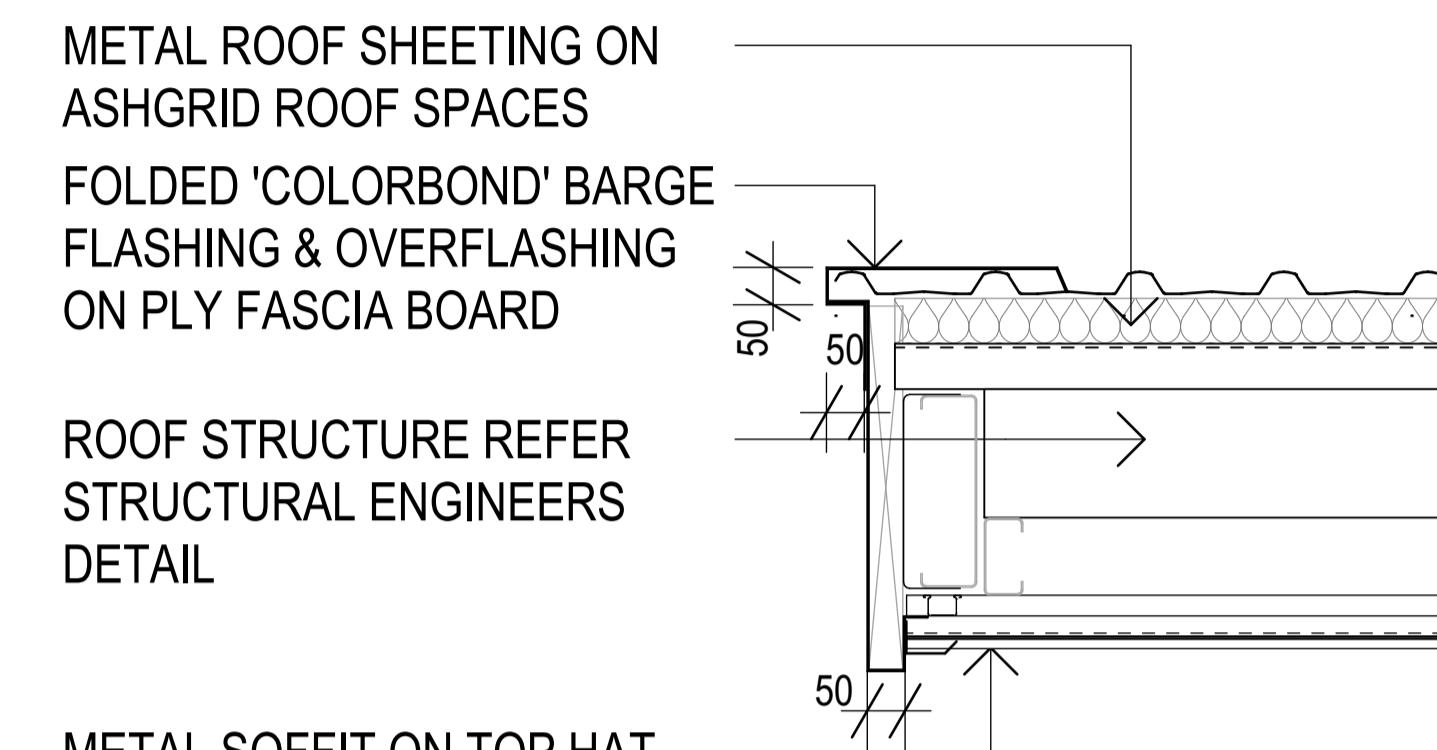

## **2 DETAIL SECTION**

### **TYPICAL FASCIA DETAILS 02**

SCALE: 1:10

SCALE: 1:10

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**PHASE** | **SCHEMATIC DESIGN**

**CLIENT** | **SCHOOL INFRASTRUCTURE NSW**






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**PROJECT** | **NORTHMEAD PUBLIC SCHOOL**

---

**ADDRESS** | **MOXHAMS ROAD,  
NORTHMEAD. NSW**

DRAWING	<b>TYPICAL FASCIA DETAILS</b>		
<p>Figured dimensions take precedence over scale dimensions. Contractors must verify all dimensions on site before commencing any work or making shop drawings.</p>			
PROJECT NUMBER		DIRECTOR	CHECKED
<b>7068ND01</b>		<b>JW</b>	<b>NK</b>
DRAWING NUMBER		REVISION	
<b>NBS ETA BOOT ZZ DB A 1801</b>		<b>03</b>	

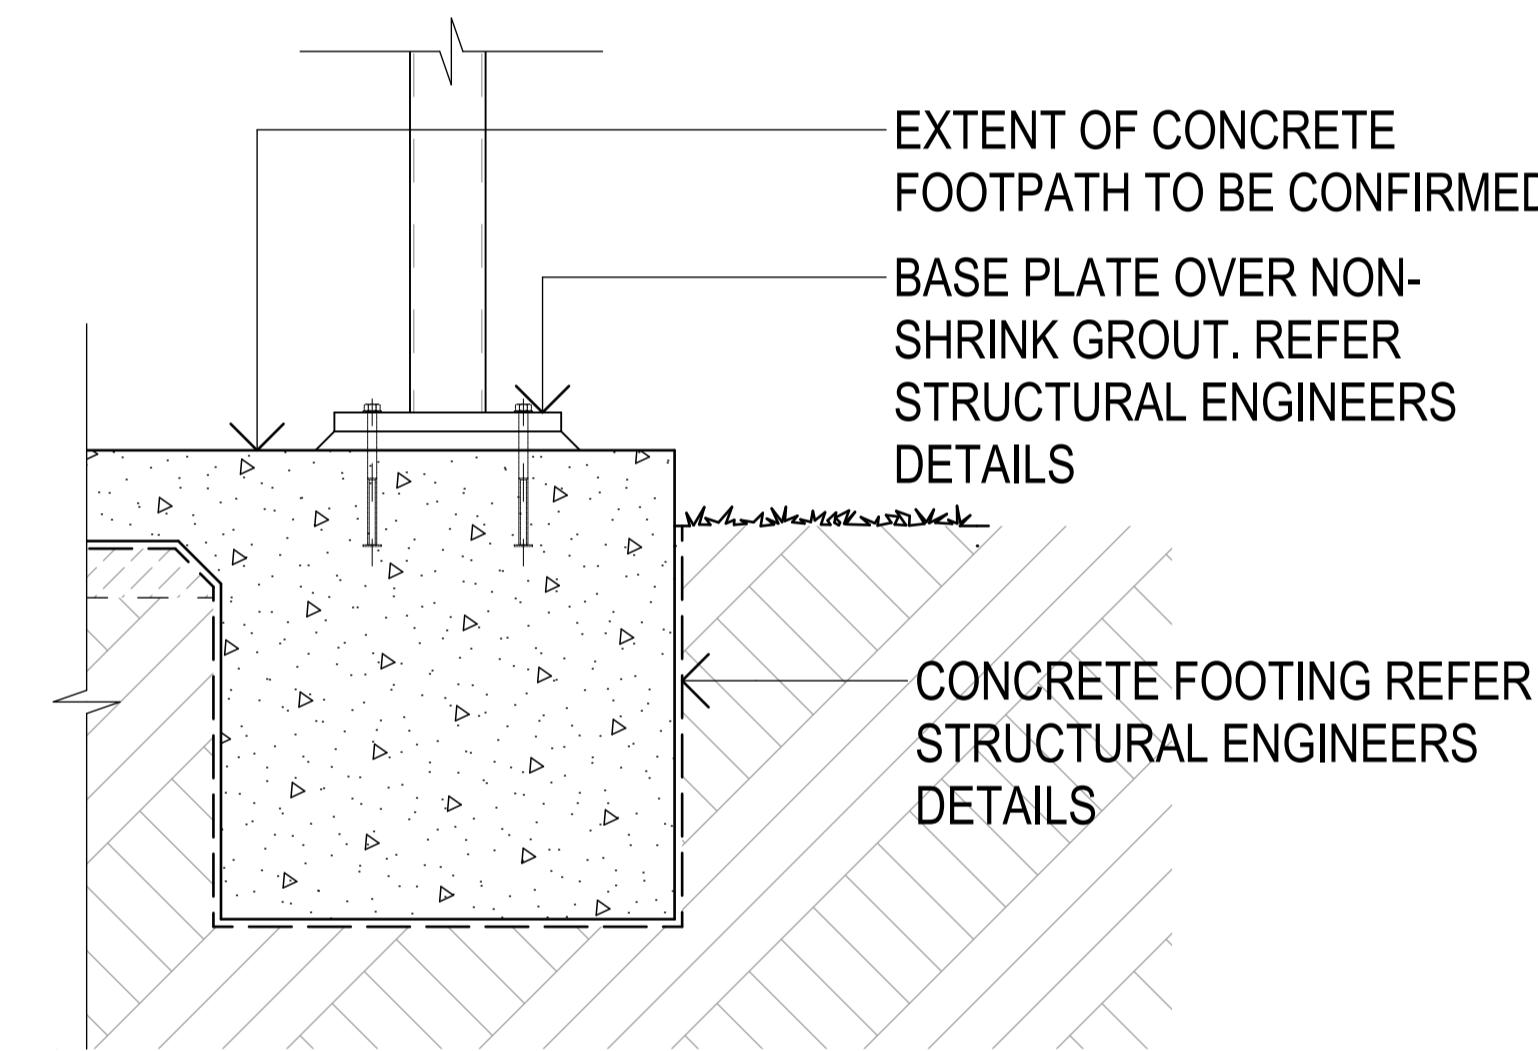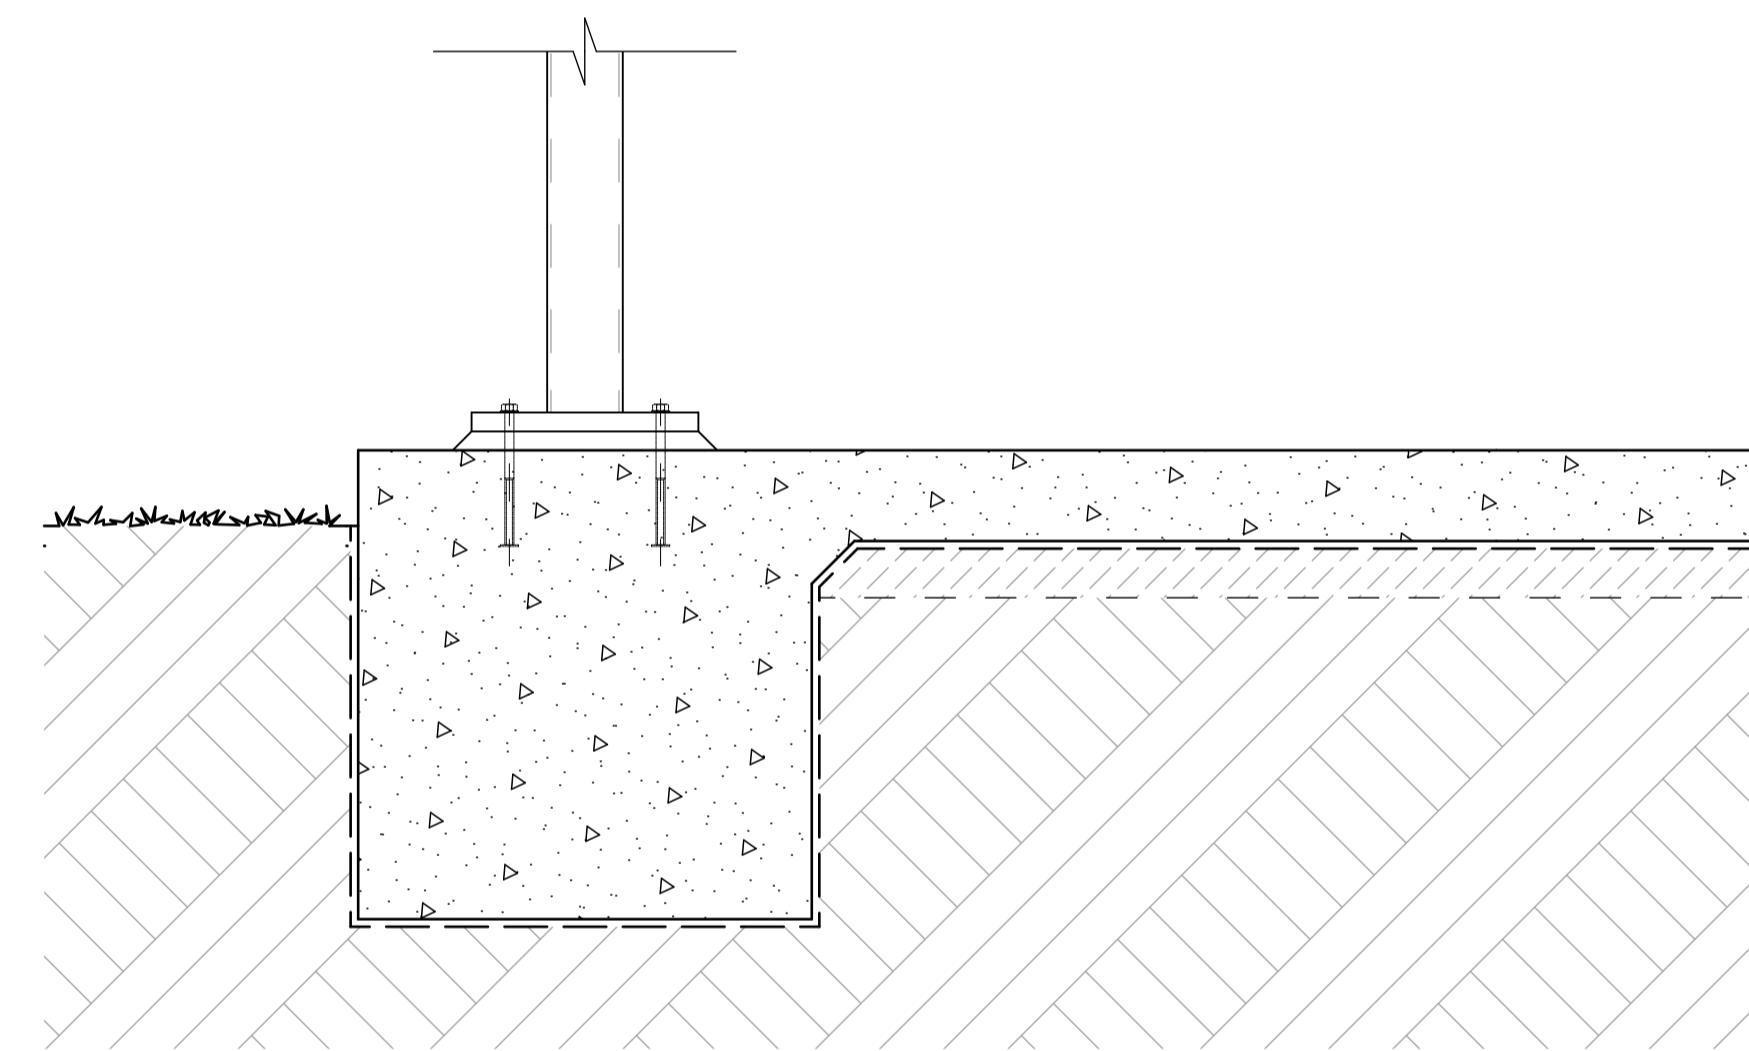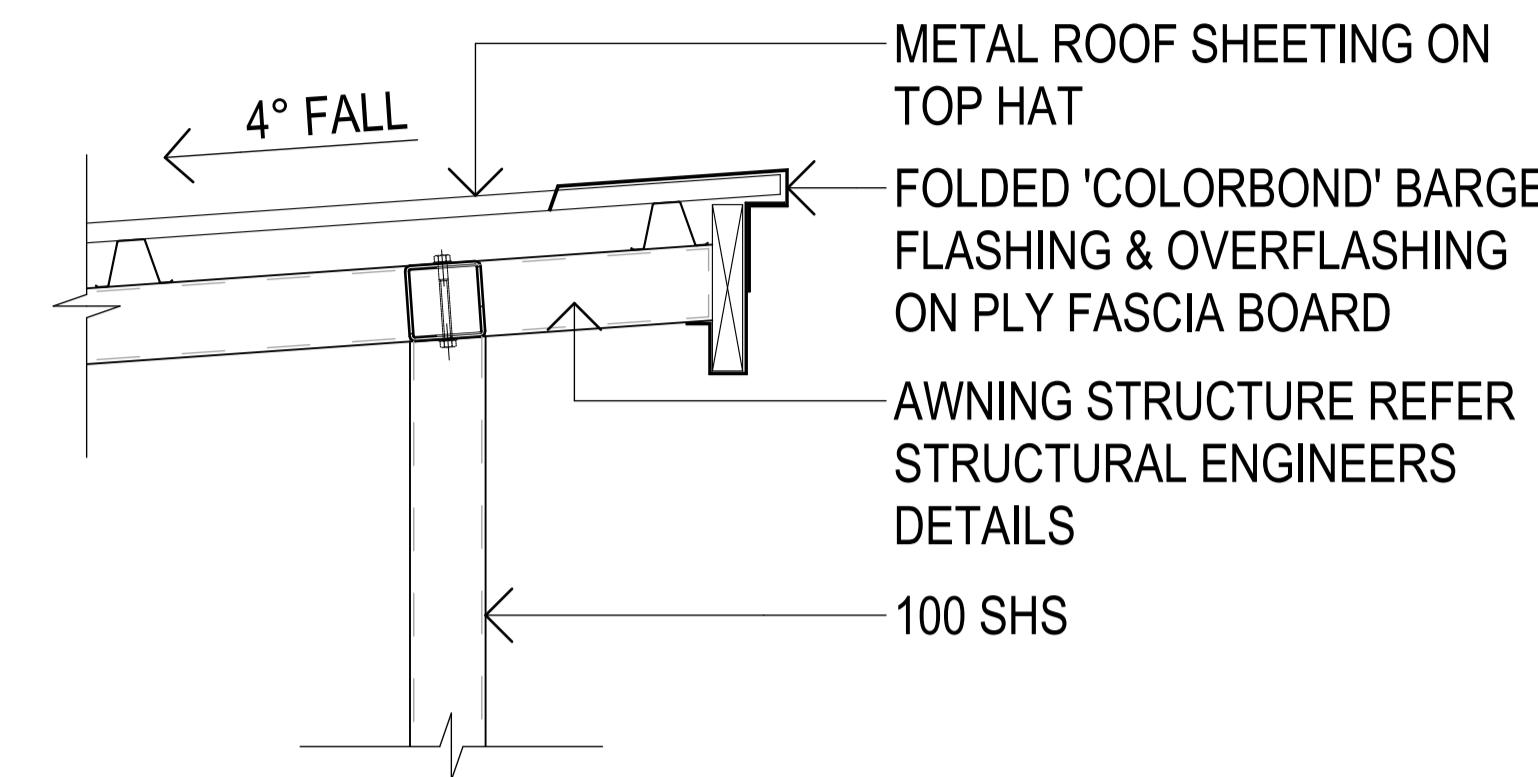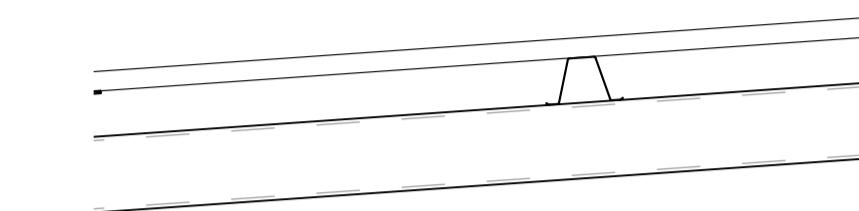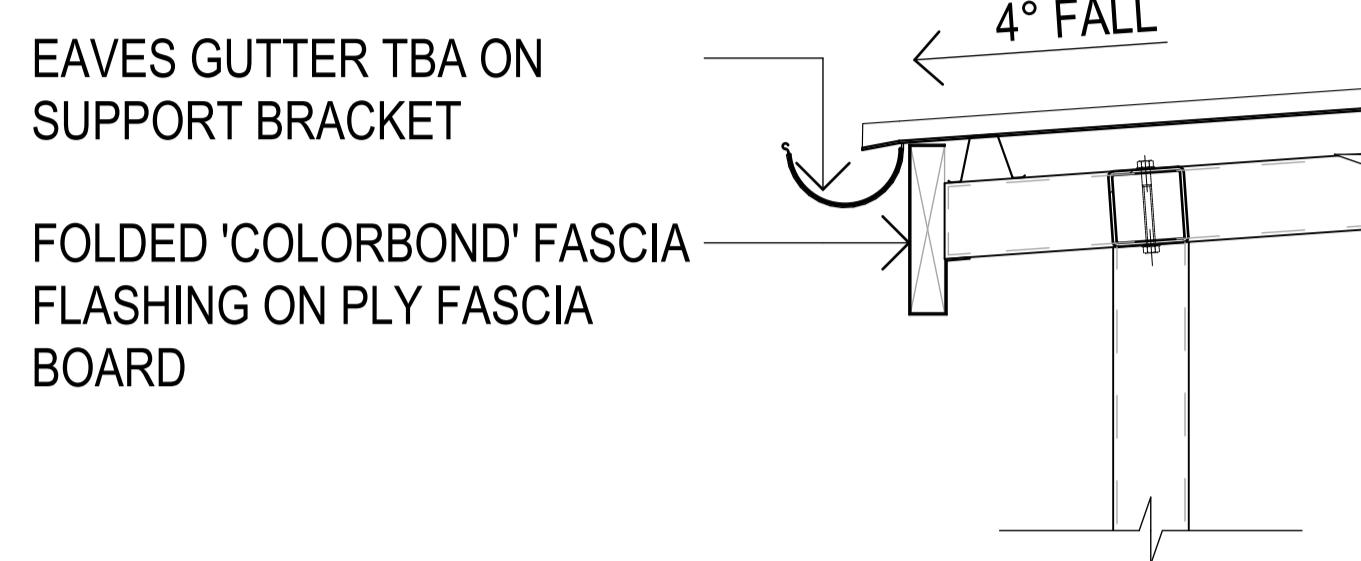

**1** DETAIL SECTION  
TYPICAL COVERED WALKWAY DETAILS 01  
SCALE: 1:10

150mm @ A1

100

50

50

REV.	DESCRIPTION	DATE	INIT.
03	100% SCHEMATIC DESIGN	19/12/2024	NK
02	95% SCHEMATIC DESIGN	19/12/2024	AK
01	80% SCHEMATIC DESIGN	26/11/2024	AK

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1 (02) 8383 5151 a.sydney@fultontrotter.com.au

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	John Ward r/a	QLD 5313
	Karen Dimopoulos r/a	VIC 18804
	Paul Sene r/a	NSW 8371 QLD 3847
	Ryan Lovelady r/a	NSW 7434 QLD 4529
		NSW 7780 QLD 42168
		QLD 4500

**SCHEMATIC DESIGN**  
SCHOOL INFRASTRUCTURE  
NSW


**PROJECT** NORTHMEAD PUBLIC SCHOOL  
**ADDRESS** MOXHAMS ROAD,  
NORTHMEAD, NSW

**COVERED WALKWAY DETAILS**

Figured dimensions take precedence over scale dimensions. Contractors must verify all dimensions on site before commencing any work or making shop drawings.


PROJECT NUMBER	DIRECTOR
7068ND01	JW
DRAWING NUMBER	CHECKED
	NK
REVISION	

**NPS-FTA-B00T-ZZ-DR-A-4801** **03**

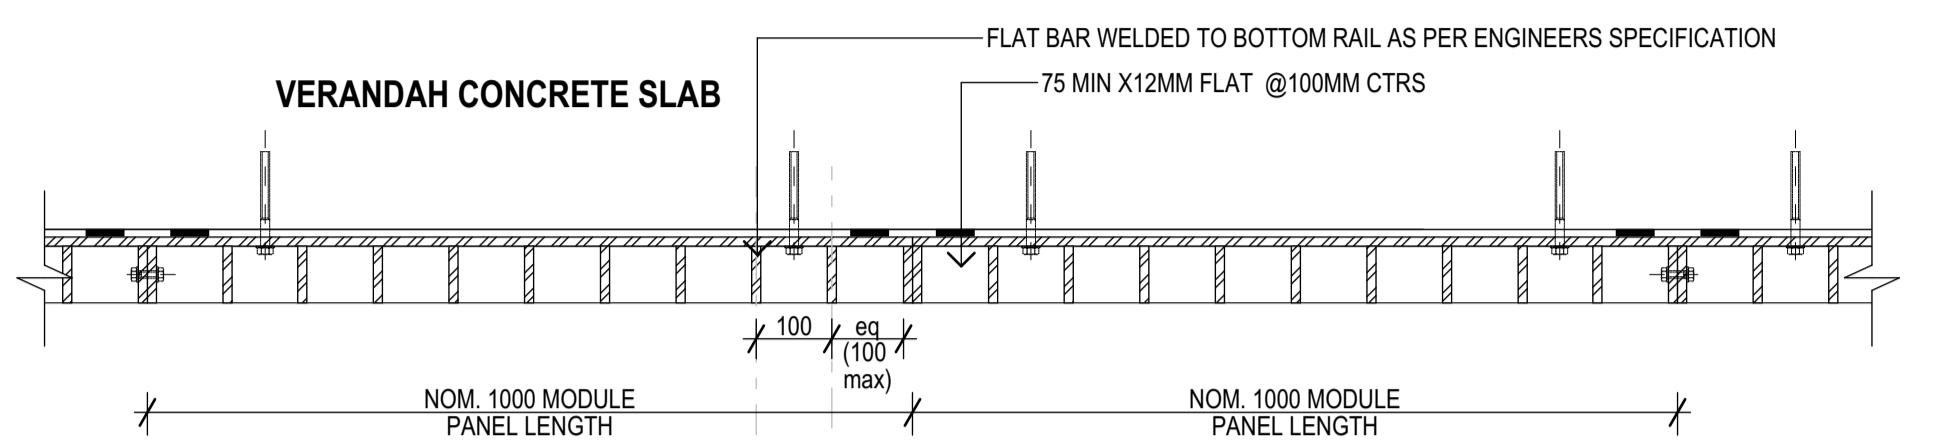


**1 DETAIL PLAN  
BALUSTRADE AND HANDRAIL DETAILS**

SCALE: 1:10

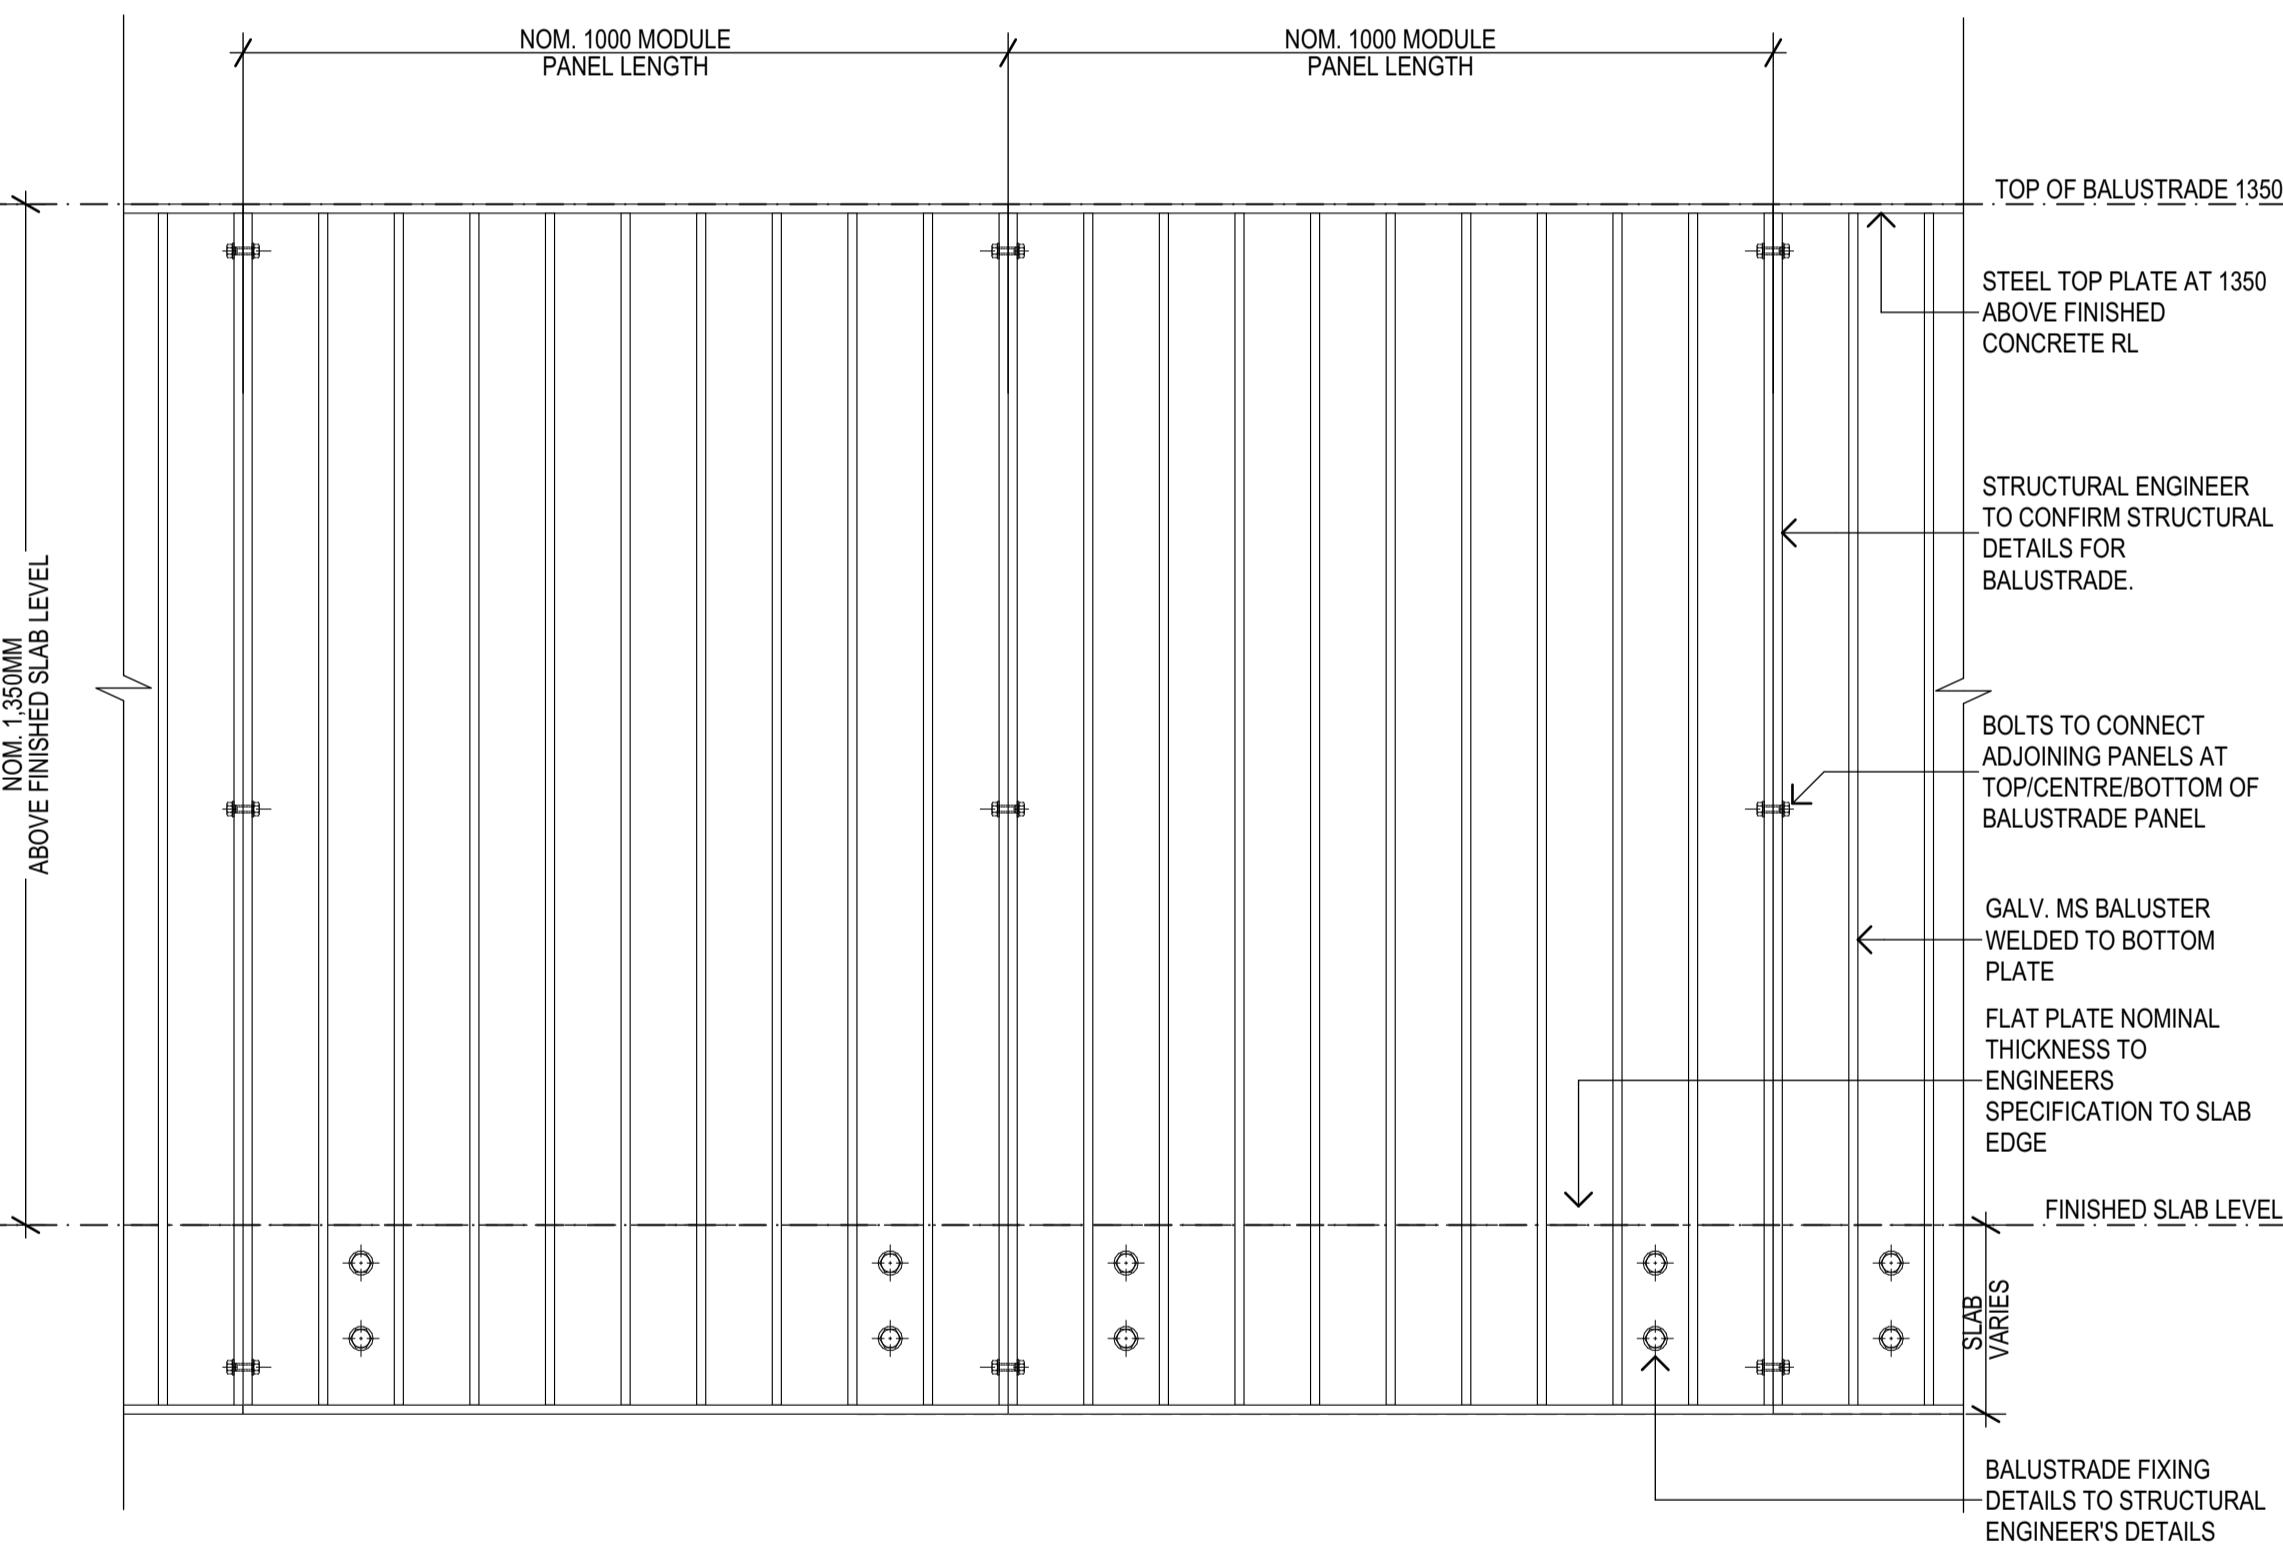

**2 DETAIL ELEVATION  
BALUSTRADE AND HANDRAIL DETAILS**

SCALE: 1:10

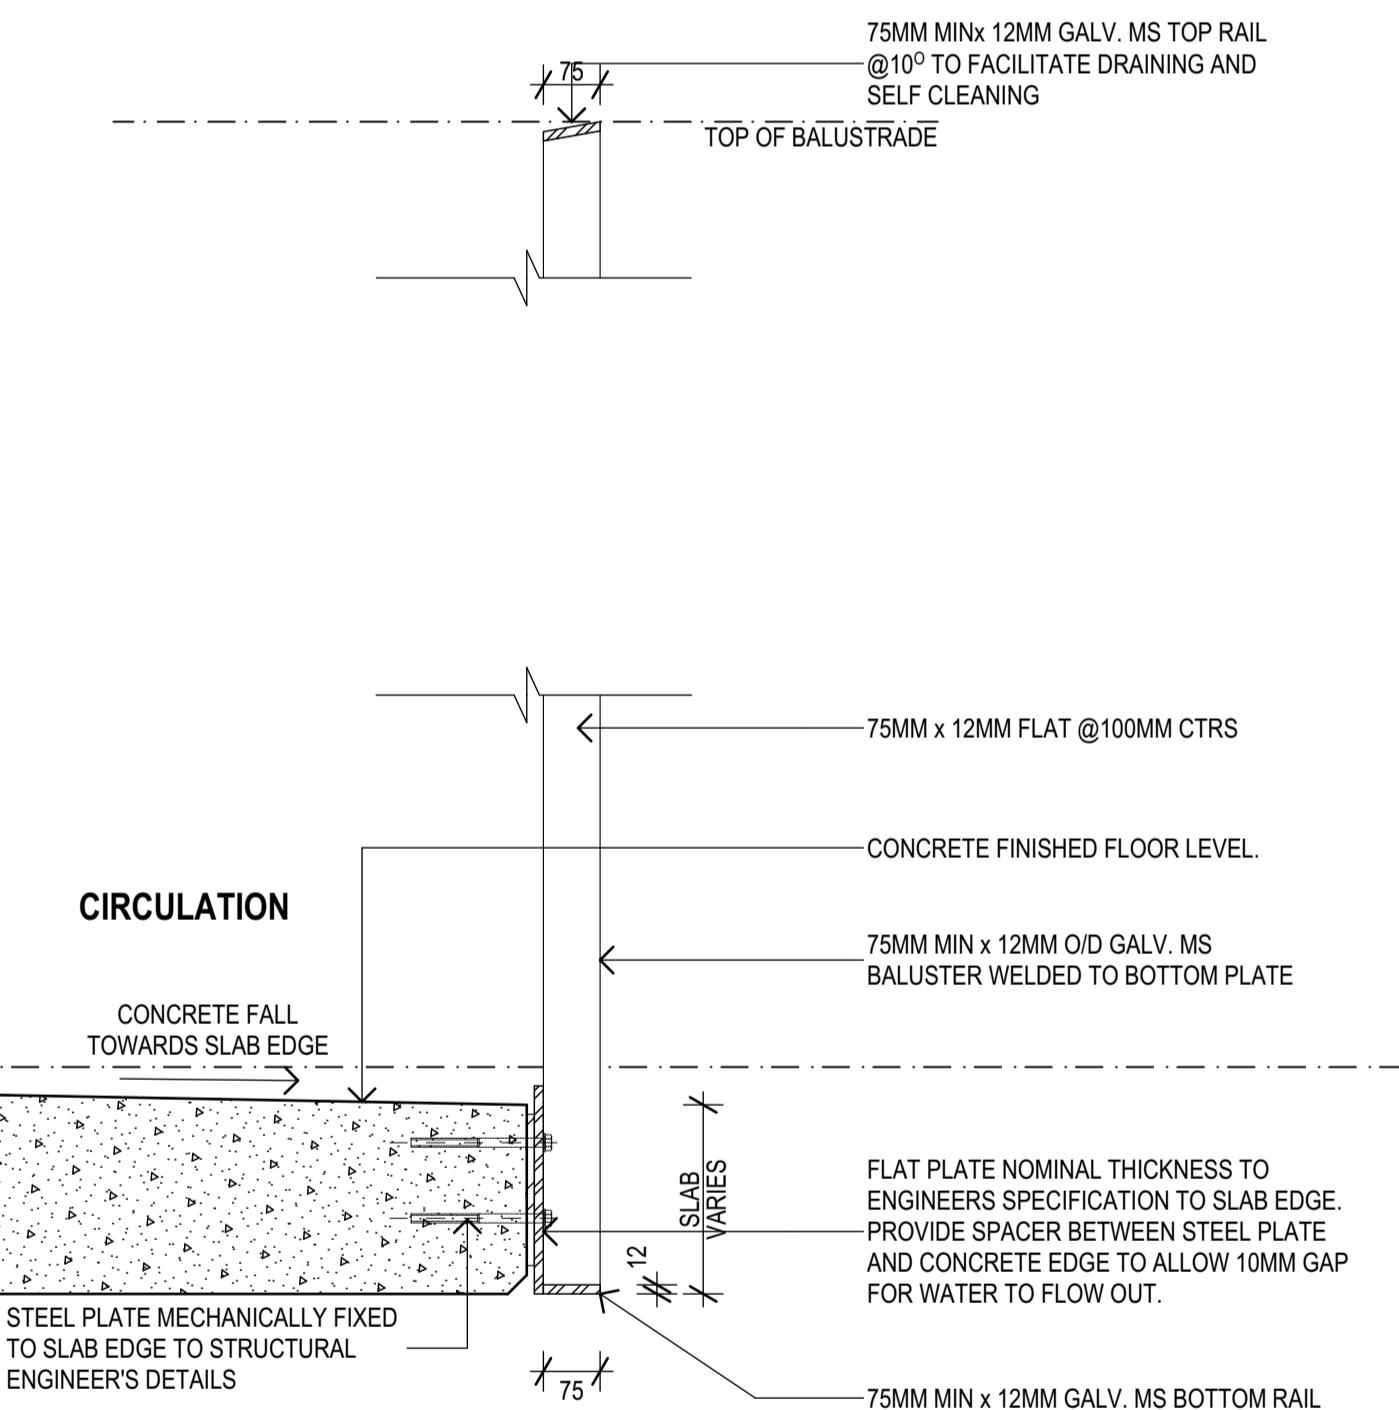

**3 DETAIL SECTION  
BALUSTRADE AND HANDRAIL DETAILS**

SCALE: 1:10

REV.	DESCRIPTION	DATE	INIT.
02	100% SCHEMATIC DESIGN	19/12/2024	NK
01	95% SCHEMATIC DESIGN	10/12/2024	AK

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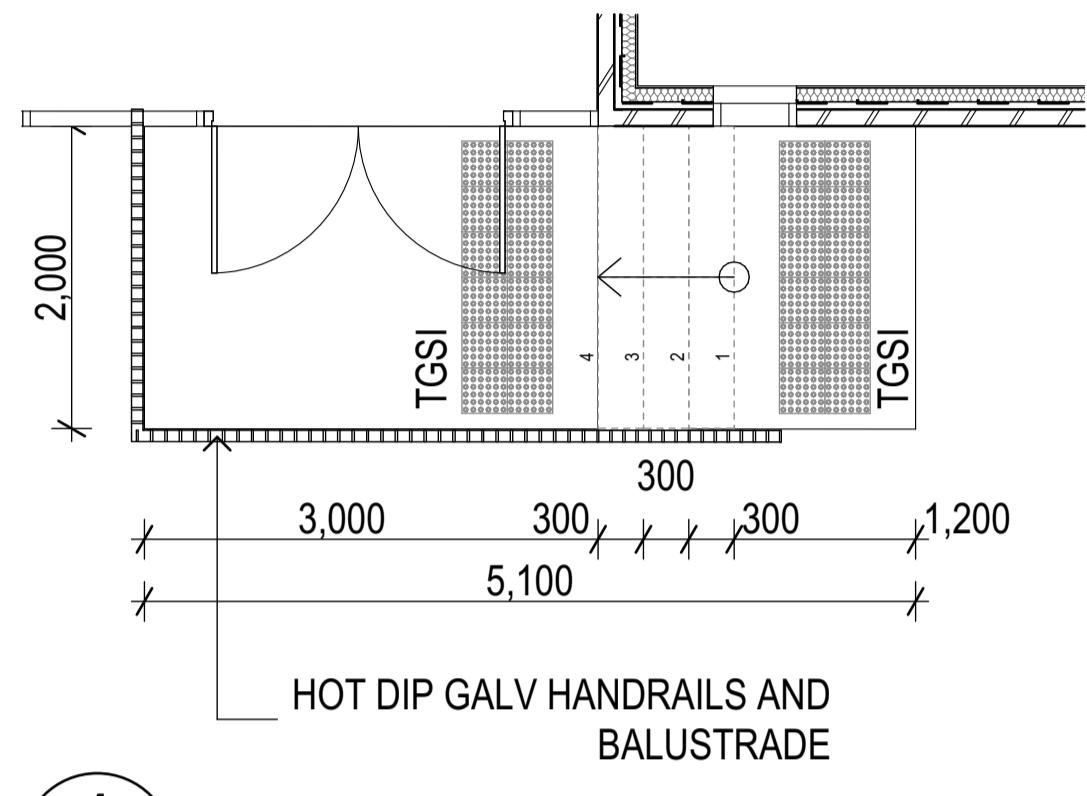
SYDNEY Suite 904, Level 9, 26-38 Forrester Street, SWS, NSW 2010  
1 (02) 8383 5151 e. [sydney@fultontrotter.com.au](mailto:sydney@fultontrotter.com.au)

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John Wardraia  
Kieren D'Emilio  
Paul Suttorraia  
Ryan Lovelady (Chair)  
NSW 6855 QLD 2950  
VIC 18804 NSW 8371 QLD 3313  
NSW 7434 QLD 3847  
NSW 7780 QLD 4529  
QLD 4500


PHASE  
CLIENT  
**SCHEMATIC DESIGN**  
SCHOOL INFRASTRUCTURE  
NSW  
PROJECT  
NORTHMEAD PUBLIC SCHOOL  
ADDRESS  
MOXHAMS ROAD,  
NORTHMEAD, NSW  
DRAWING NUMBER  
**NPS-FTA-B00T-ZZ-DR-A-4501**  
REVISION  
**02**

Figured dimensions take precedence over scale dimensions. Contractors must verify all dimensions on site before commencing any work or making shop drawings.  
PROJECT NUMBER DIRECTOR  
**7068ND01 JW NK**  
DRAWING NUMBER  
REVISION  
**NPS-FTA-B00T-ZZ-DR-A-4501 02**



**1** DETAIL SECTION  
STAIR PLAN DETAIL

SCALE: 1:50

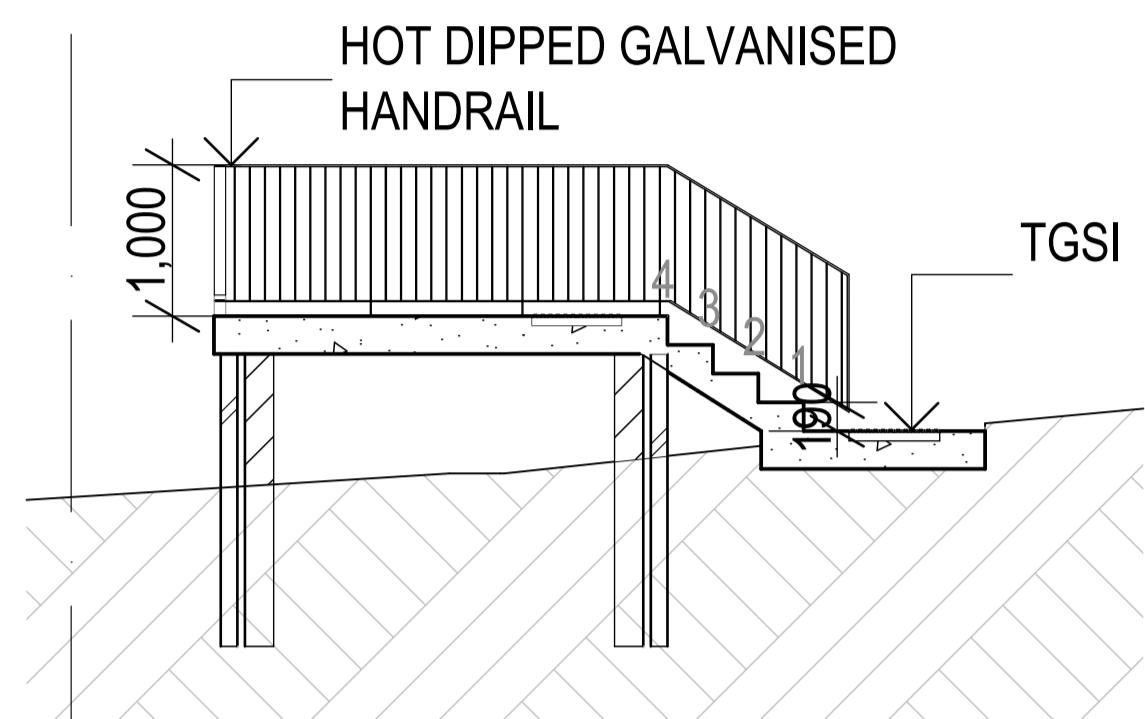

**2** DETAIL SECTION  
STAIR SECTION DETAIL

SCALE: 1:50

150mm @ A1  
100  
50  
50  
100  
150mm @ A1


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02	100% SCHEMATIC DESIGN		19/12/2024	NK					
01			10/12/2024						
REV.	DESCRIPTION				DATE		INIT.		

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DIRECTORS Greg Trotter fraia John Ward fraia VIC 18804 NSW 6855 QLD 2950  
Justine Ebrey fraia Paul Seneviratne fraia NSW 8371 QLD 3313  
John Ward fraia Kelvin D'Souza fraia NSW 7434 QLD 4250  
Paul Seneviratne fraia NSW 7780 QLD 2718  
Ryan Lovelady fraia NSW 7780 QLD 4500

PHASE  
PROJECT CLIENT  
**SCHEMATIC DESIGN**  
SCHOOL INFRASTRUCTURE  
NSW  
NORTHMEAD PUBLIC SCHOOL  
MOXHAMS ROAD,  
NORTHMEAD, NSW  
DRAWING NUMBER  
**NPS-FTA-B00T-ZZ-DR-A-4401**  
REVISION  
**02**

DRAWING  
DETAILS  
**BUILDING T - STAIR AND RAMP**  
N  
PROJECT NUMBER  
**7068ND01** DIRECTOR  
DRAWING NUMBER  
**JW** CHECKED  
REVISION  
**NK**  
REVISION  
**02**

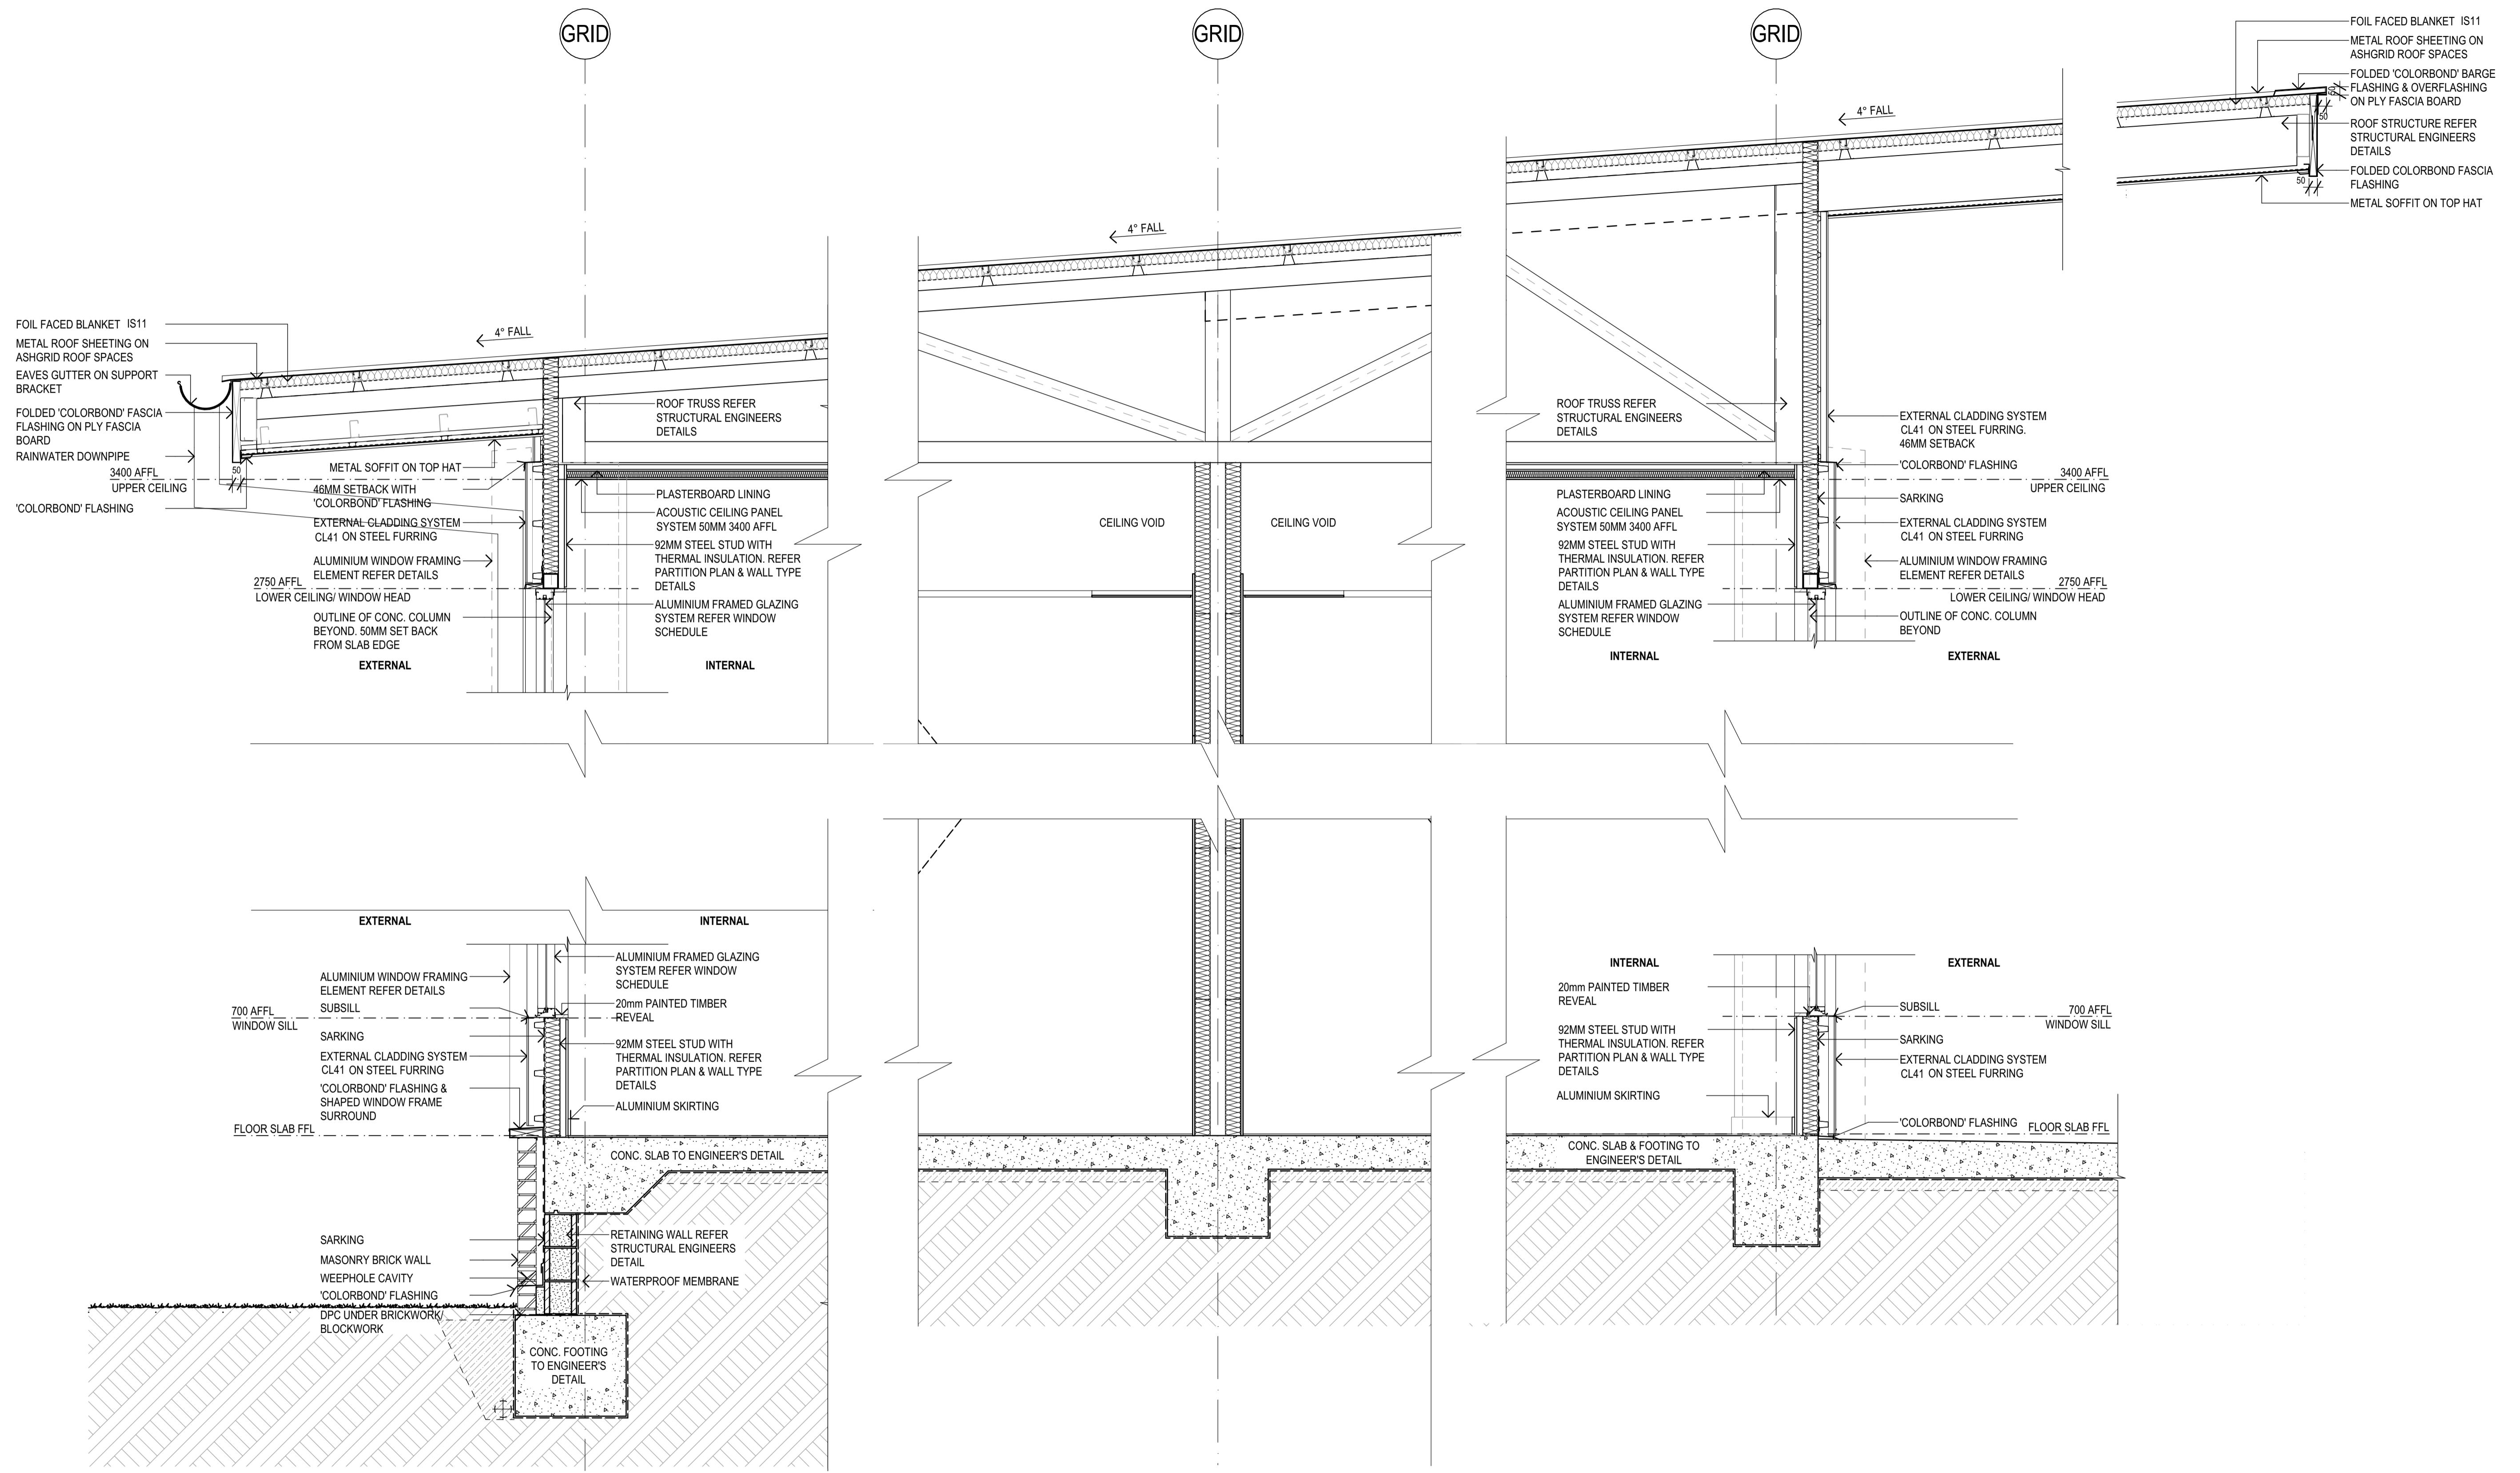


REV.	DESCRIPTION	DATE	INIT.
04	100% SCHEMATIC DESIGN	19/12/2024	NK
03	95% SCHEMATIC DESIGN	10/12/2024	AK
02	80% SCHEMATIC DESIGN	26/11/2024	AK
01	SD-01 - 50% SCHEMATIC DESIGN	15/11/2024	AK



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SYDNEY Suite 904, Level 9, 26-38 Foveaux Street, Surry Hills, NSW 2010	
I (02) 8383 5151 e. <a href="mailto:sydney@fultontrotter.com.au">sydney@fultontrotter.com.au</a>	
Fulton Trotter Architects ACN 677 264 559 ABN 57 677 264 559	
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DIRECTORS Greg McRae Justine Ebenezer Iraia John Ward Iraia Kieren Dargatzousis Iraia Paul Sene Iraia Ryan Lovelady Iraia	
NSW 6855 QLD 2950 VIC 18804 QLD 5313 NSW 8371 QLD 3847 NSW 7434 QLD 4529 NSW 7180 QLD 4508 NSW 7188 QLD 4500	

PHASE  
PROJECT CLIENT  
**SCHEMATIC DESIGN**  
SCHOOL INFRASTRUCTURE  
NSW  
NORTHMEAD PUBLIC SCHOOL  
MOXHAMS ROAD,  
NORTHMEAD, NSW


**BUILDING T - WALL SECTIONS 02**  
Figured dimensions take precedence over scale dimensions. Contractors must verify all dimensions on site before commencing any work or making shop drawings.  
PROJECT NUMBER DIRECTOR  
**7068ND01** **JW**  
DRAWING NUMBER  
**NPS-FTA-B00T-ZZ-DR-A-4202** **04**  
REVISION  
N  
CHECKED  
NK

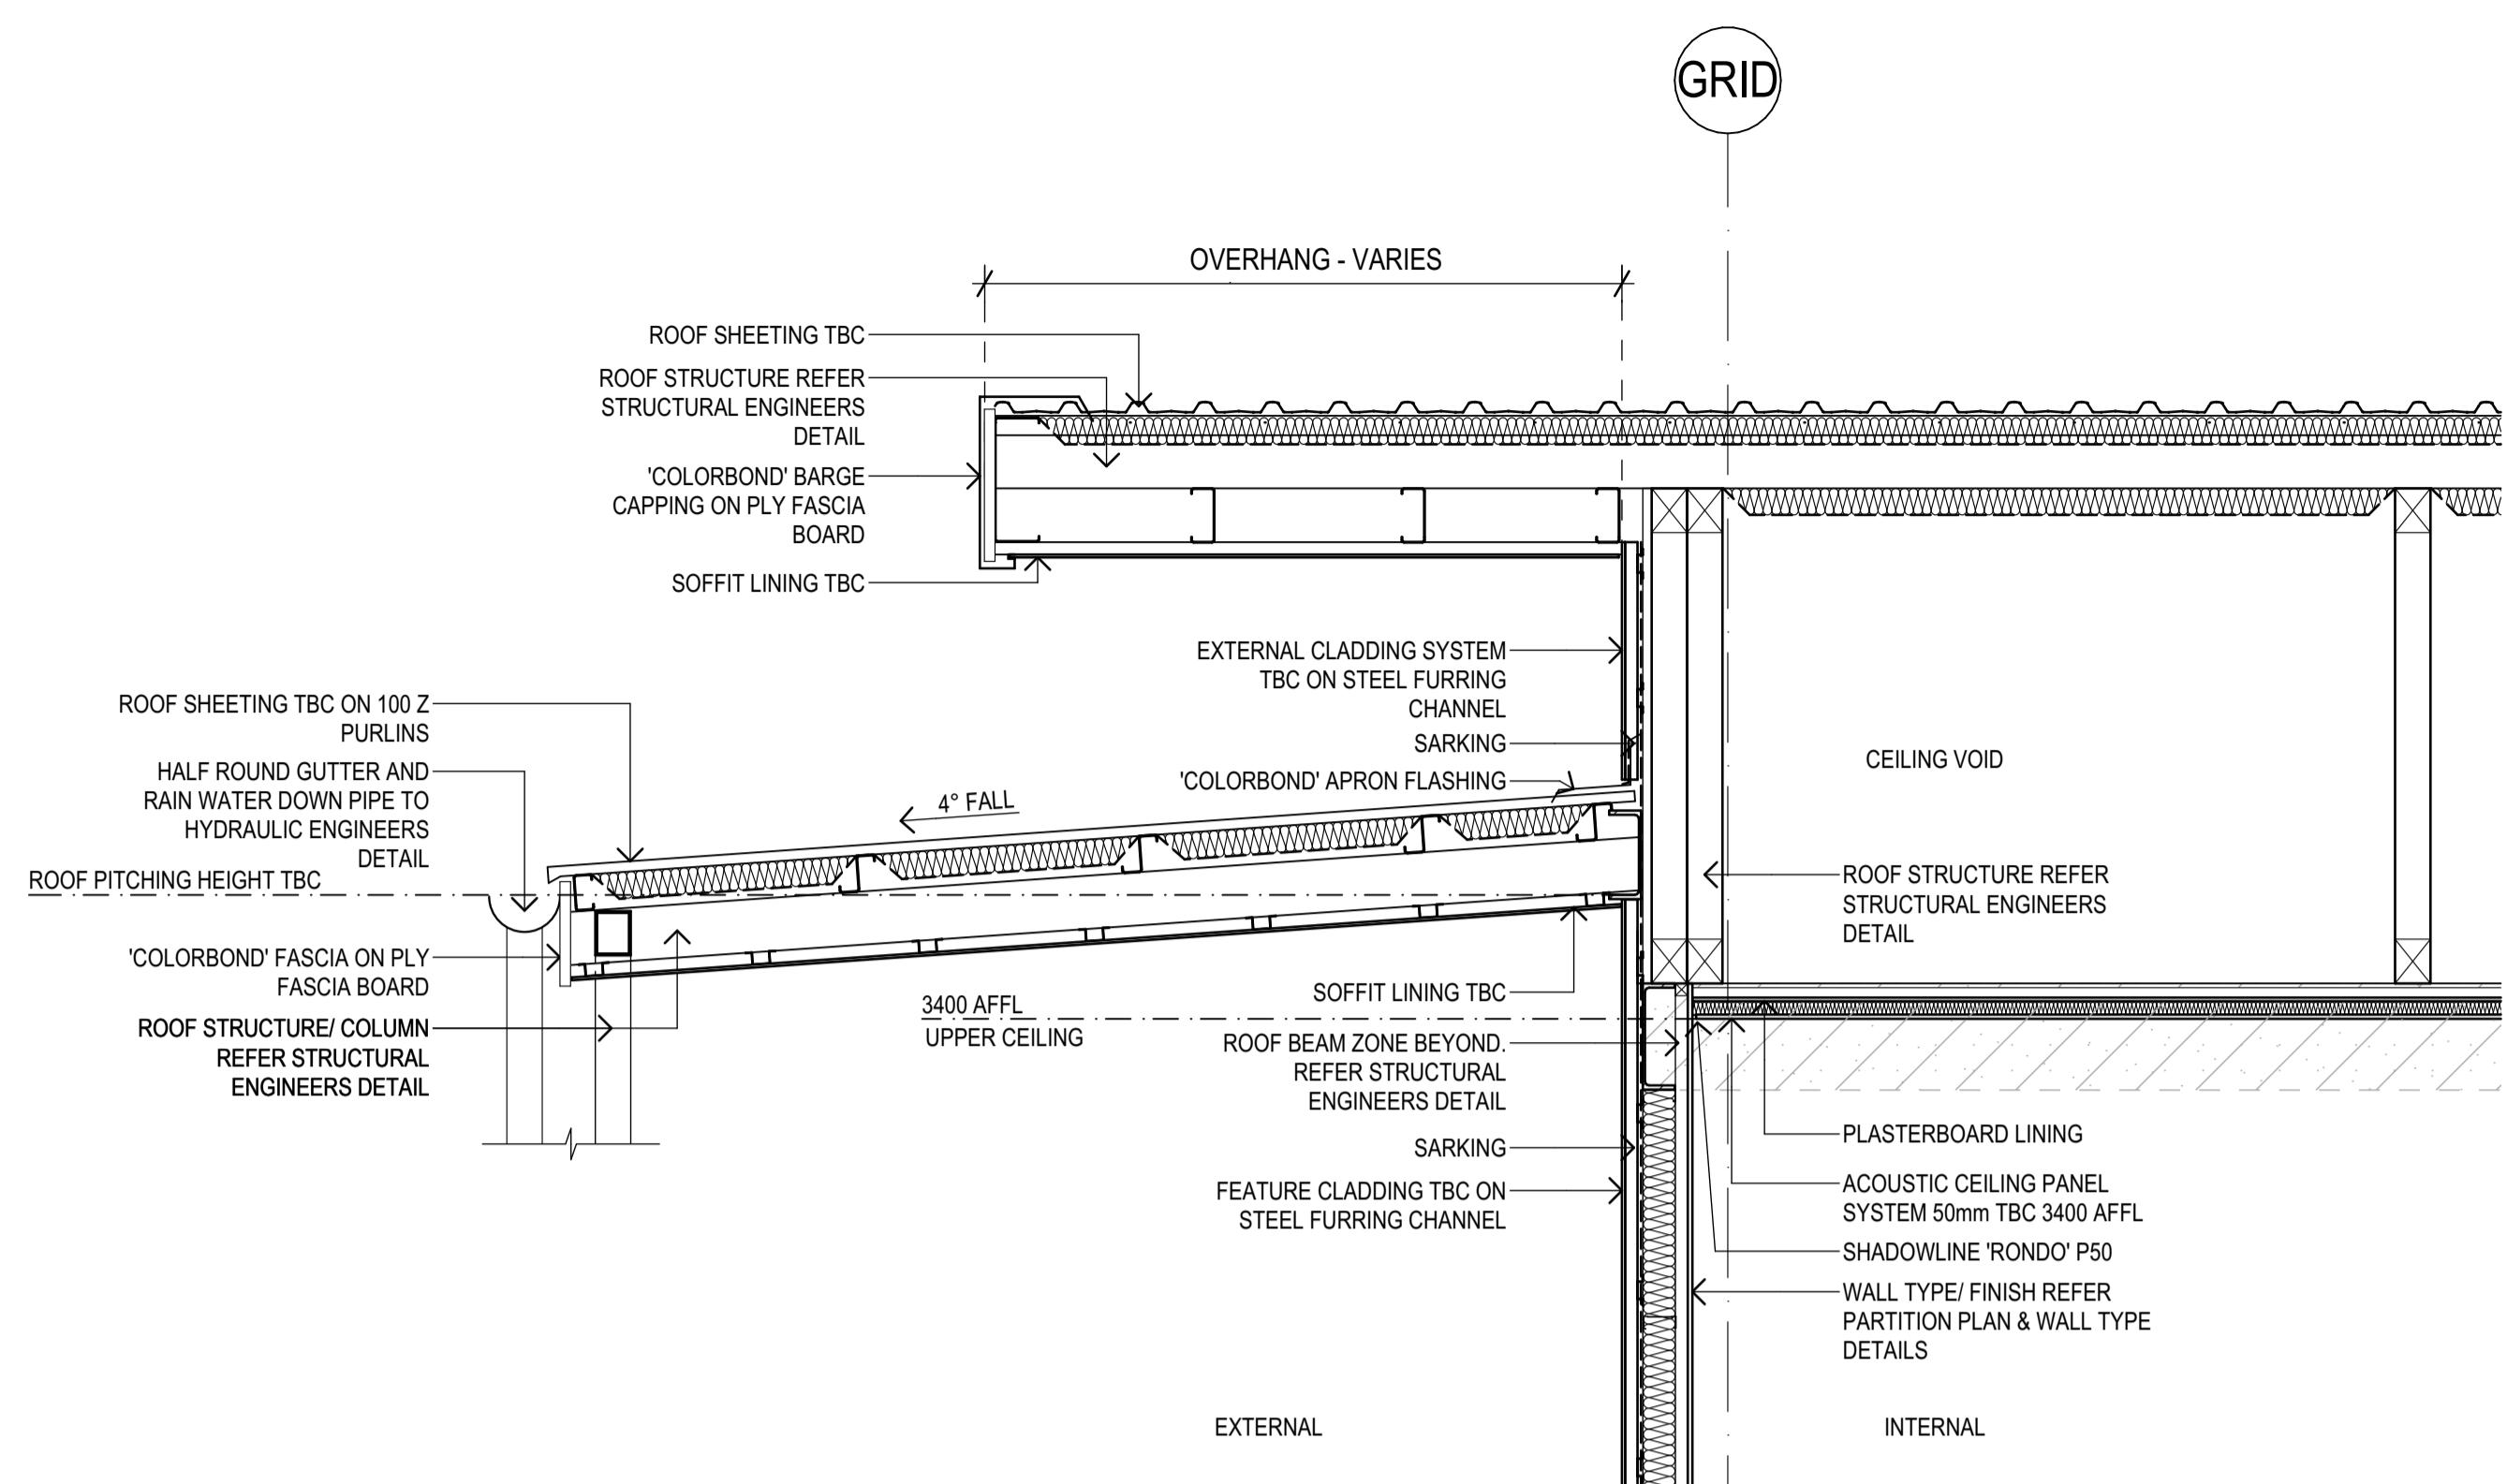

**6** DETAIL SECTION  
END WALL DETAIL IN JUNCTION WITH COVERED AWNING  
SCALE: 1:20

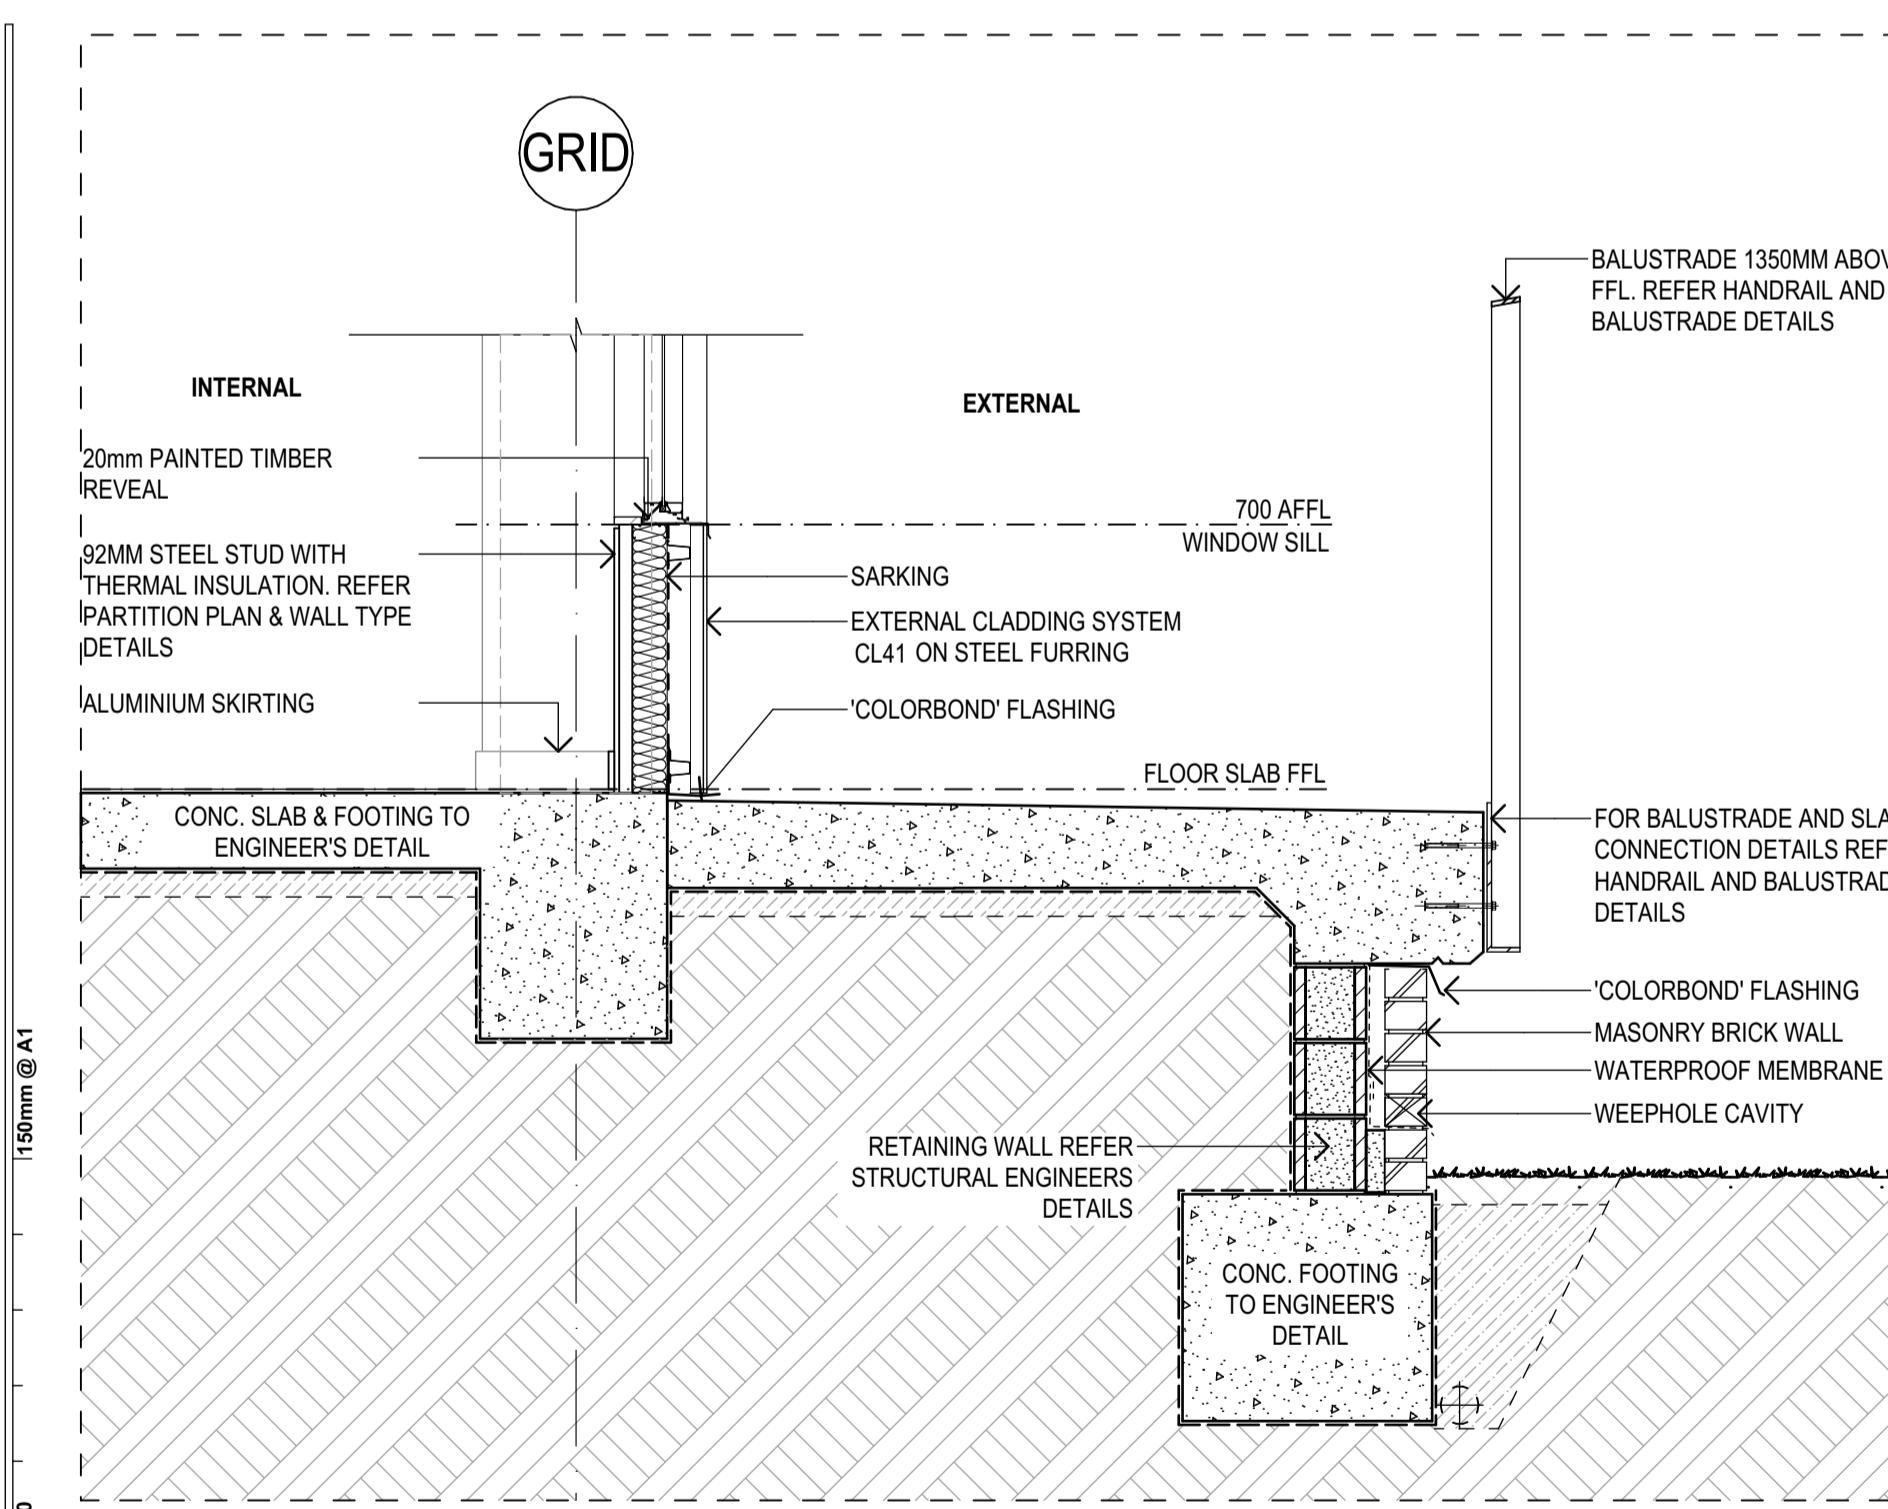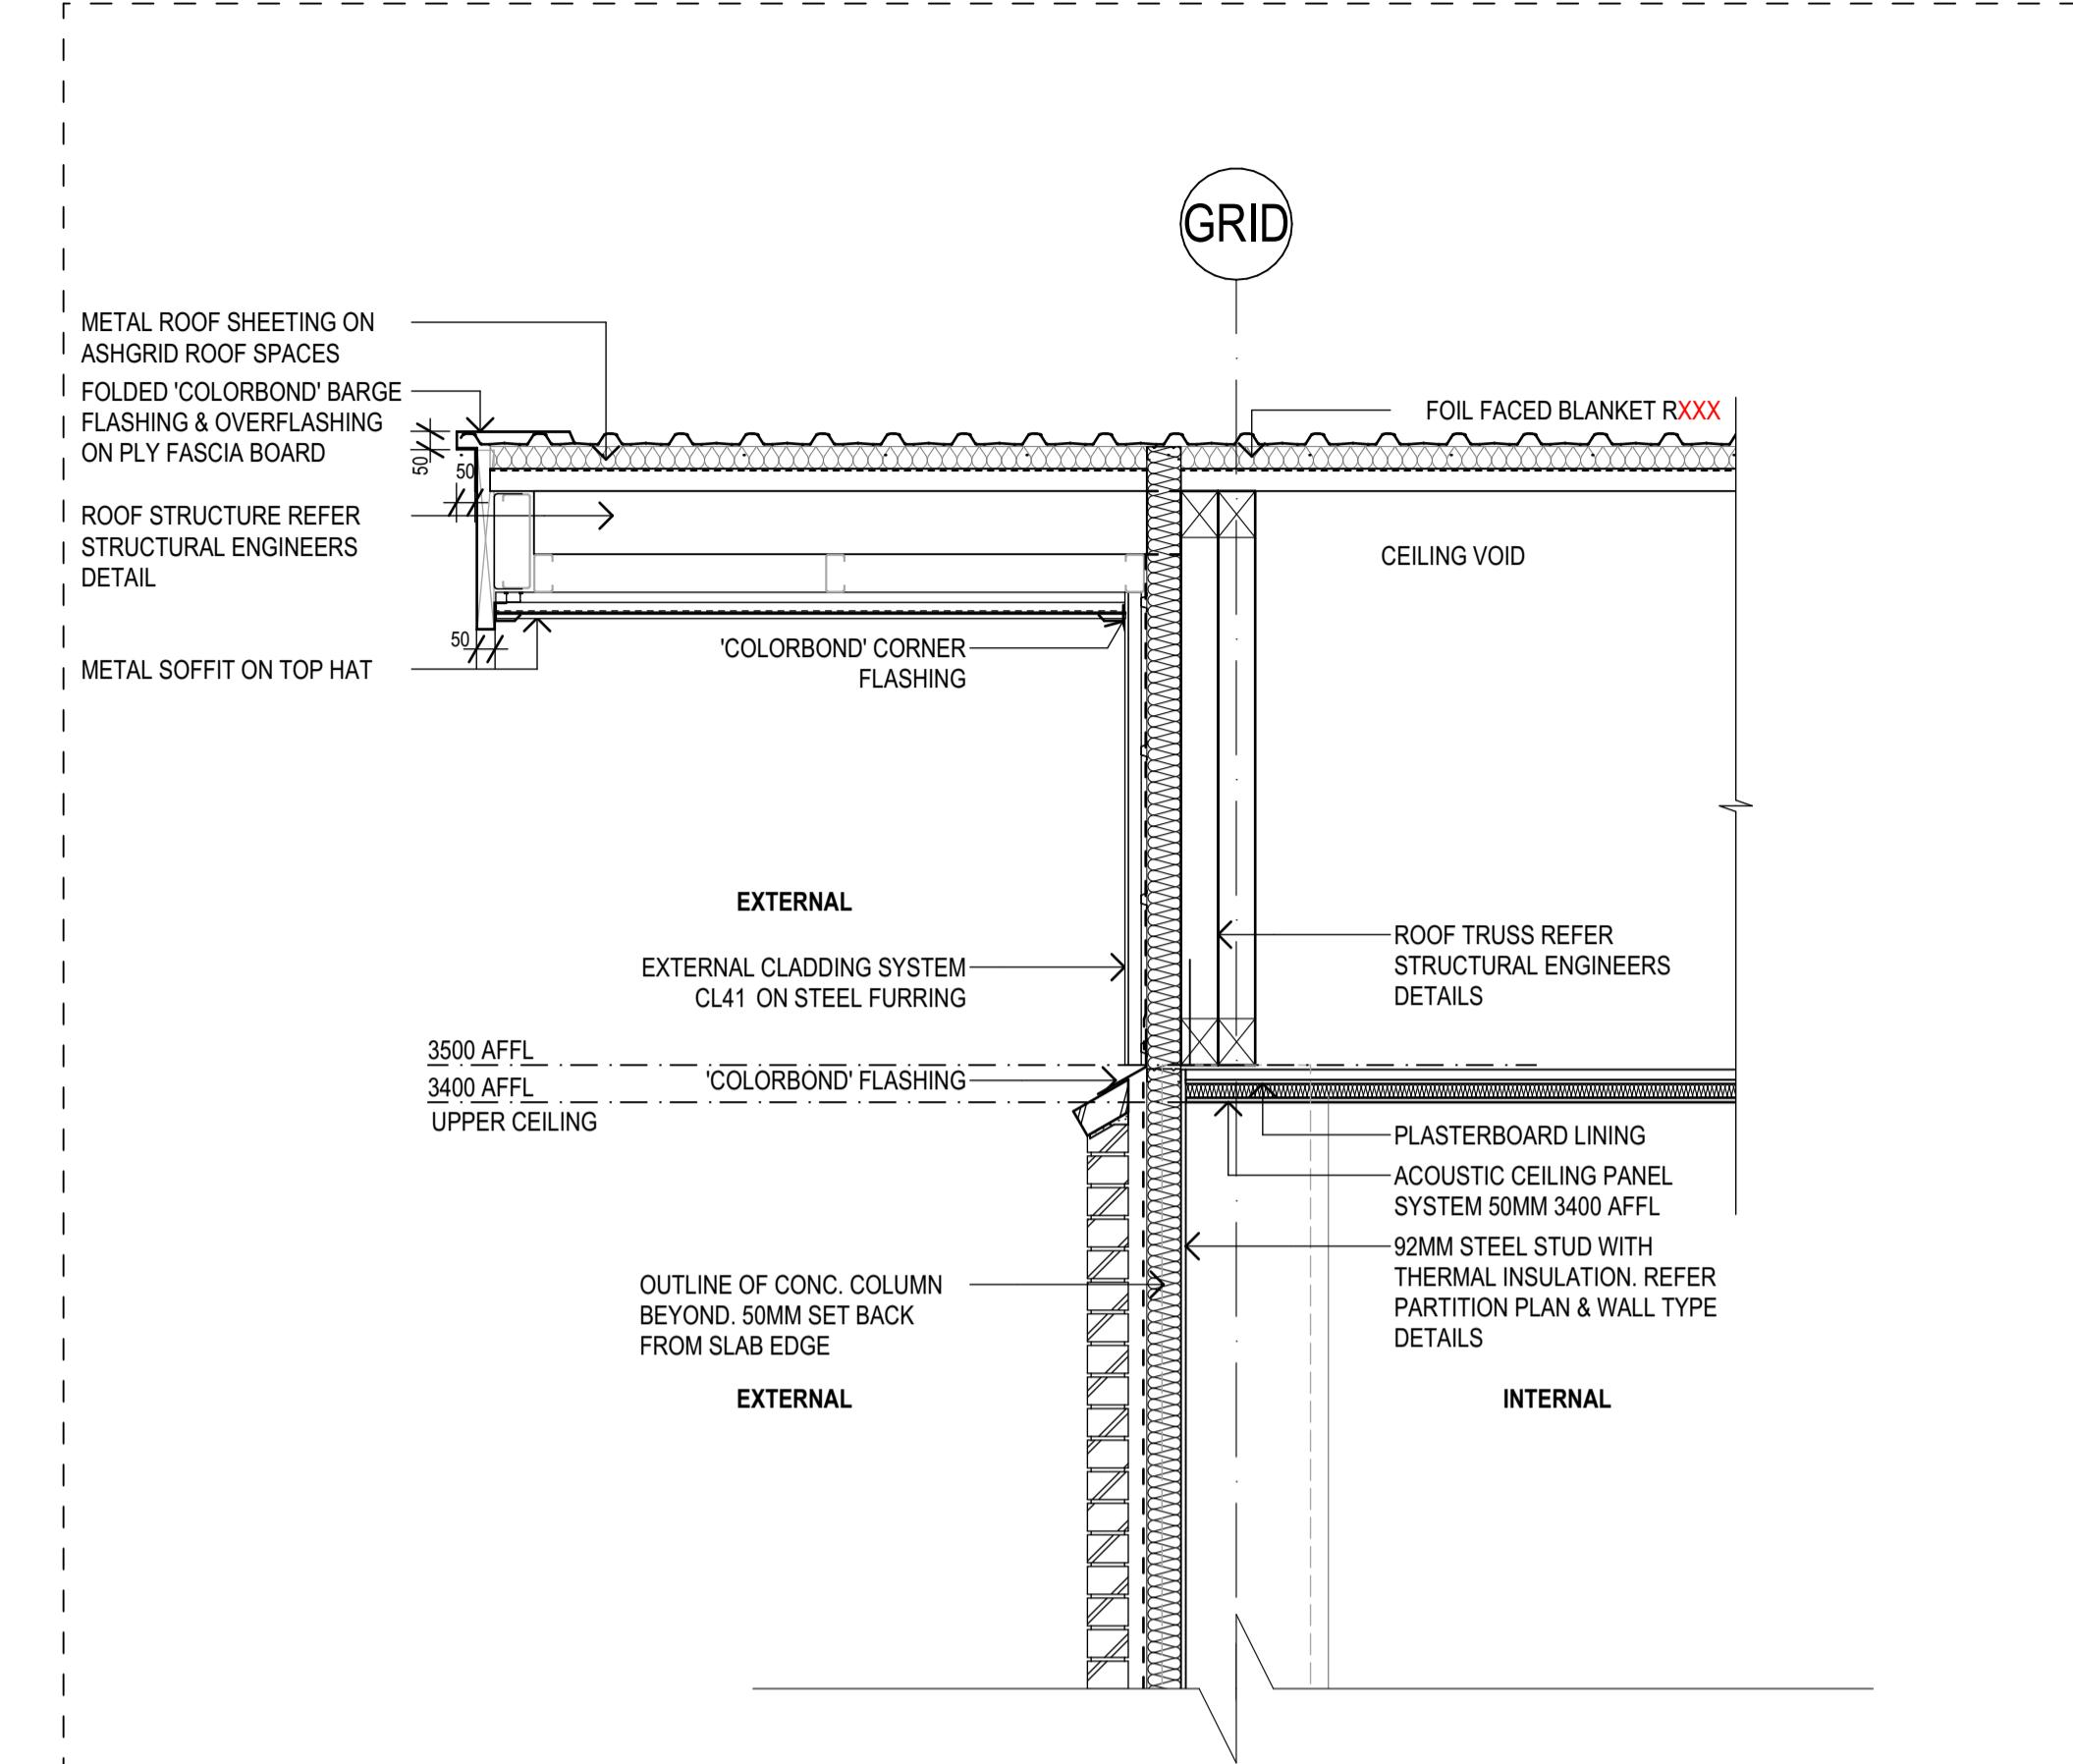

**2** DETAIL SECTION  
VERANDAH DETAIL SECTION  
SCALE: 1:20

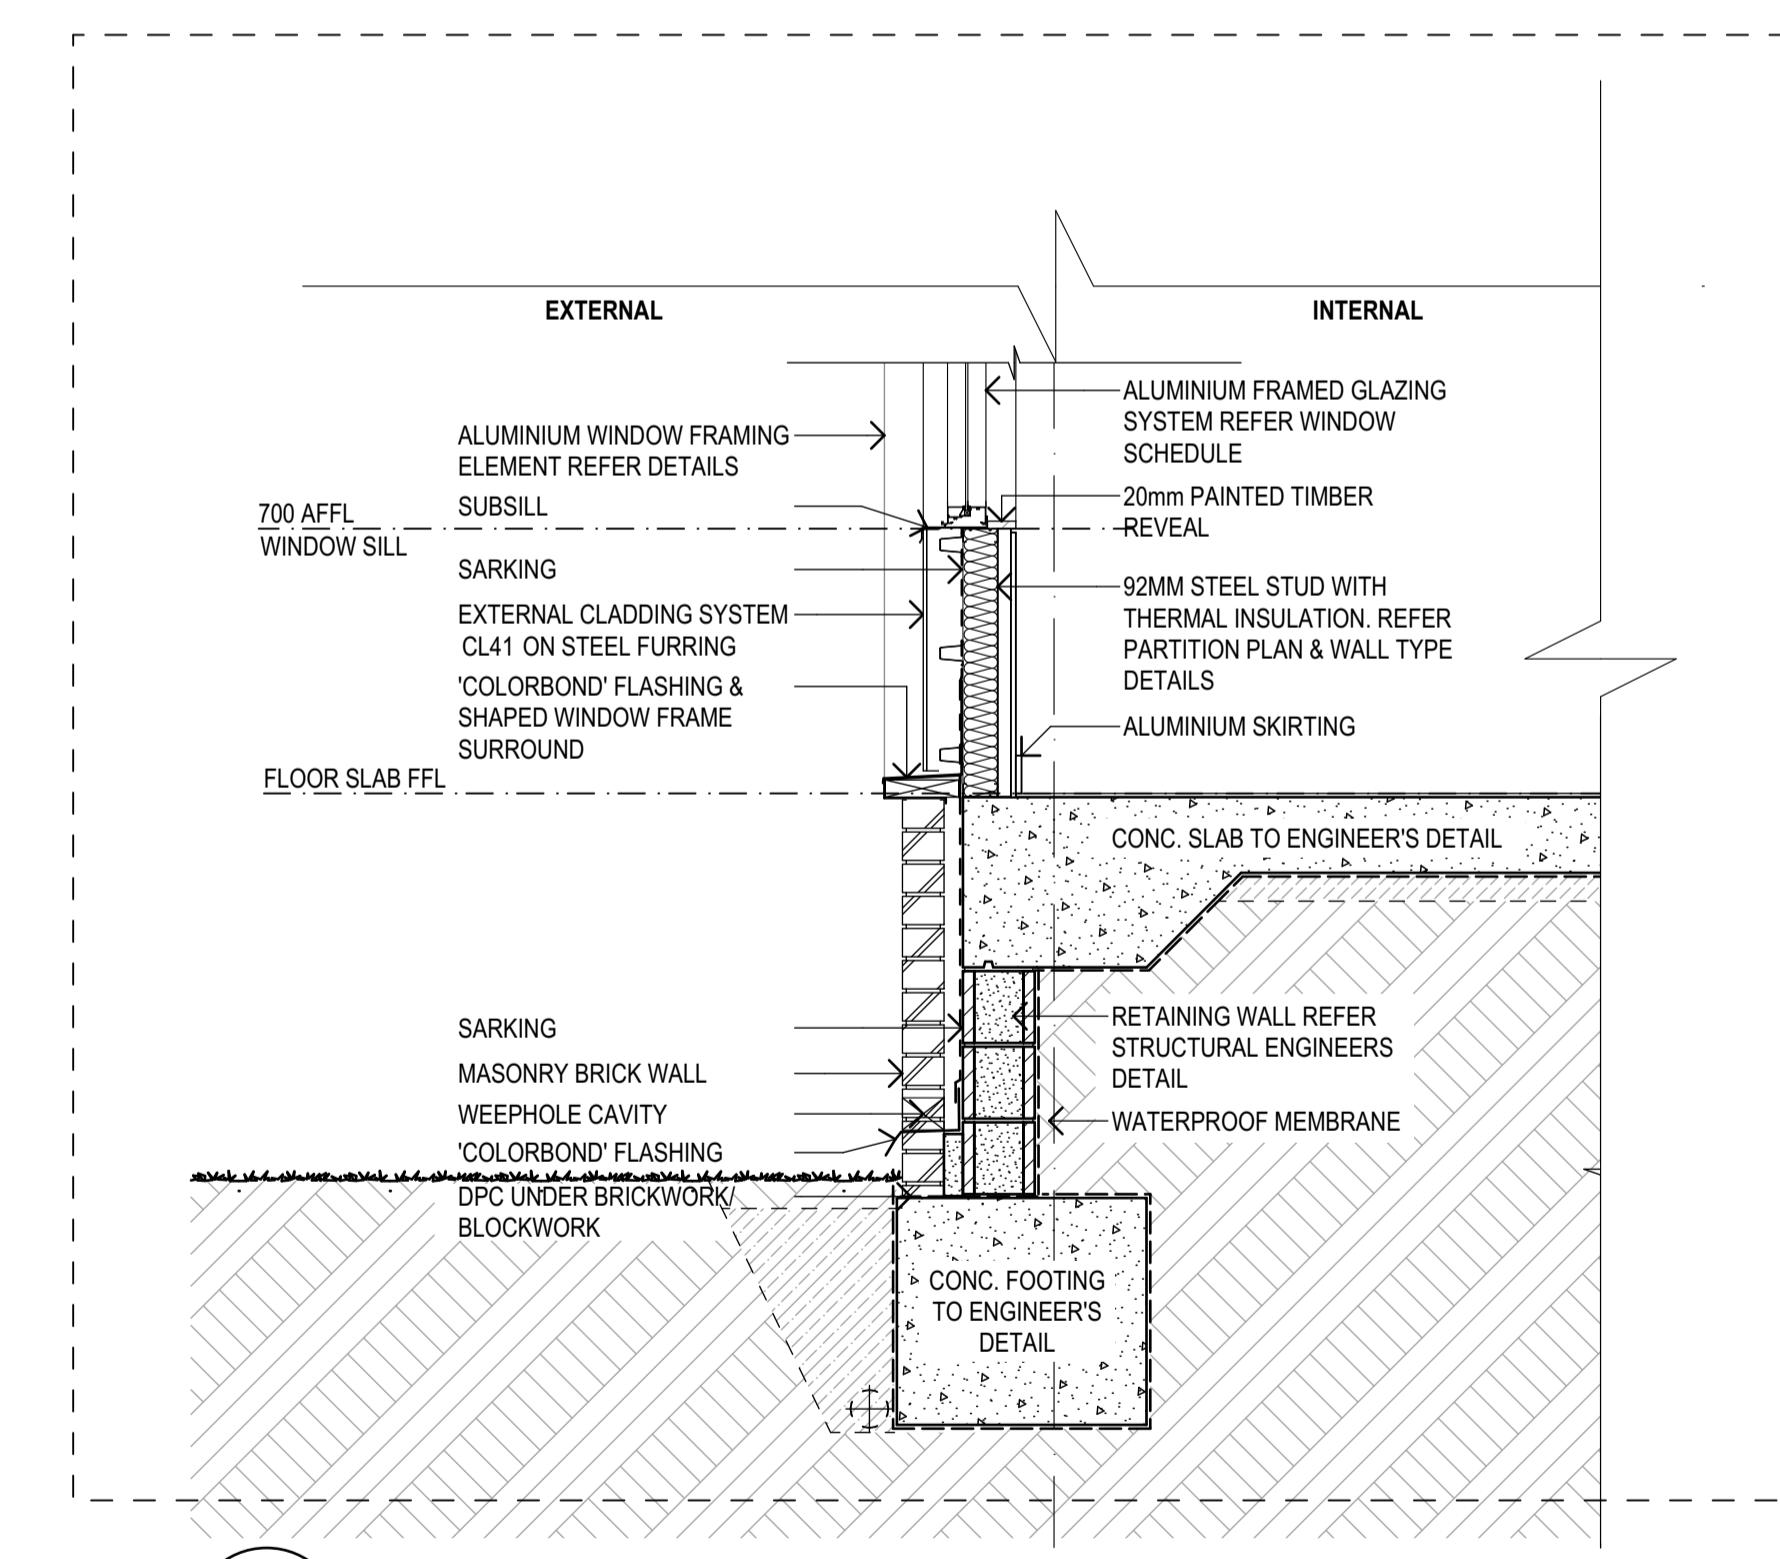

**5** DETAIL SECTION  
FC SIDE WALL SECTION  
SCALE: 1:20

**4** DETAIL SECTION  
BRICK SIDE WALL SECTION  
SCALE: 1:20

REV.	DESCRIPTION	DATE	INIT.
04	100% SCHEMATIC DESIGN	19/12/2024	NK
03	95% SCHEMATIC DESIGN	10/12/2024	AK
02	80% SCHEMATIC DESIGN	26/11/2024	AK
01	SD-01 - 50% SCHEMATIC DESIGN	15/11/2024	AK

**fulton trotter**

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T (02) 8383 5151 E [sydney@fultontrotter.com.au](mailto:sydney@fultontrotter.com.au)

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DIRECTOR Greg Trotter ria  
John Ebenezer ria  
John Ward ria  
Paul Dennis ria  
Ryan Lovelady ria  
VIC 18804 NSW 6855 QLD 2950  
NSW 8371 QLD 3513  
NSW 7434 QLD 4529  
NSW 7789 QLD 4508  
NSW 7790 QLD 4508

PROJECT NUMBER 7068ND01 DIRECTOR JW  
DRAWING NUMBER NPS-FTA-B00T-ZZ-DR-A-4201 REVISION 04  
ADDRESS PROJECT PHASE NORTHMEAD PUBLIC SCHOOL  
MOXHAMS ROAD, NORTHMEAD, NSW  
DATE INIT.




## BUILDING T - WALL SECTIONS 01

Figured dimensions take precedence over scale dimensions. Contractors must verify all dimensions on site before commencing any work or making shop drawings.



PROJECT NUMBER 7068ND01 DIRECTOR JW  
DRAWING NUMBER NPS-FTA-B00T-ZZ-DR-A-4201 REVISION 04

EXTERNAL WALL TYPES						
	E07 Fire Rating - R-Value - Rw + Ctr - Smoke Rating  False	E08 Fire Rating - R-Value - Rw + Ctr - Smoke Rating  False	E23 Fire Rating - R-Value - Rw + Ctr - Smoke Rating  False	E27 Fire Rating - R-Value - Rw + Ctr - Smoke Rating  False	E28 Fire Rating - R-Value - Rw + Ctr - Smoke Rating  False	
INTERNAL WALL TYPES						
	I01 Fire Rating - R-Value - Rw + Ctr - Smoke Rating  False	I05 Fire Rating - R-Value - Rw + Ctr - Smoke Rating  False	I06 Fire Rating - R-Value - Rw + Ctr - Smoke Rating  False	I07 Fire Rating - R-Value - Rw + Ctr - Smoke Rating  False	I11 Fire Rating - R-Value - Rw + Ctr - Smoke Rating  False	I21 Fire Rating - R-Value - Rw + Ctr - Smoke Rating  False

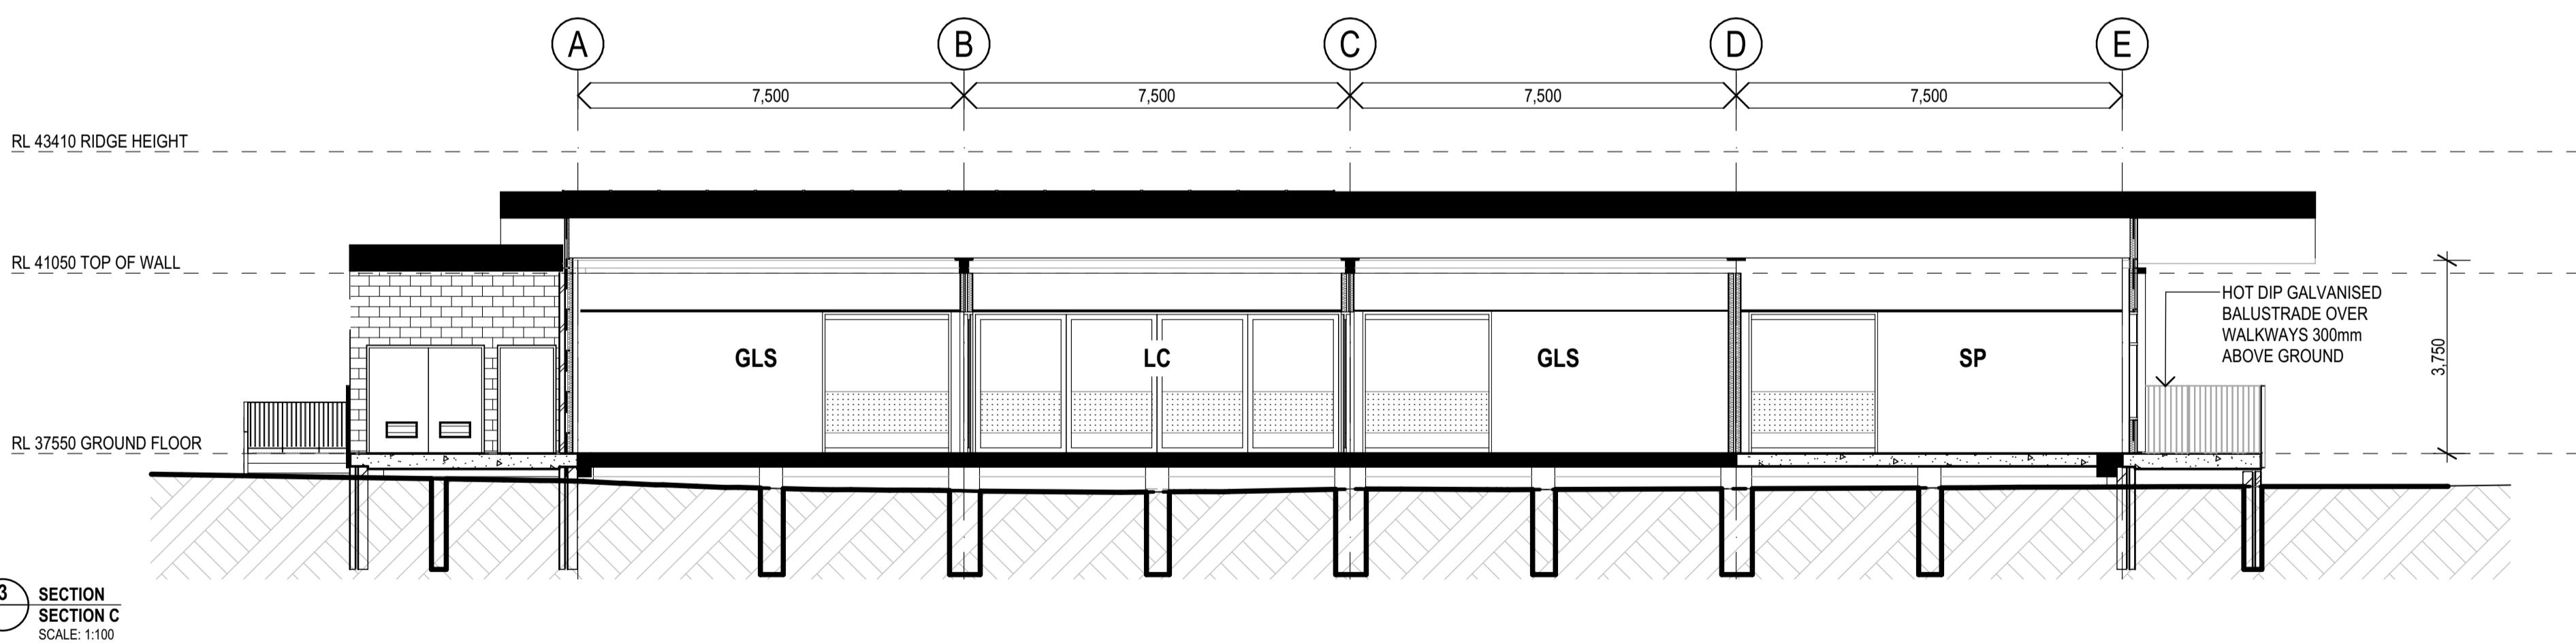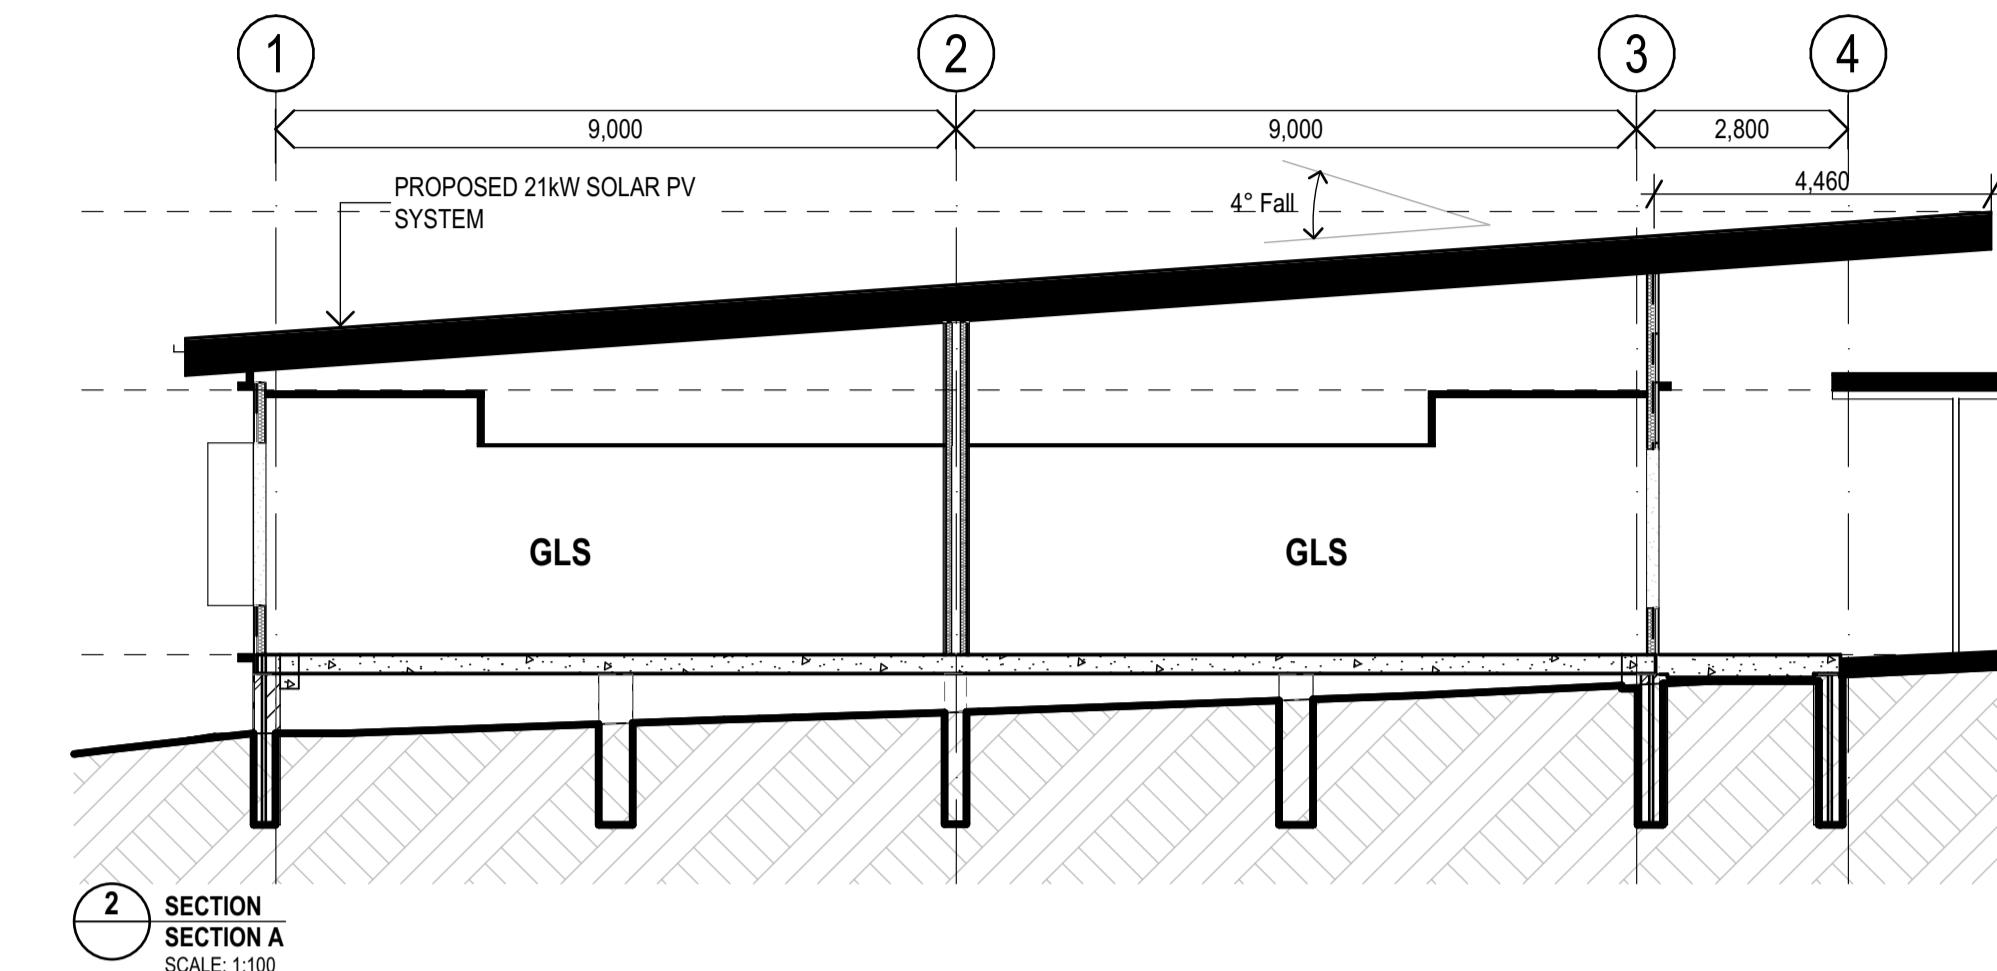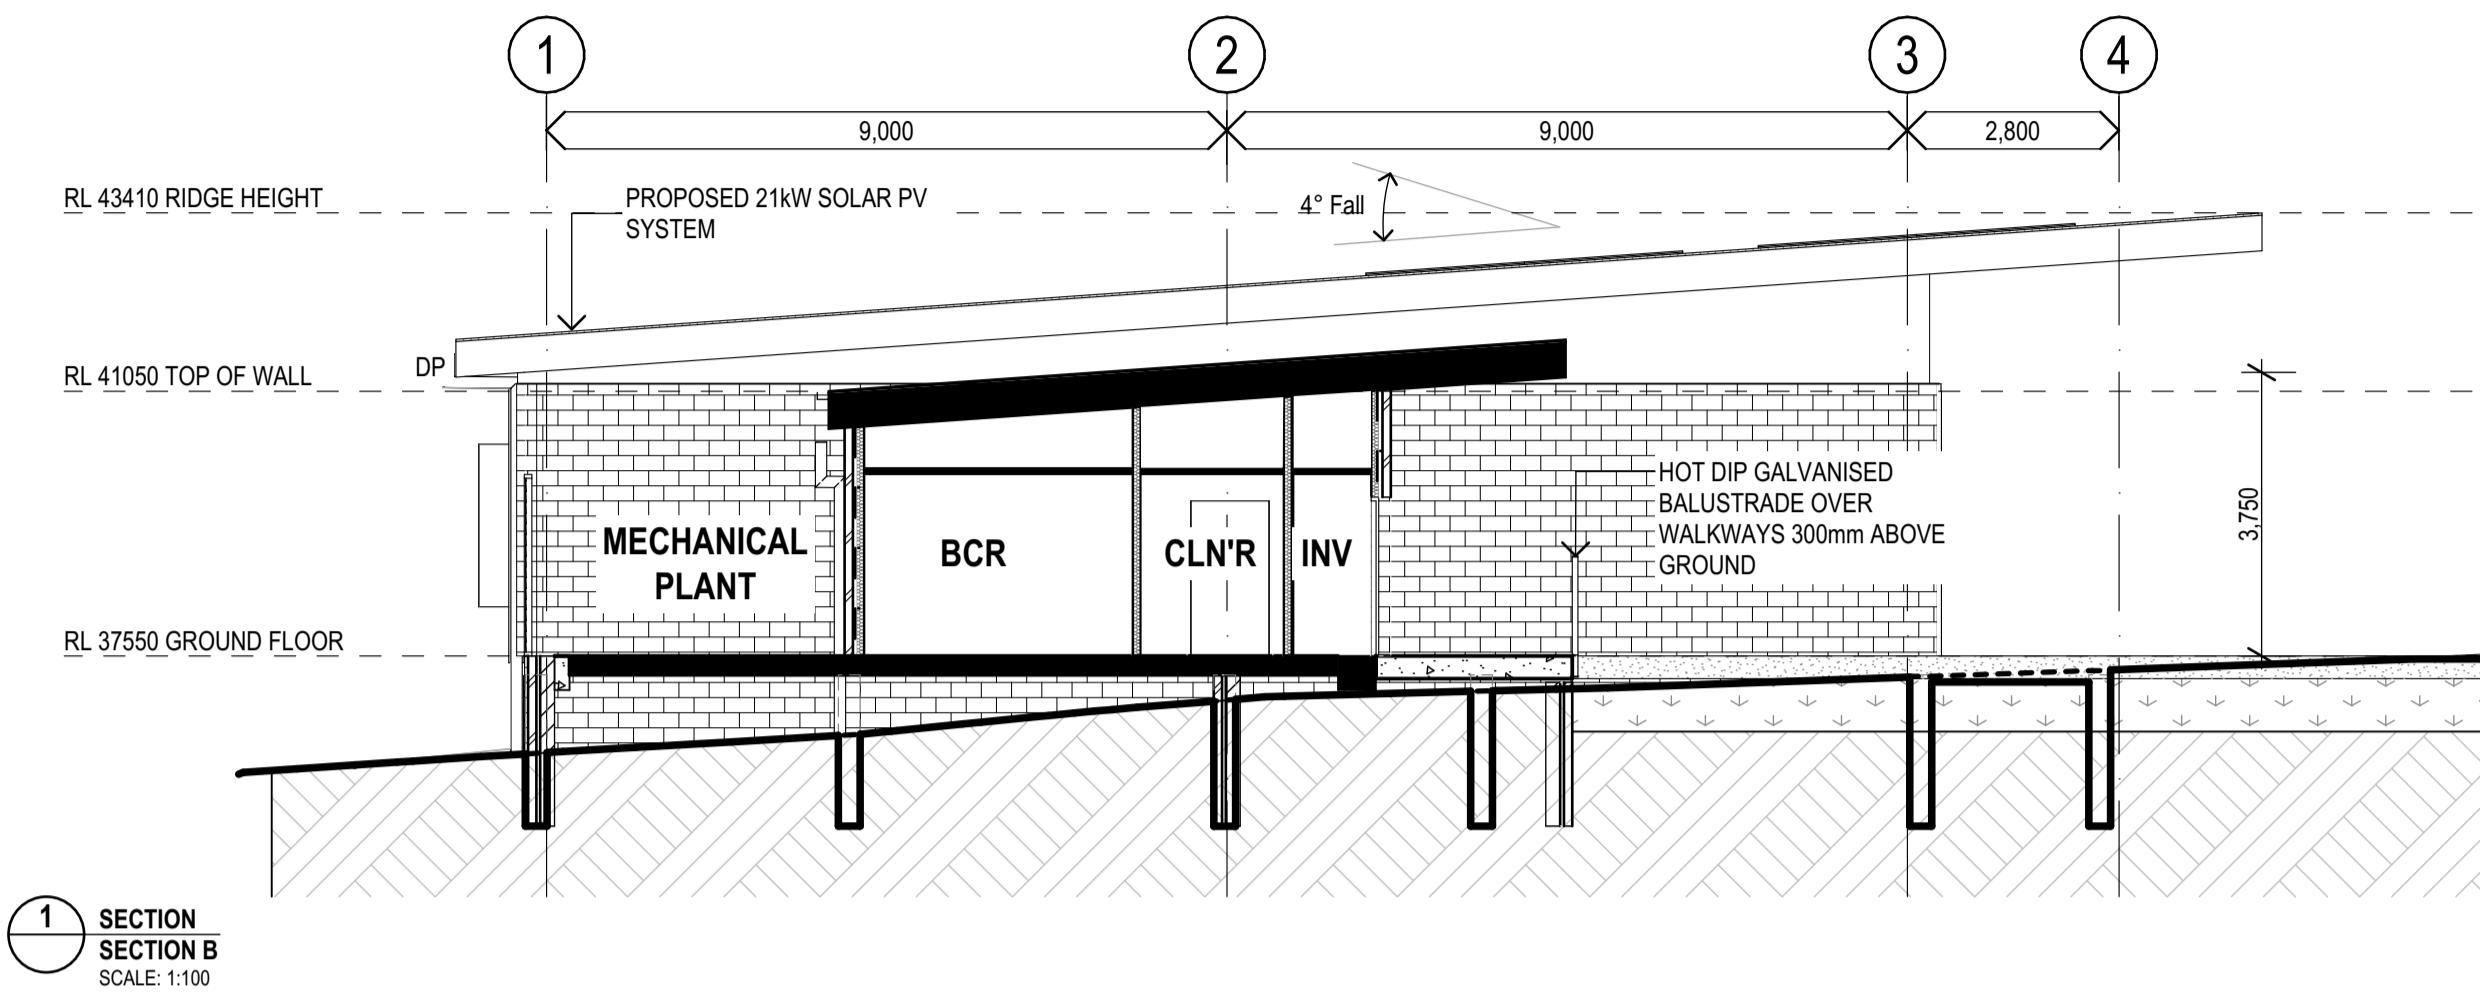

REV.	DESCRIPTION	DATE	INIT.
04	100% SCHEMATIC DESIGN	19/12/2024	AK
03	95% SCHEMATIC DESIGN	10/12/2024	AK
02	80% SCHEMATIC DESIGN	26/11/2024	AK
01	SD-01 - 50% SCHEMATIC DESIGN	15/11/2024	AK
P4	100% CONCEPT DESIGN	31/10/2024	NK
P3	80% CONCEPT DESIGN	18/10/2024	AK
P2	FOR INFORMATION	27/09/2024	AK
P1	FOR INFORMATION	20/09/2024	AK

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John Ward Fraa

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NSW 8371 QLD 3313

NSW 7434 QLD 3847

NSW 7780 QLD 4529

NSW 7788 QLD 4508

VIC 18804 QLD 4500

PHASE  
PROJECT CLIENT  
**SCHEMATIC DESIGN**  
SCHOOL INFRASTRUCTURE  
NSW

PROJECT NUMBER  
**7068ND01**

DIRECTOR  
**JW**

REVISION  
**NK**

DRAWING NUMBER  
**NPS-FTA-B00T-ZZ-DR-A-3303**



Figured dimensions take precedence over  
scale dimensions. Contractors must verify  
all dimensions on site before commencing  
any work or making shop drawings.

PROJECT NUMBER  
**7068ND01**

DIRECTOR  
**JW**

REVISION  
**NK**

CHECKED  
**04**

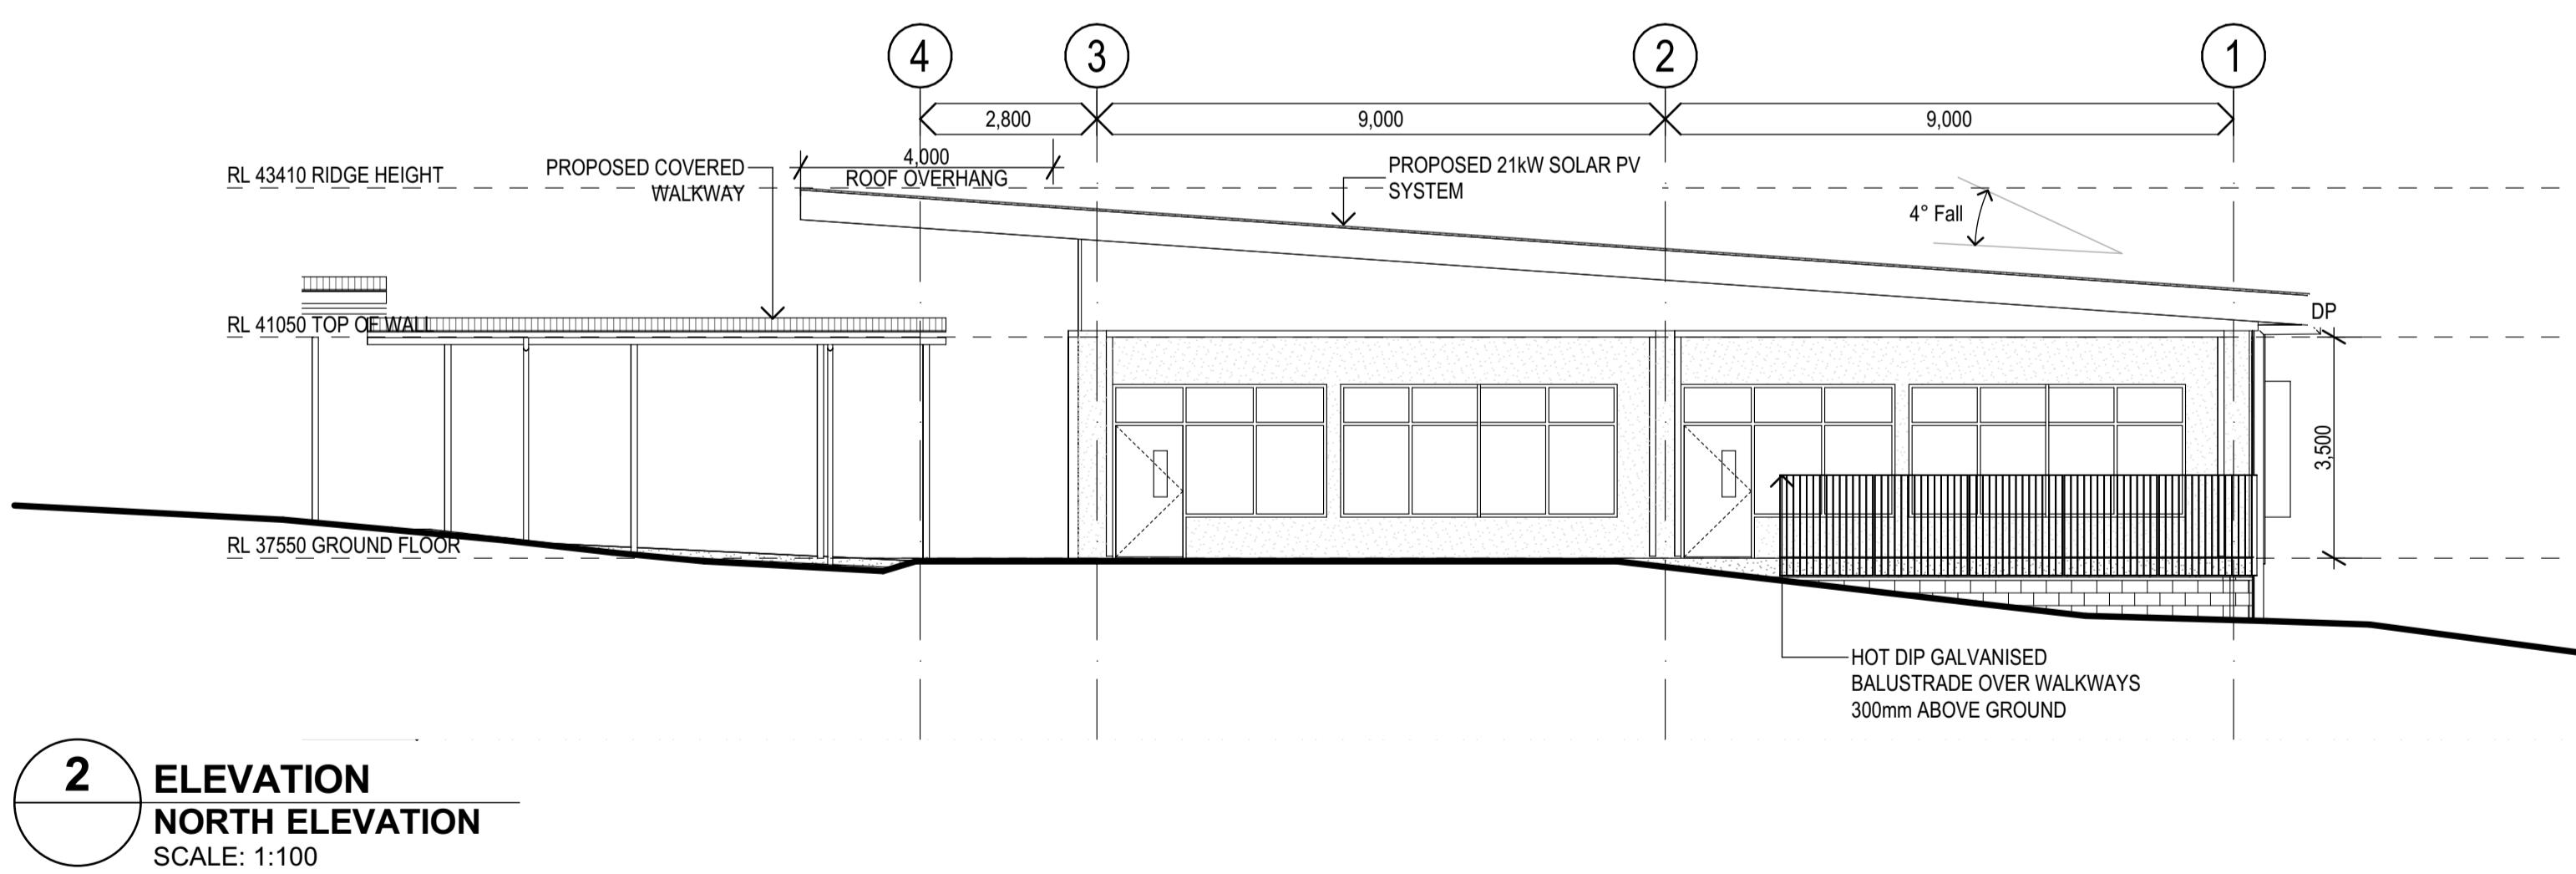
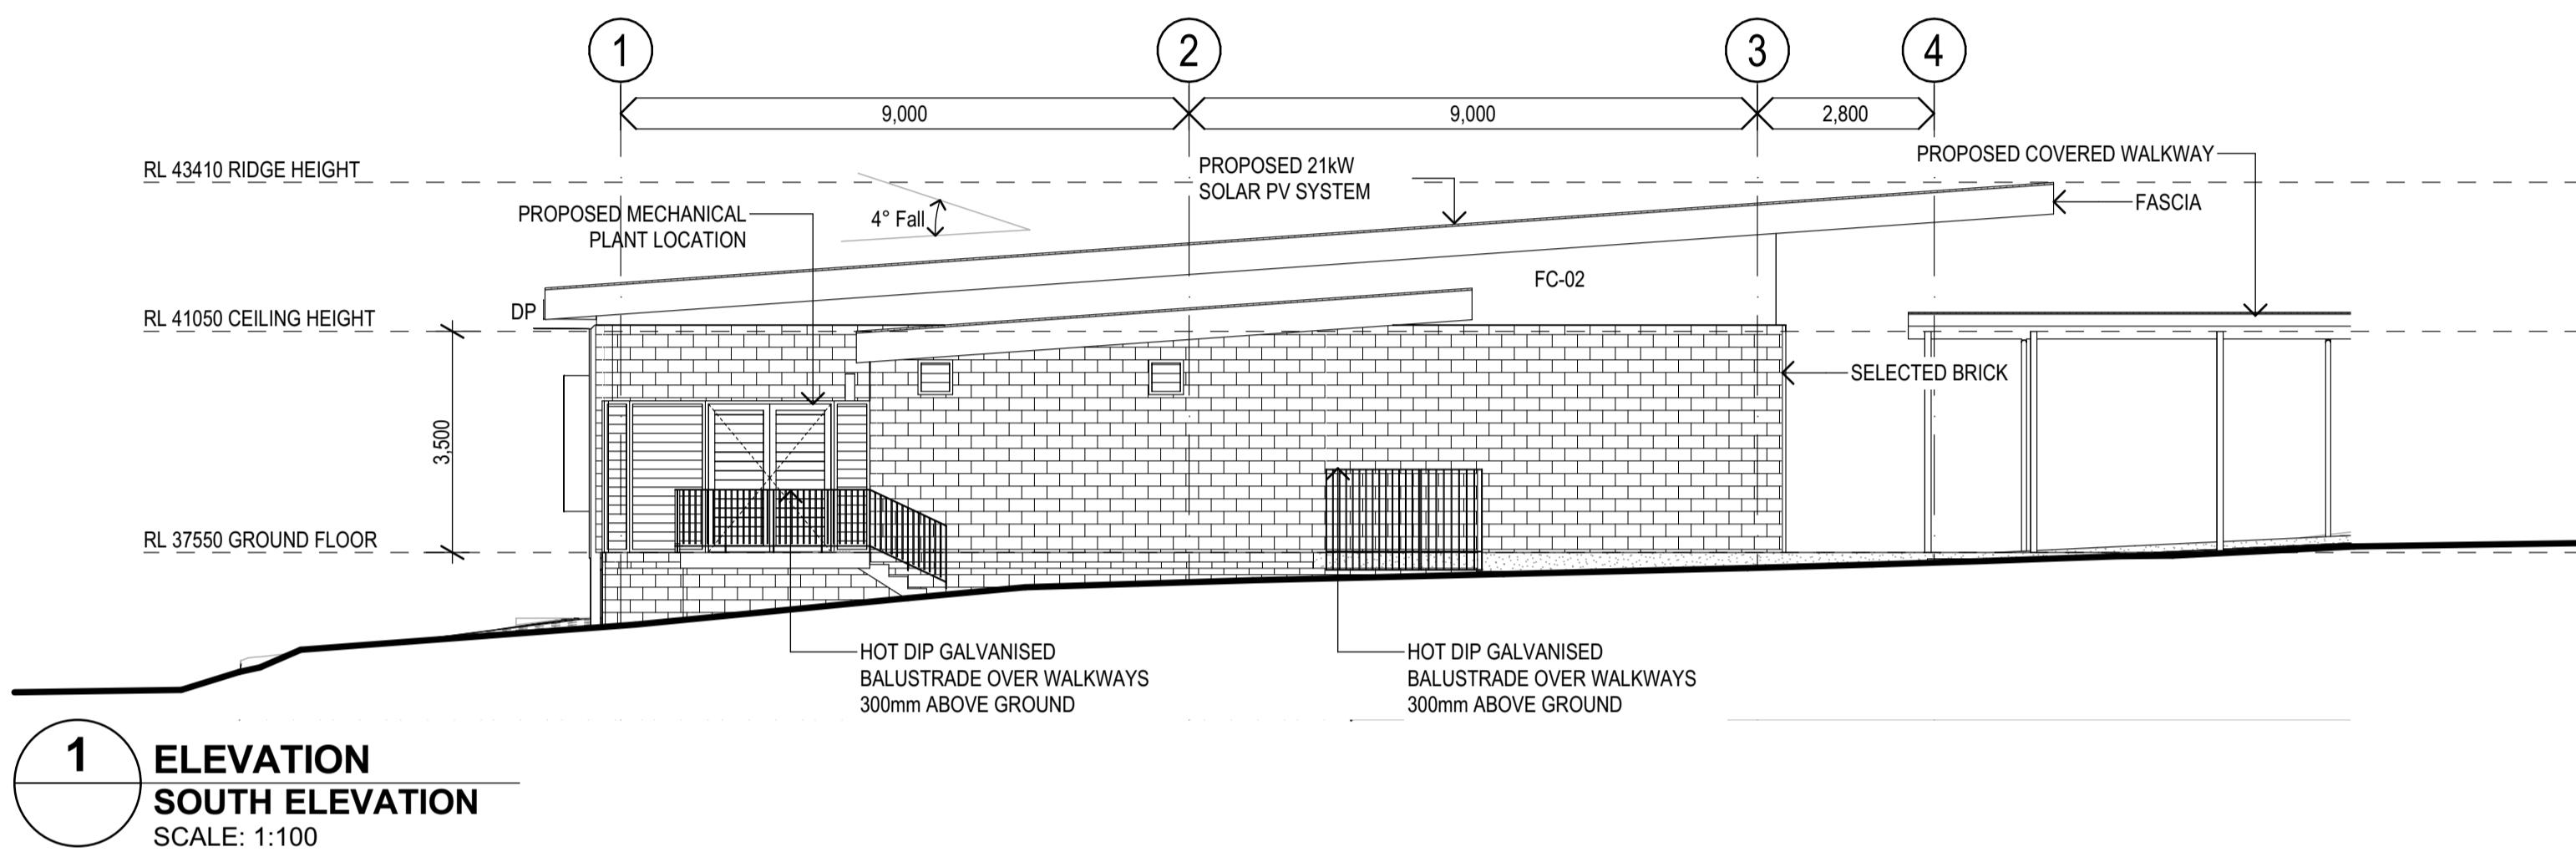


REV.	DESCRIPTION	DATE	INIT.
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03	95% SCHEMATIC DESIGN	10/12/2024	AK
02	80% SCHEMATIC DESIGN	26/11/2024	AK
01	SD-01 - 50% SCHEMATIC DESIGN	15/11/2024	AK
P4	100% CONCEPT DESIGN	31/10/2024	NK
P3	80% CONCEPT DESIGN	18/10/2024	AK
P2	FOR INFORMATION	27/09/2024	AK
P1	FOR INFORMATION	20/09/2024	AK

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NSW 6855 QLD 2950  
VIC 18804 NSW 8371 QLD 3847  
NSW 7434 QLD 4529  
NSW 7780 QLD 4508  
NSW 7780 QLD 4508

**SCHEMATIC DESIGN**  
SCHOOL INFRASTRUCTURE  
NSW  
PROJECT NUMBER: NPS-FTA-B00T-ZZ-DR-A-3202  
DRAWING NUMBER: NPS-FTA-B00T-ZZ-DR-A-3202  
REV.: 04  
PHASE: PROJECT  
CLIENT: NORTHMEAD PUBLIC SCHOOL  
ADDRESS: MOXHAMS ROAD,  
NORTHMEAD, NSW

**BUILDING T - ELEVATIONS**  
Figured dimensions take precedence over  
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any work or making shop drawings.  
PROJECT NUMBER: 7068ND01 DIRECTOR: JW  
DRAWING NUMBER: NPS-FTA-B00T-ZZ-DR-A-3202  
REVISION: 04  
CHECKED: NK

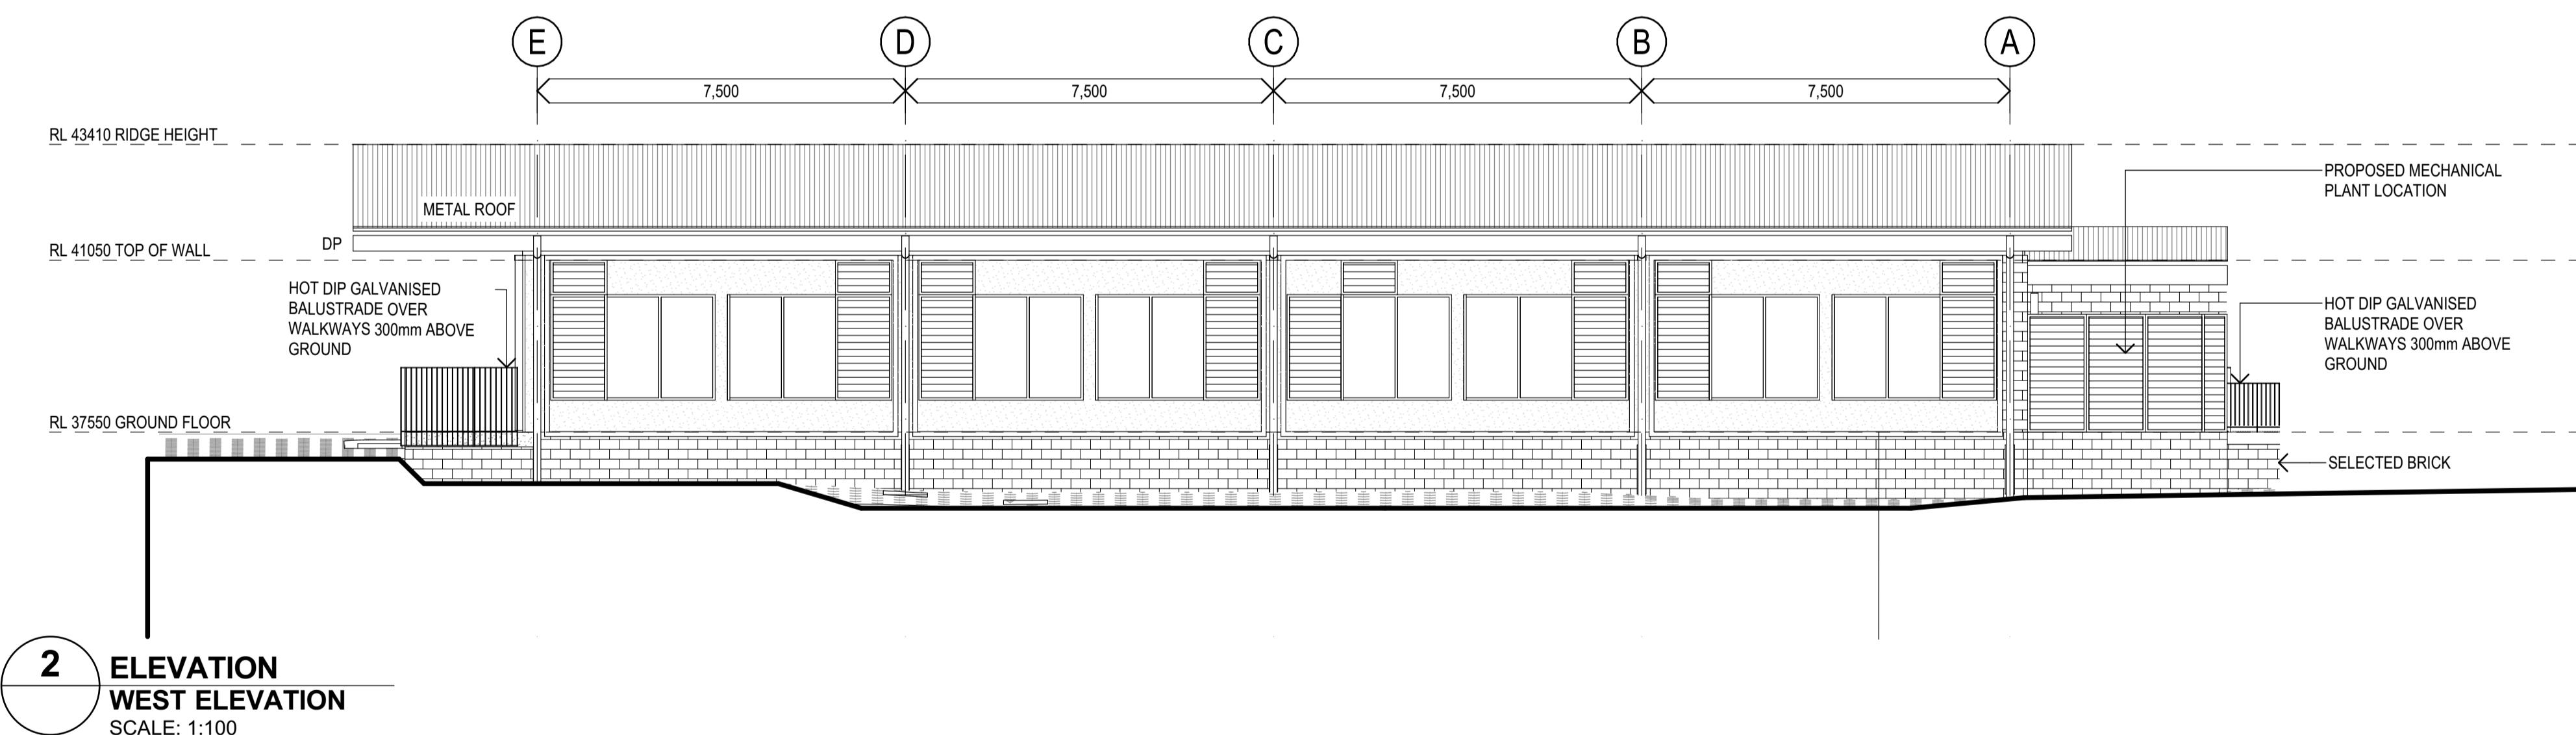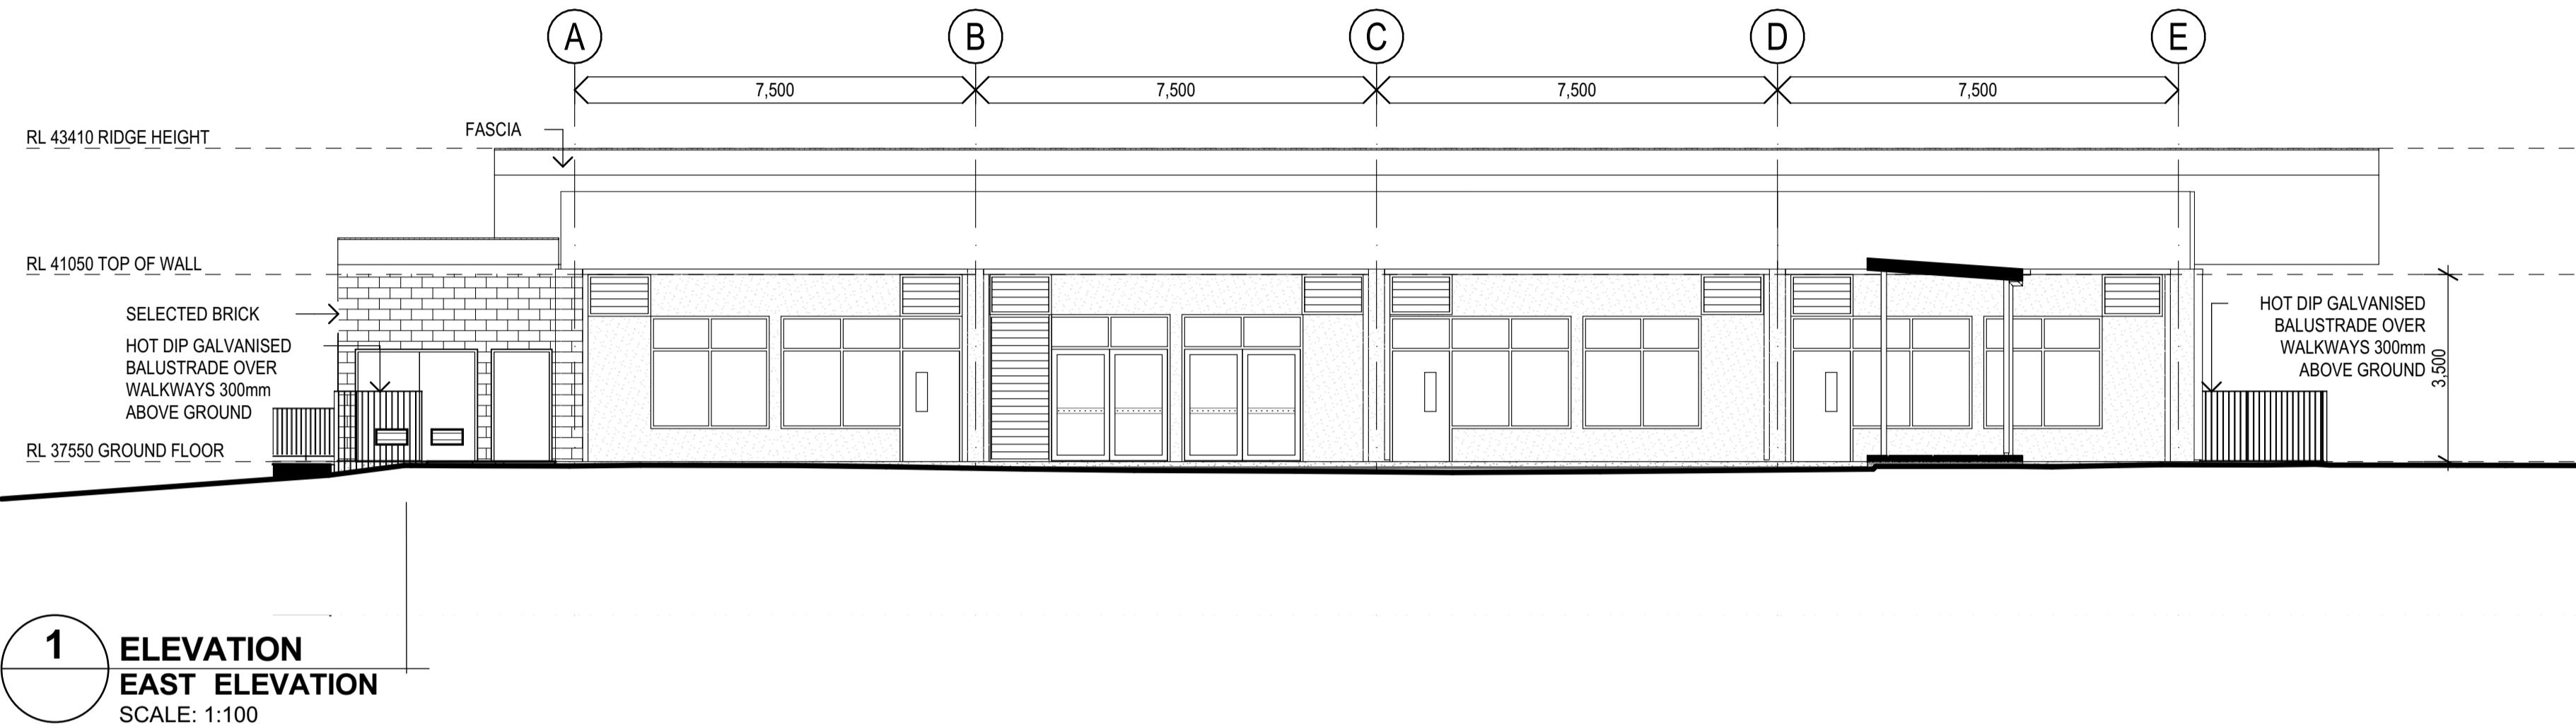

04	100% SCHEMATIC DESIGN	19/12/2024	AK
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02	80% SCHEMATIC DESIGN	26/11/2024	AK
01	SD-01 - 50% SCHEMATIC DESIGN	15/11/2024	AK
P4	100% CONCEPT DESIGN	31/10/2024	NK
P3	80% CONCEPT DESIGN	18/10/2024	AK
P2	FOR INFORMATION	27/09/2024	AK
P1	FOR INFORMATION	20/09/2024	AK
REV.	DESCRIPTION	DATE	INIT.


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NSW 7434 QLD 4529  
NSW 7780 QLD 4518  
NSW 7780 QLD 4500

PHASE  
**SCHEMATIC DESIGN**  
SCHOOL INFRASTRUCTURE  
NSW  
PROJECT NUMBER: **7068ND01**  
CLIENT: **NORTHMEAD PUBLIC SCHOOL**  
ADDRESS: **MOXHAMS ROAD,  
NORTHMEAD, NSW**

BUILDING T - ELEVATIONS  
Figured dimensions take precedence over scale dimensions. Contractors must verify all dimensions on site before commencing any work or making shop drawings.  
PROJECT NUMBER: **7068ND01** DIRECTOR: **JW** CHECKED: **NK**  
DRAWING NUMBER: **NPS-FTA-B00T-ZZ-DR-A-3201** REVISION: **04**



**ROOF PLAN LEGEND**

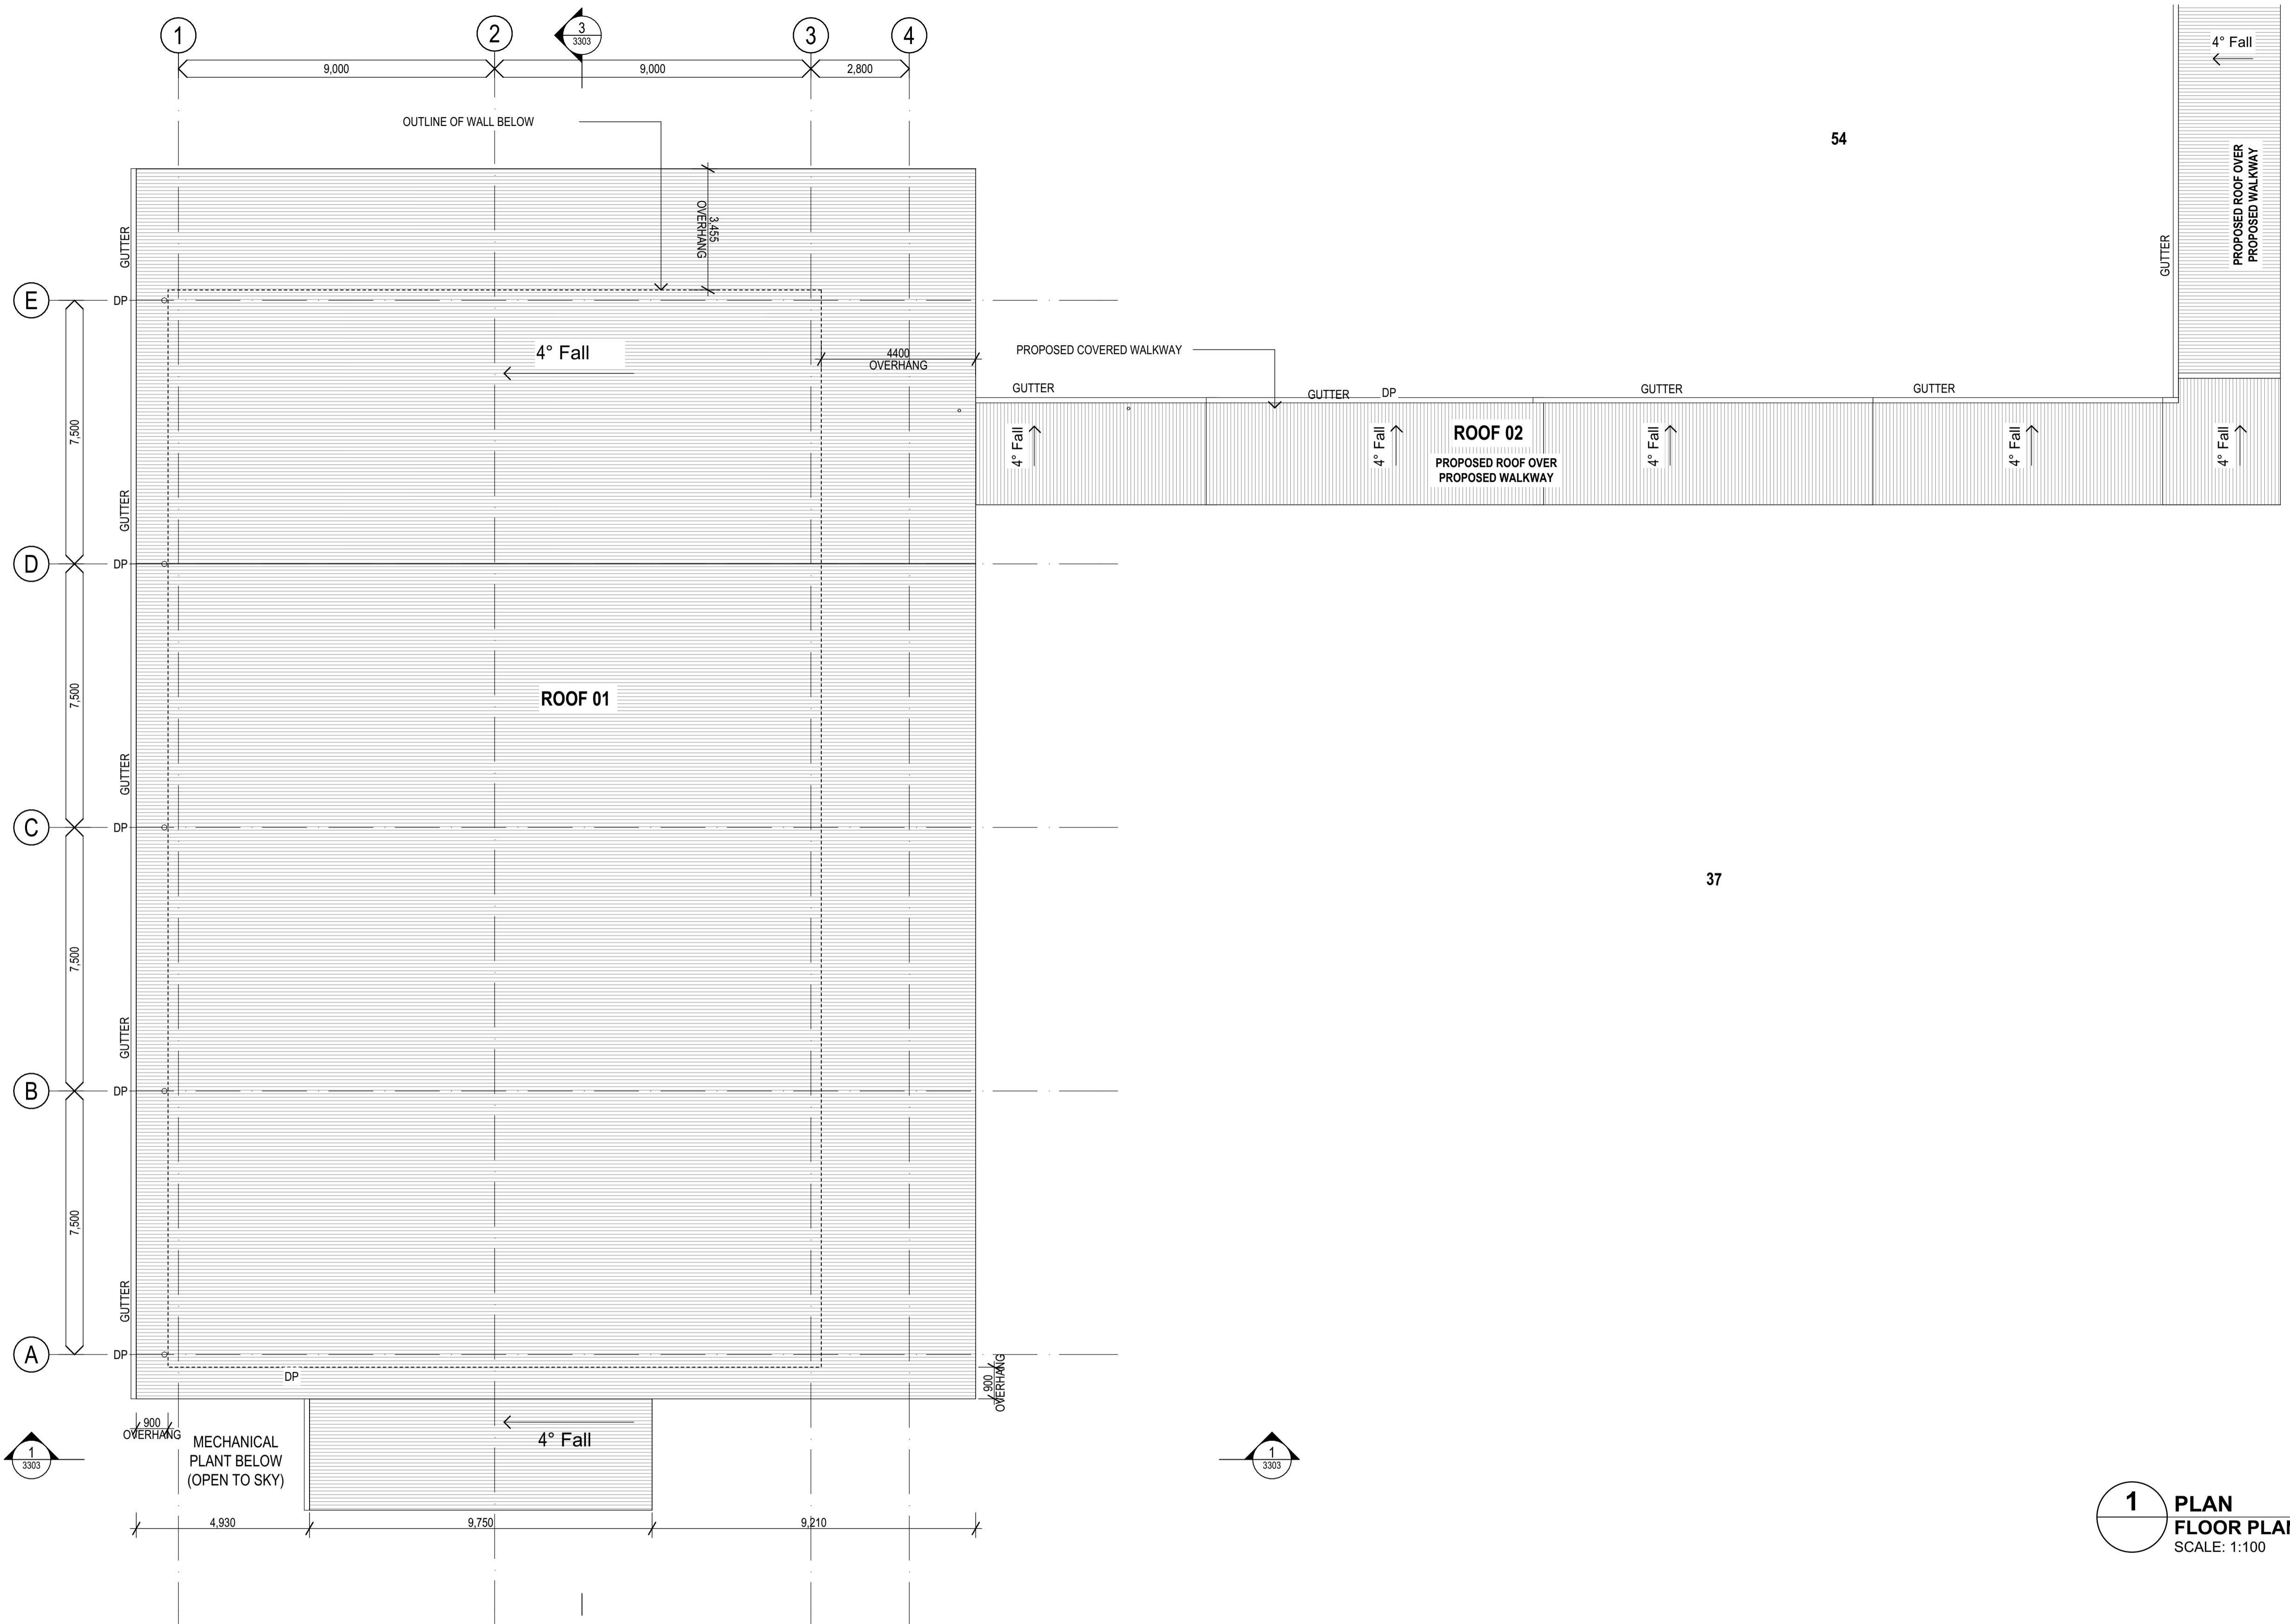**ROOF LABEL**

OF 1 ← ROOF NUMBER

: XX00 ← FINISH CODE (REFER TO FINISHES LEGEND)

— MATERIAL CODE (REFER TO MATERIAL LEGEND)

L 5° → FALL IN ROOF

37

**1 PLAN FLOOR PLAN ROOF**

REV.	DESCRIPTION	DATE	INIT.
04	100% SCHEMATIC DESIGN	19/12/2024	NK
03	95% SCHEMATIC DESIGN	10/12/2024	AK
02	80% SCHEMATIC DESIGN	26/11/2024	AK
01	SD-01 - 50% SCHEMATIC DESIGN	15/11/2024	AK
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P2	FOR INFORMATION	27/09/2024	AK
P1	FOR INFORMATION	20/09/2024	AK
REV.		DATE	

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Katerina Dracopoulos fraia VIC 18804 NSW 7434 QLD 4529

Paul Sekava fraia NSW 7180 QLD 3100  
Ryan Loveday fraia QLD 4500

PHASE | SCHEMATIC DESIGN

CLIENT | SCHOOL INFRASTRUCTURE NSW


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PROJECT | NORTHMEAD PUBLIC SCHOOL

---

ADDRESS | MOXHAMS ROAD,  
NORTHMEAD, NSW

<b>BUILDING T - ROOF PLAN</b>		
Figured dimensions take precedence over scale dimensions. Contractors must verify all dimensions on site before commencing any work or making shop drawings.		
PROJECT NUMBER <b>7068ND01</b>	DIRECTOR <b>JW</b>	CHECKED <b>NK</b>
RAWING NUMBER		REVISION <b>0</b>
<b>NPS-FTA-B00T-LR-DR-A-2102</b>		

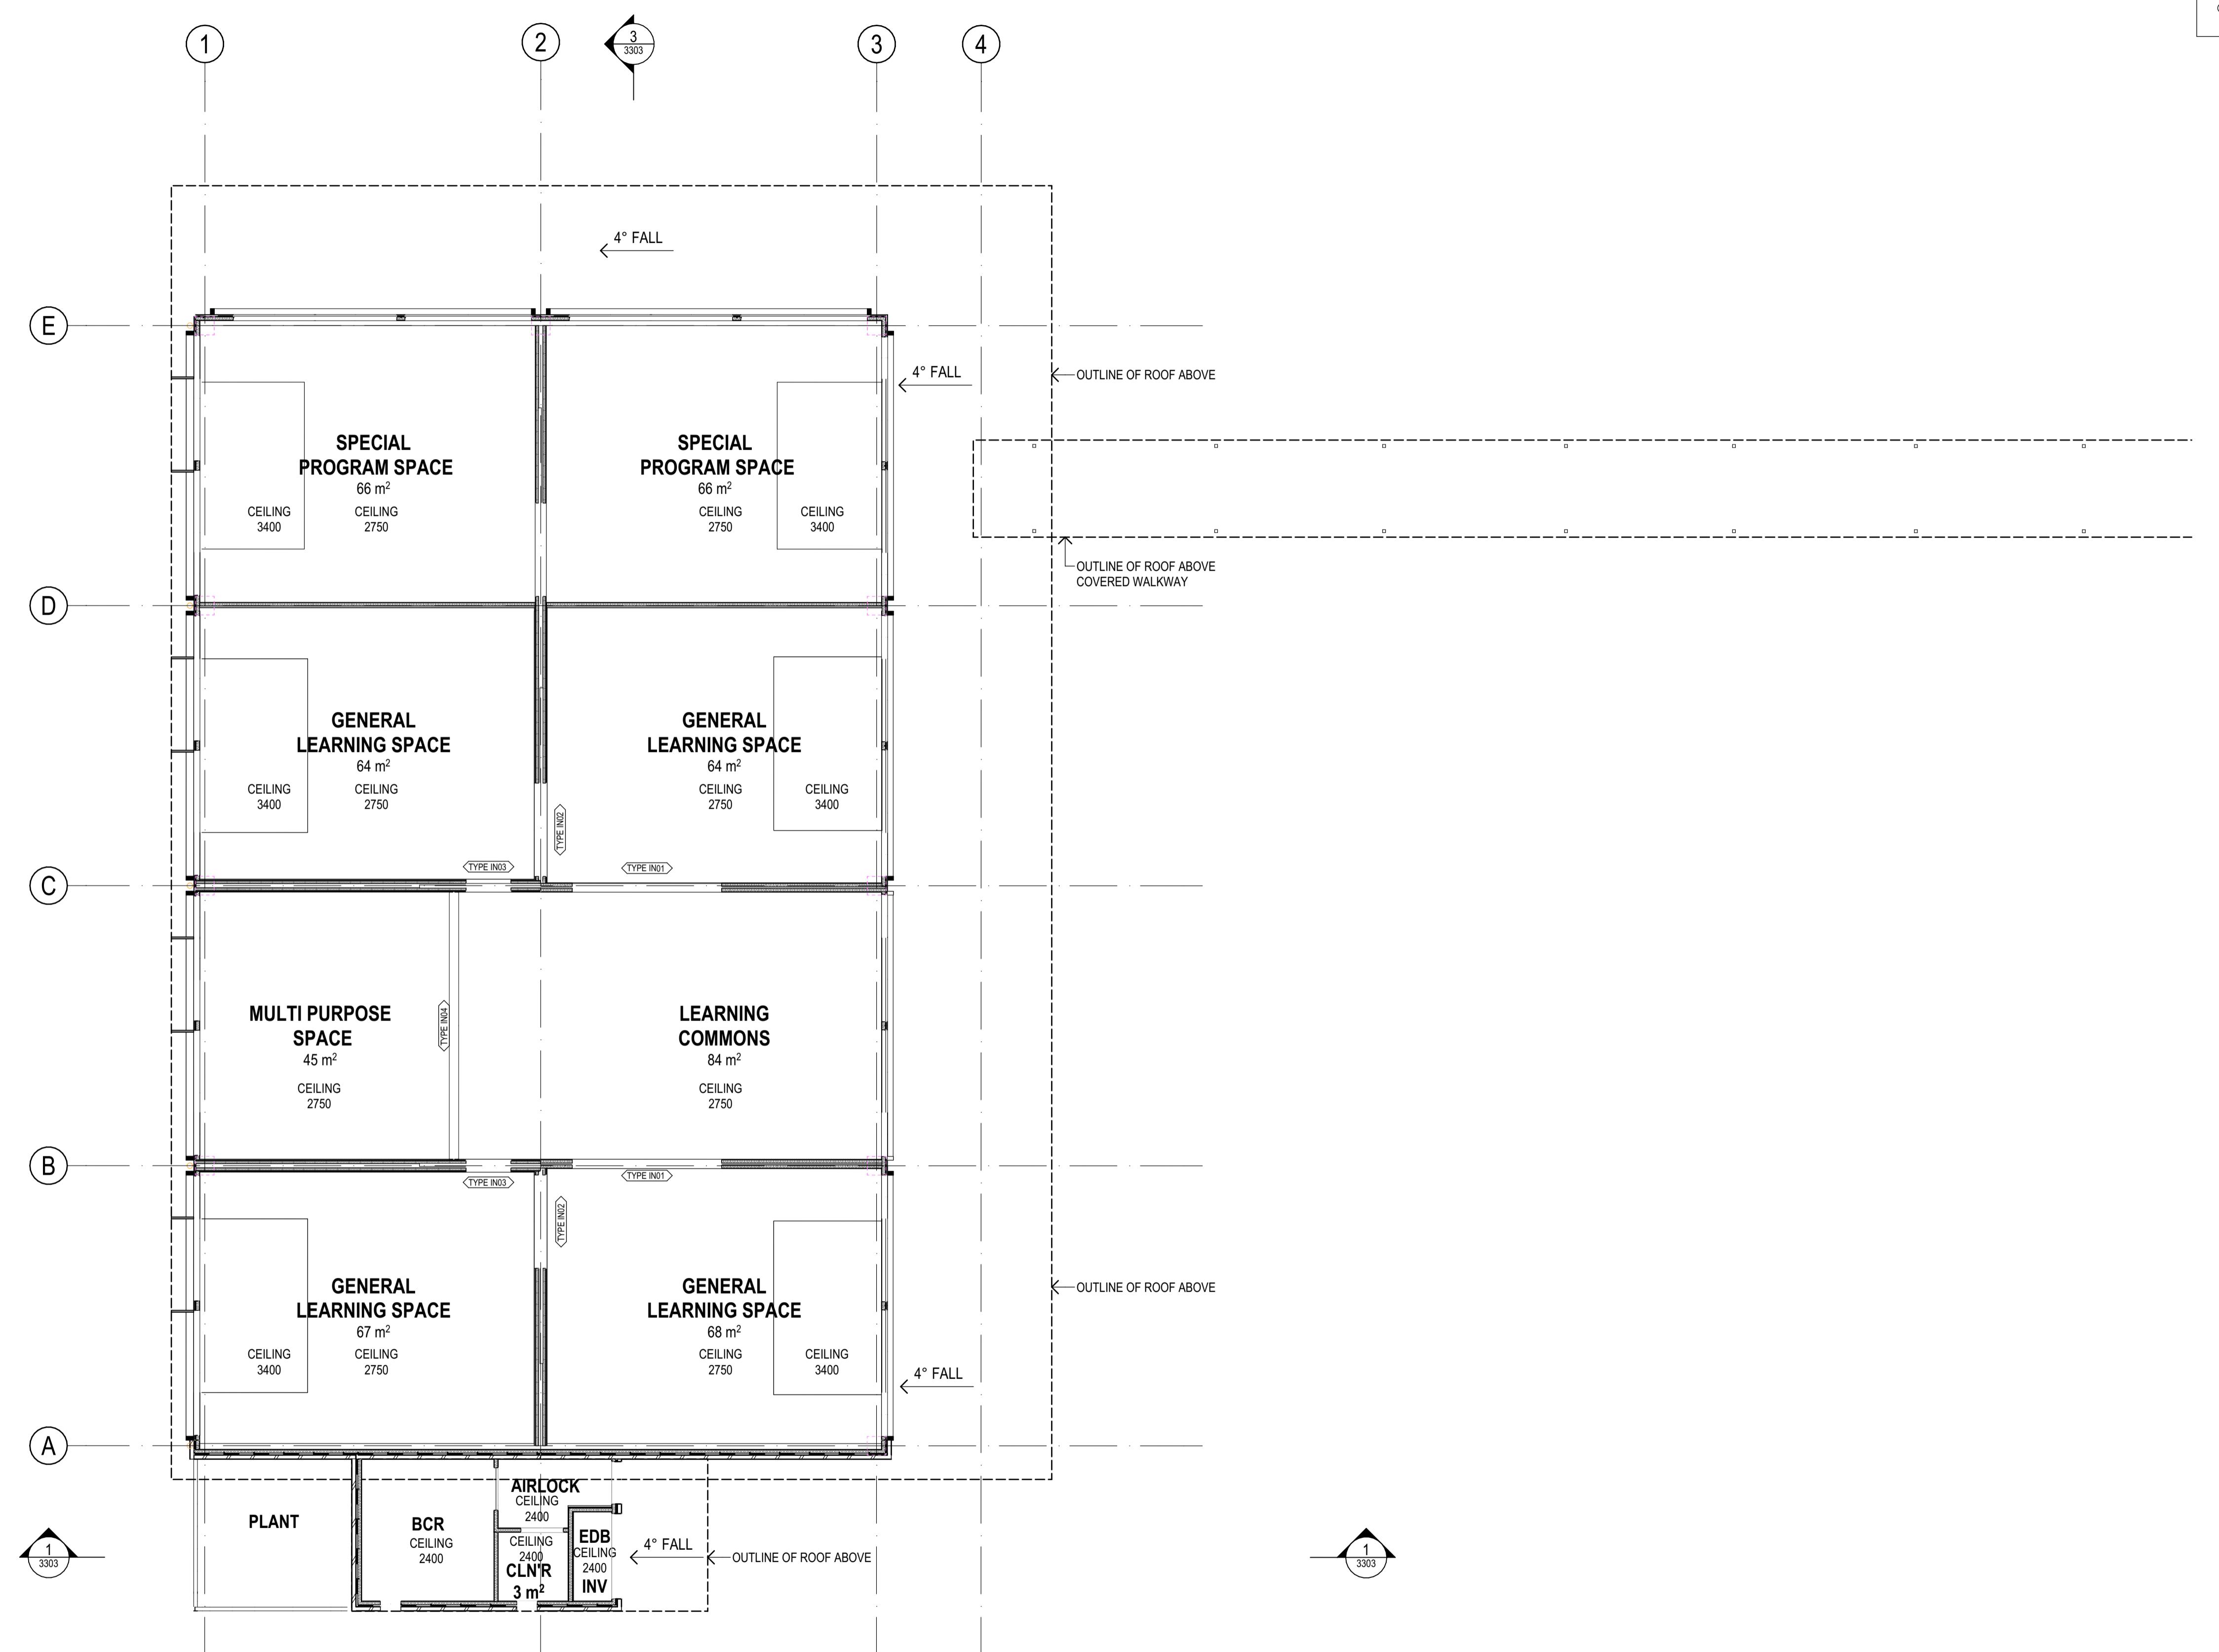

**1 PLAN  
CEILING PLAN BUILDING T GROUND FLOOR  
SCALE: 1:100**

plot date: Thursday, 19 December 2024 2:47 PM file location: BIMcloud: FTA-SYD-BIM26 - BIMcloud Basic for Archicad 26/7068ND01 Northmead Public Sch

REV.	DESCRIPTION	DATE	INIT.
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03	95% SCHEMATIC DESIGN	10/12/2024	AK
02	80% SCHEMATIC DESIGN	26/11/2024	AK
01	SD-01 - 50% SCHEMATIC DESIGN	15/11/2024	AK

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**SCHEMATIC DESIGN**

---

**SCHOOL INFRASTRUCTURE**

---

**NSW**

---


**NORTHMEAD PUBLIC SCHOOL**

---

**MOXHAMS ROAD,**  
**NORTHMEAD, NSW**

---

<b>BUILDING T - GROUND FLOOR</b>		
<b>RCP</b>		
<p>Figured dimensions take precedence over scale dimensions. Contractors must verify all dimensions on site before commencing any work or making shop drawings.</p>		
<b>PROJECT NUMBER</b>	<b>DIRECTOR</b>	<b>CHECKED</b>
<b>7068ND01</b>	<b>JW</b>	<b>NK</b>
<b>RAWING NUMBER</b>		<b>REVISION</b>
<b>NPS-FTA-B00T-GF-DR-A-2201</b>		
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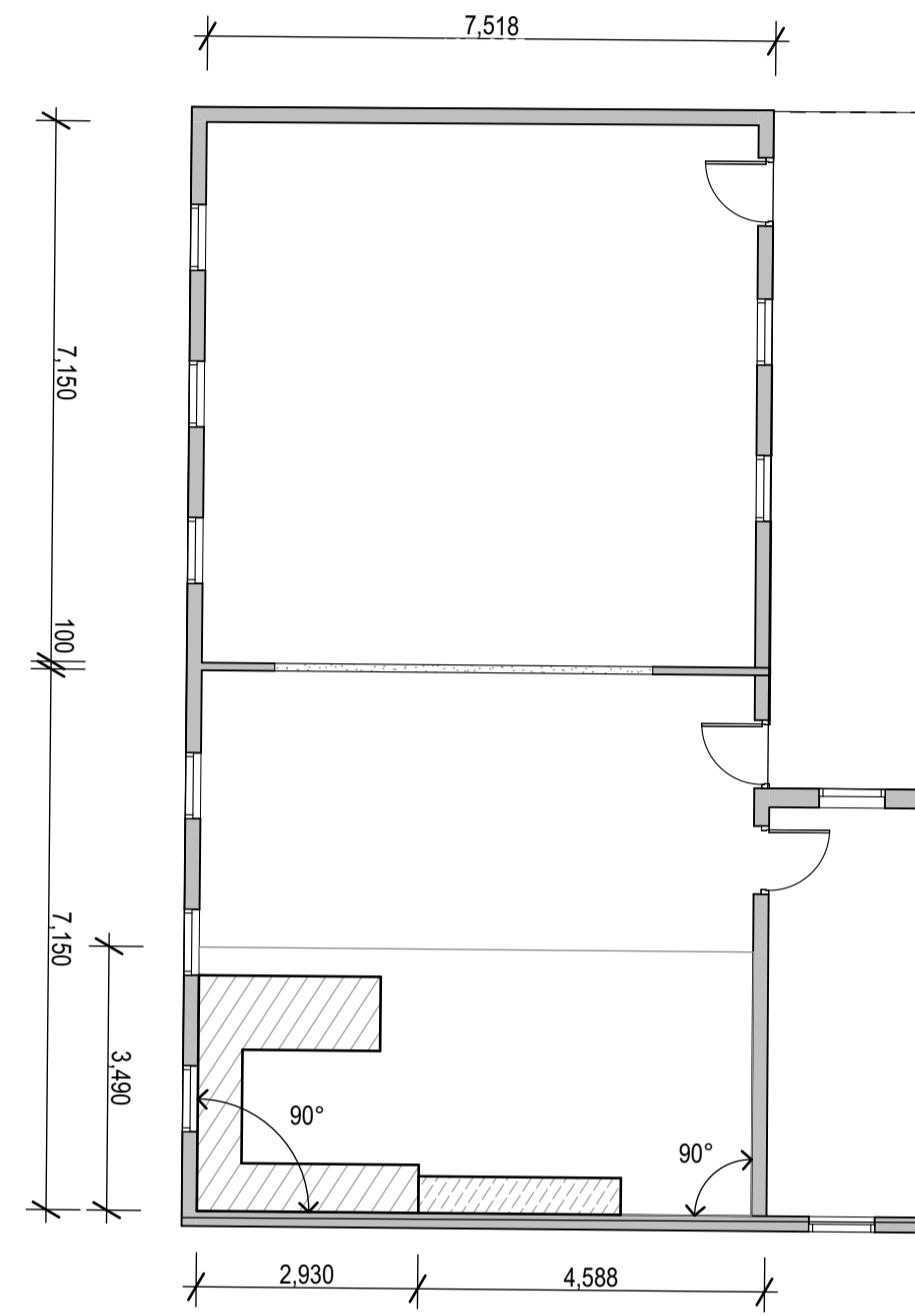

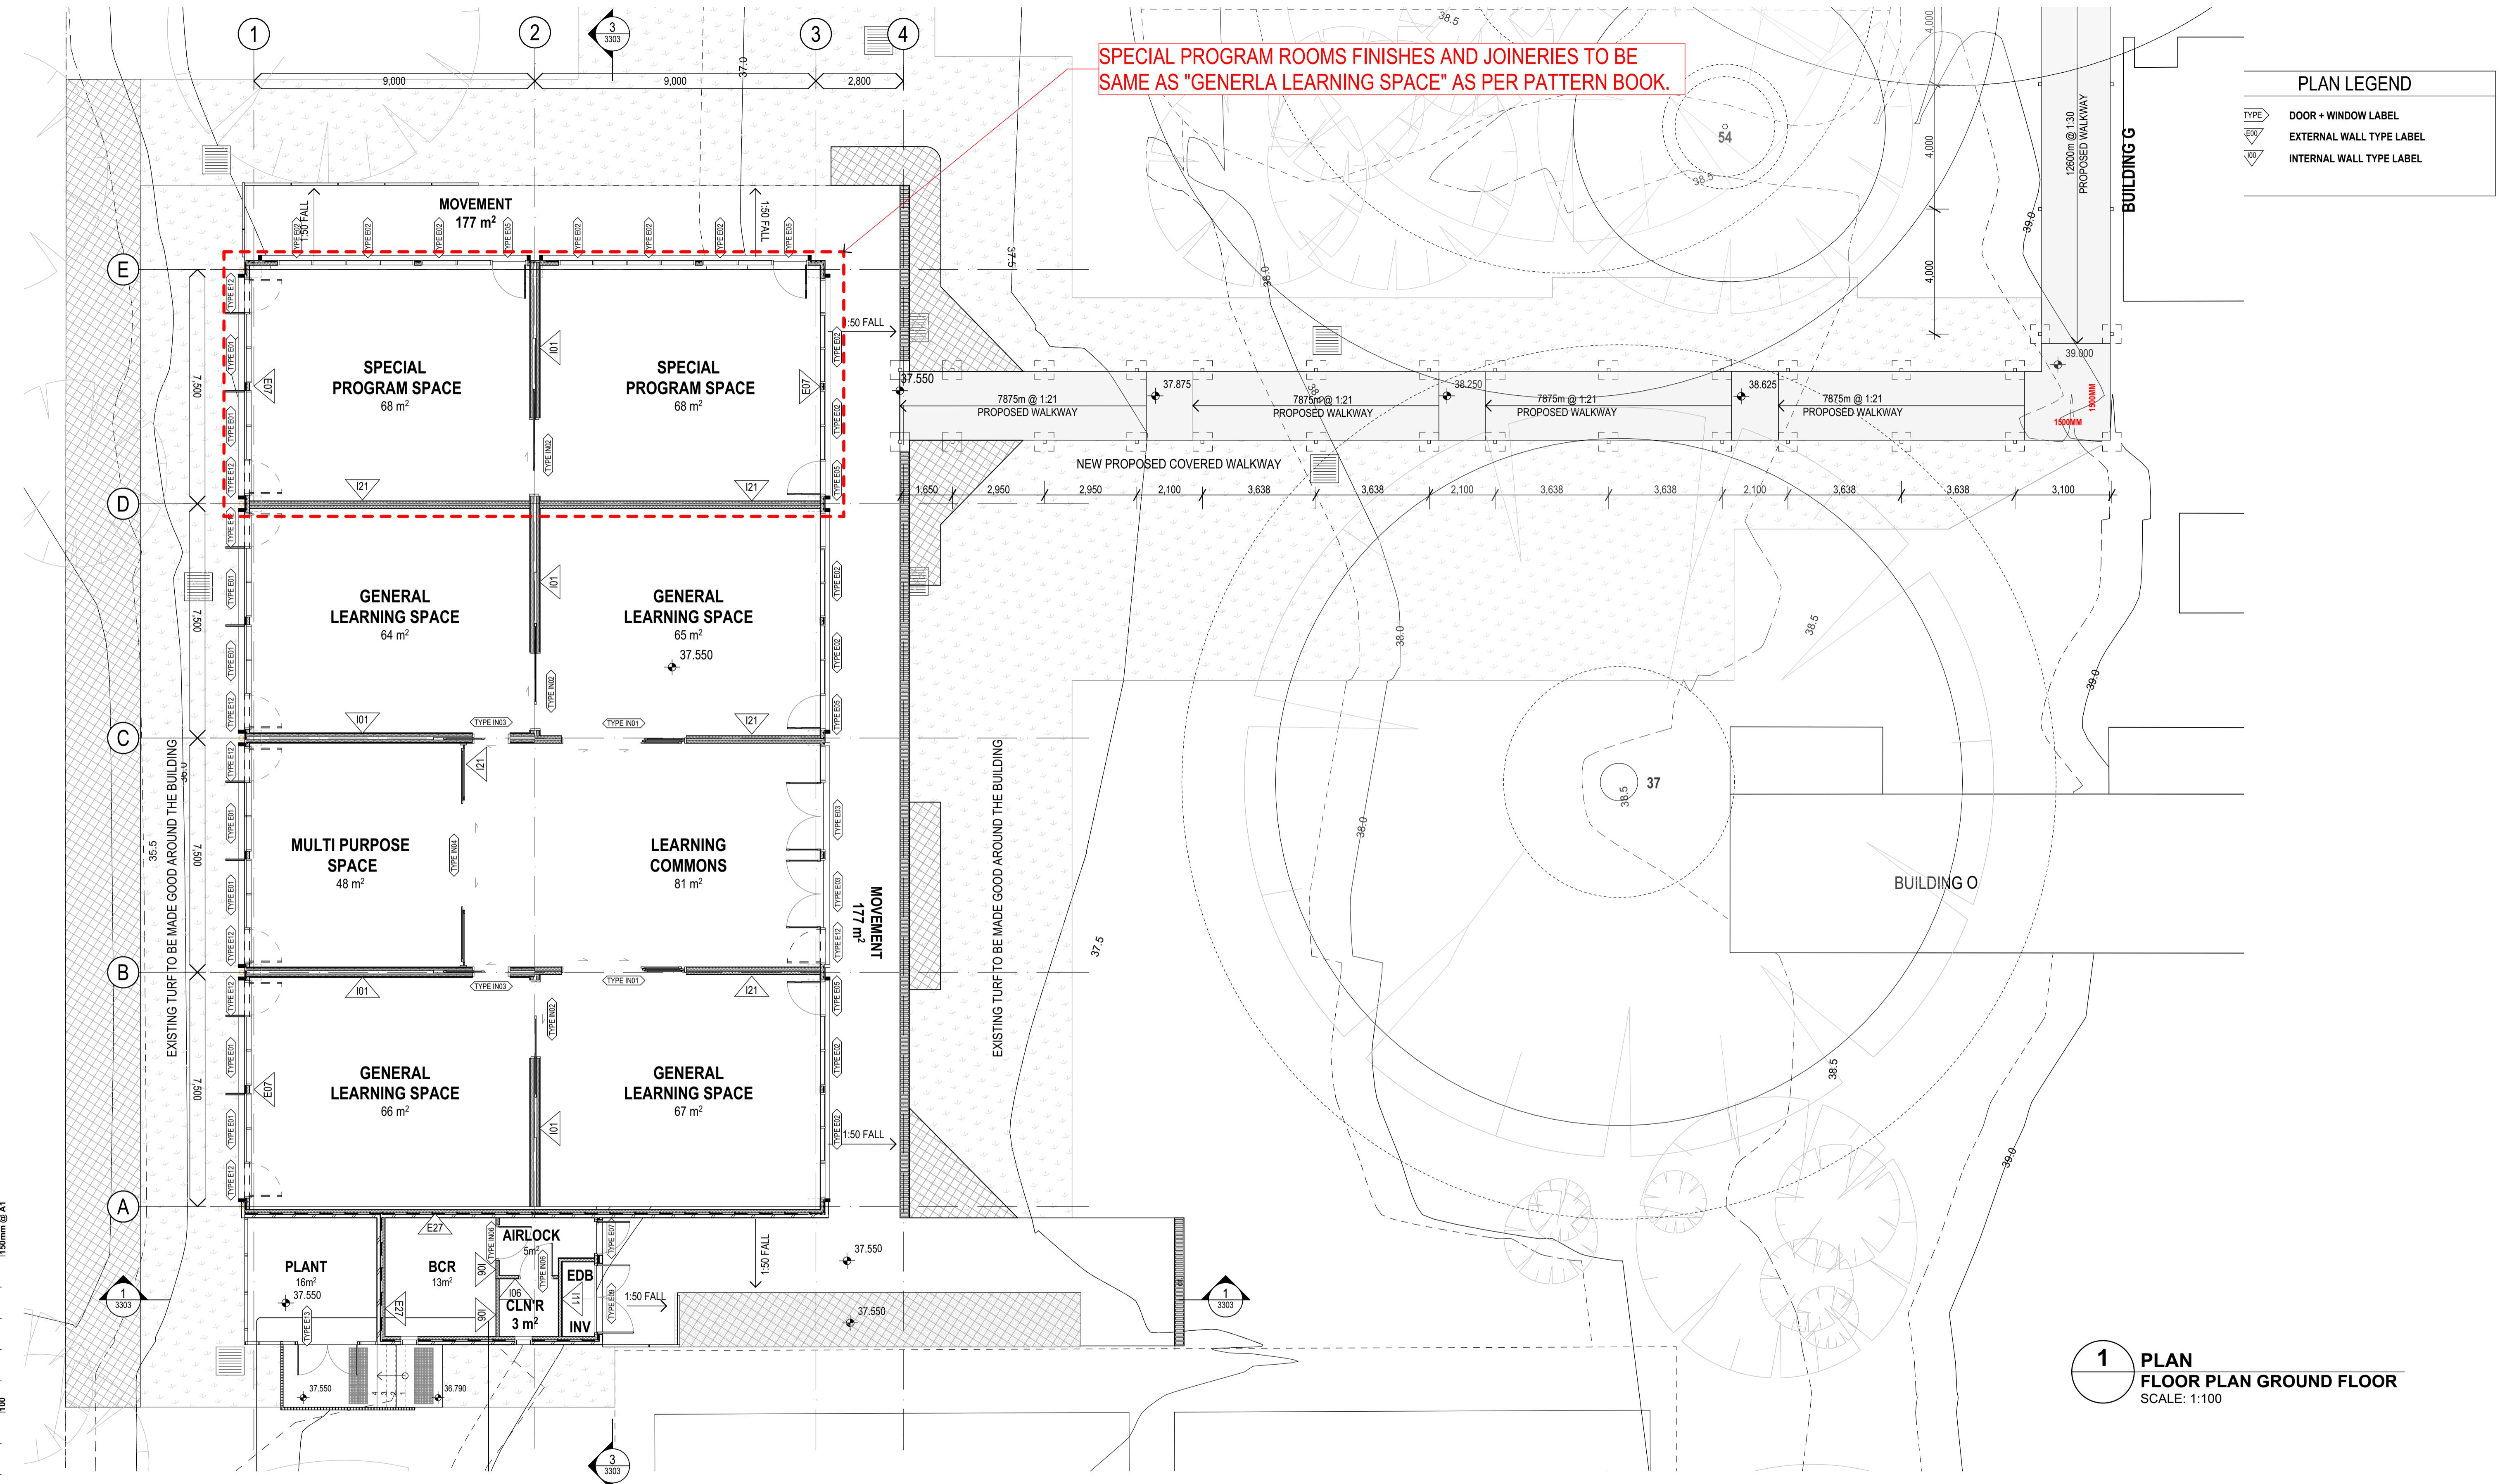
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P4	100% CONCEPT DESIGN	31/10/2024	NK
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P2	FOR INFORMATION	27/09/2024	AK
P1	FOR INFORMATION	20/09/2024	AK


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SCHOOL INFRASTRUCTURE  
NSW  
NORTHMEAD PUBLIC SCHOOL  
MOXHAMS ROAD,  
NORTHMEAD, NSW

**BUILDING T - GROUND FLOOR PLAN**  
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PROJECT NUMBER 7068ND01 DIRECTOR JW  
DRAWING NUMBER NPS-FTA-B00T-GF-DR-A-2101 REVISION 04  
CHECKED NK  
REVISED



**1 PLAN**  
**BUILDING R - EXISTING FLOOR PLAN**  
SCALE: 1:100

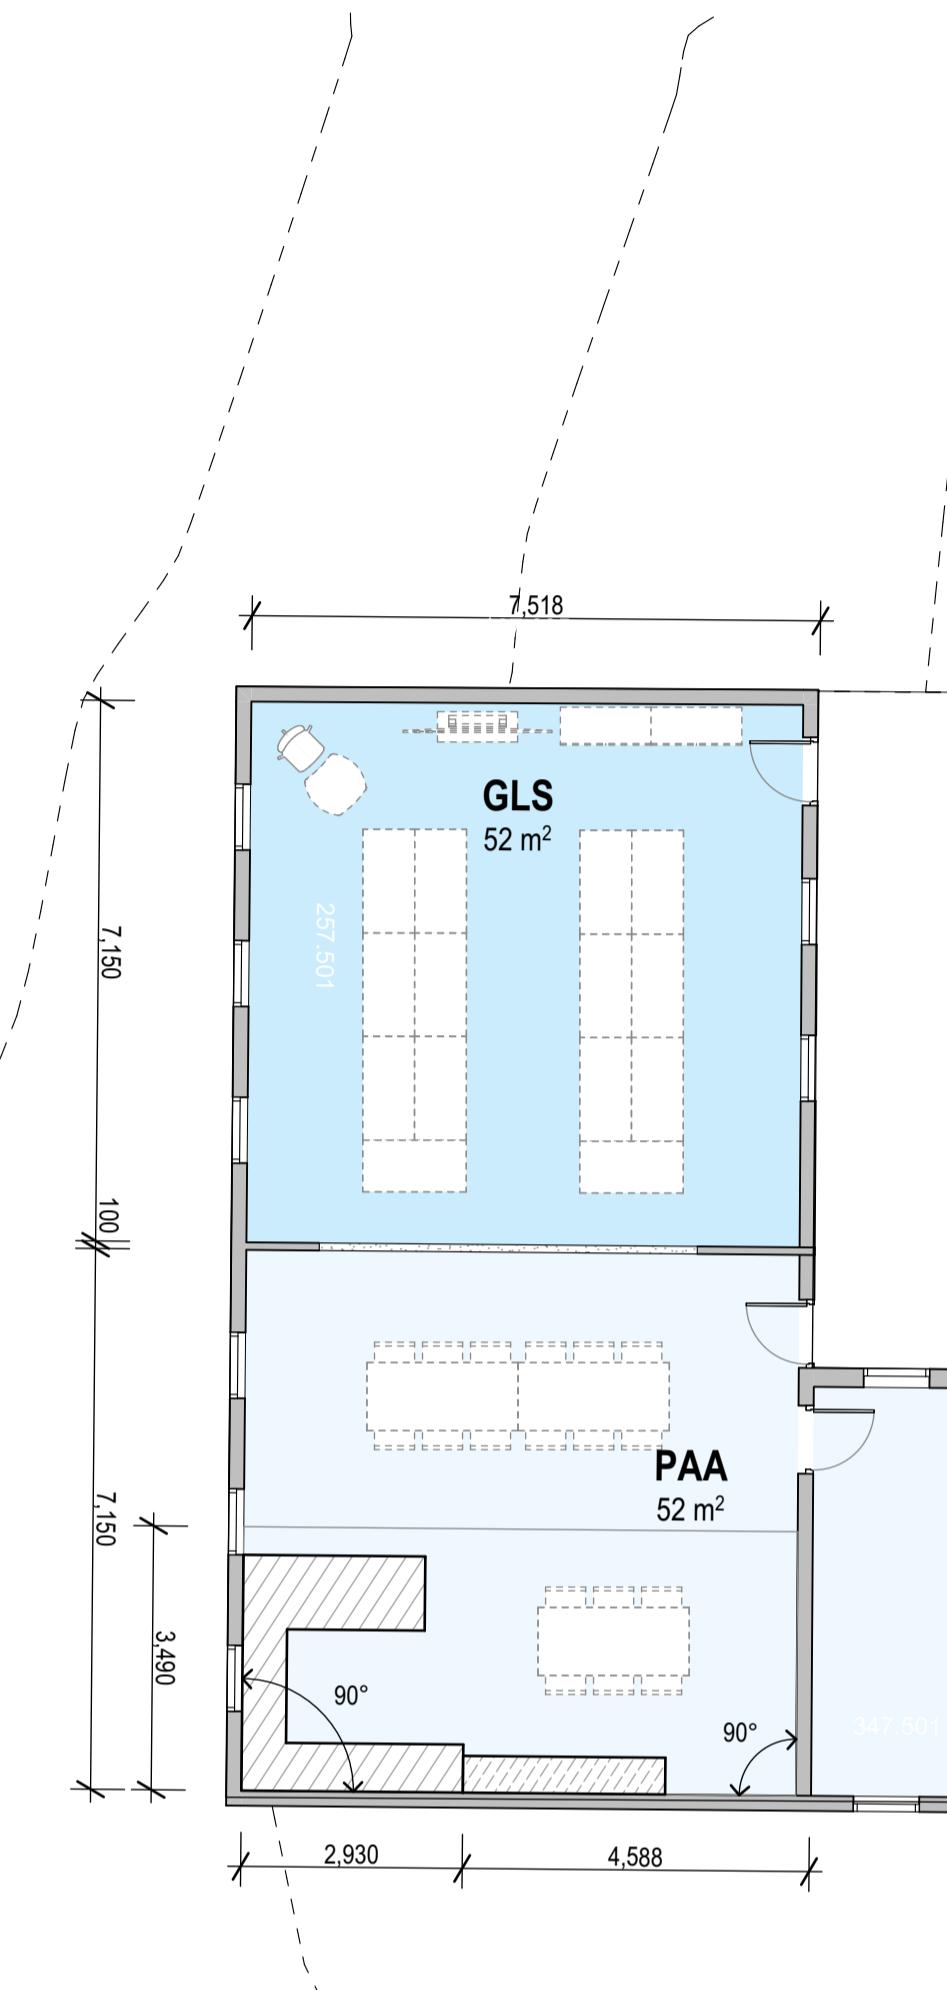

**2 PLAN**  
**BUILDING R - PROPOSED FLOOR PLAN**  
SCALE: 1:100

150mm @ A1

100

50

REV.	DESCRIPTION	DATE	INIT.
04	100% SCHEMATIC DESIGN	19/12/2024	NK
03	95% SCHEMATIC DESIGN	19/12/2024	AK
02		26/11/2024	
01	SD-01 - 50% SCHEMATIC DESIGN	19/11/2024	AK

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John Ward (Chair)

Karen Dimopoulos (Chair)  
Paul Seneviratne (Chair)

Ryan Lovelady (Chair)

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VIC 18804 QLD 5313

NSW 8371 QLD 3847

NSW 7434 QLD 4529

NSW 7780 QLD 42168

NSW 7780 QLD 4500

PROJECT NUMBER: **7068ND01** DIRECTOR: **JW**  
DRAWING NUMBER: **NPS-FTA-B00R-GF-DR-A-2101** CHECKED: **04**  
REVISION: **04**

**SCHEMATIC DESIGN**  
SCHOOL INFRASTRUCTURE  
NSW

ADDRESS: **NORTHMEAD PUBLIC SCHOOL**  
MOXHAMS ROAD,  
NORTHMEAD, NSW


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Figured dimensions take precedence over scale dimensions. Contractors must verify all dimensions on site before commencing any work or making shop drawings.

PROJECT NUMBER: **7068ND01** DIRECTOR: **JW**

DRAWING NUMBER: **NPS-FTA-B00R-GF-DR-A-2101** CHECKED: **04**

REVISION: **04**


REFER TO "INTERIOR CONCEPT PRESENTATION" FILE FOR THE PROPOSED APPLICATION OF THE FINISHES AND FIXTURES

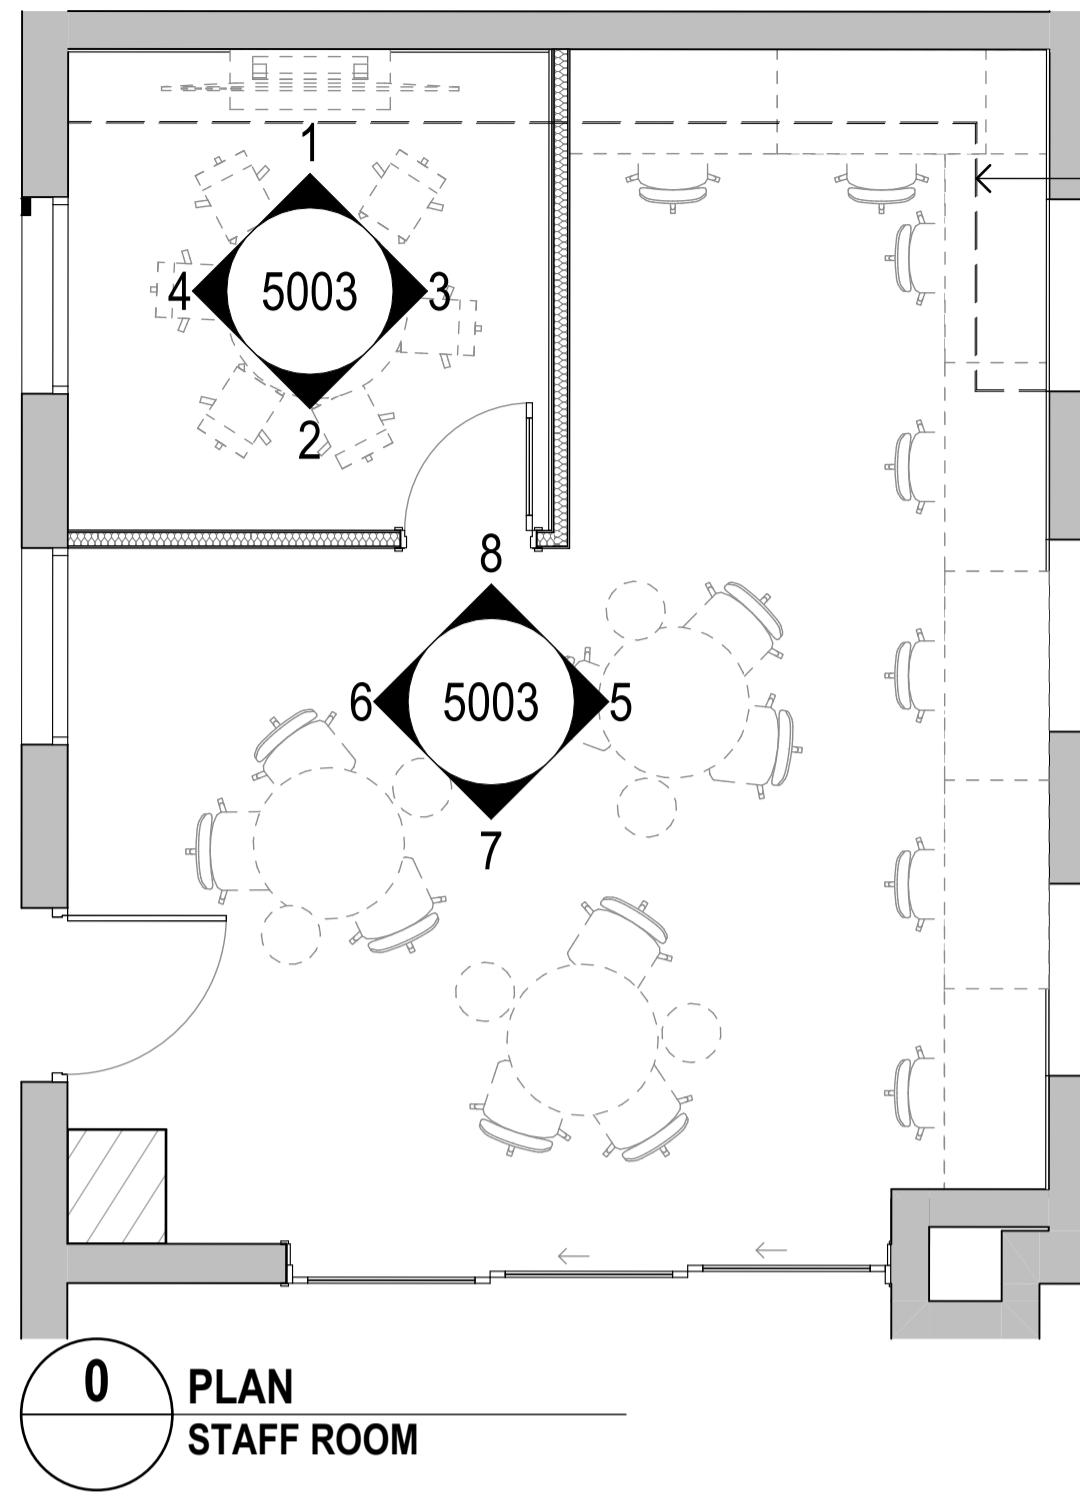


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0 PLAN STAFF ROOM


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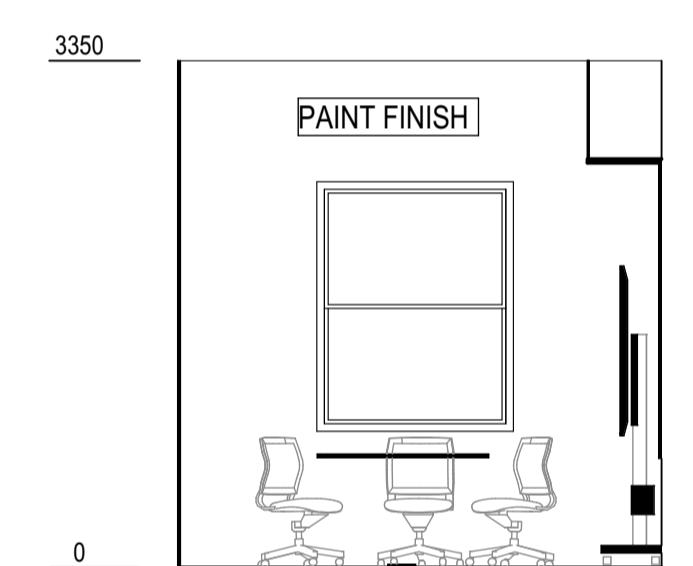
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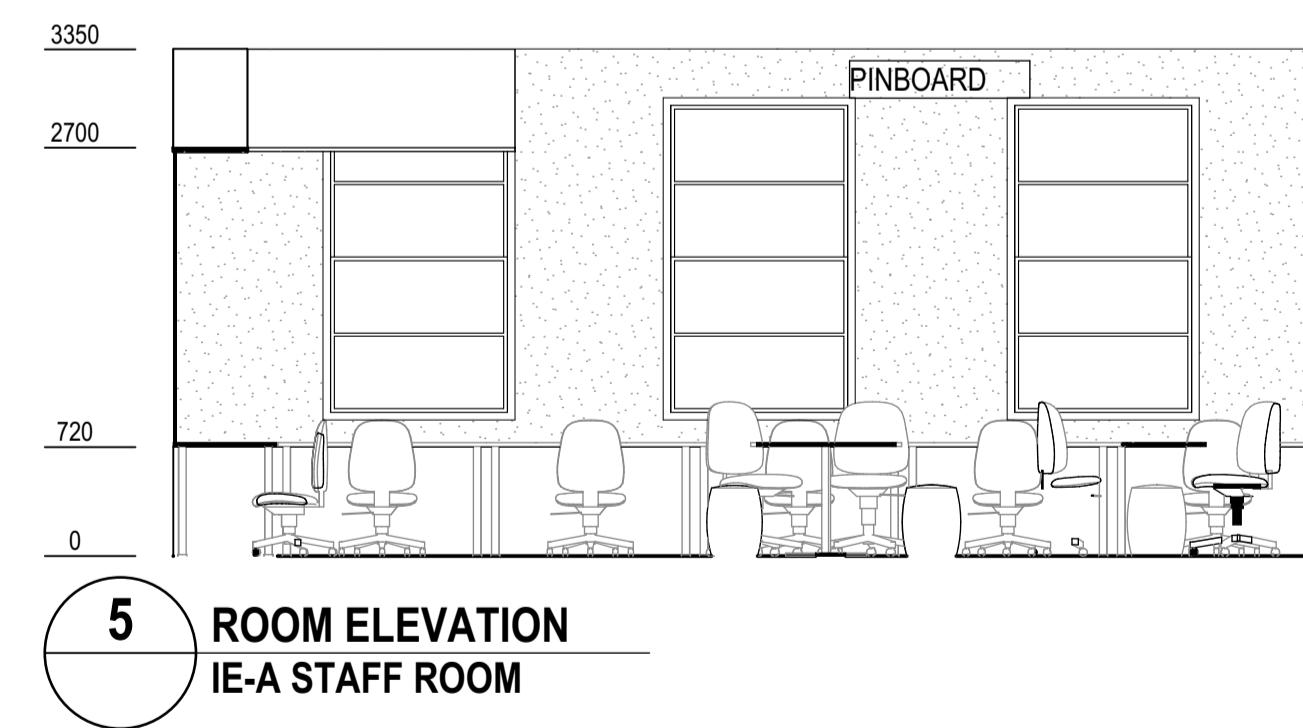
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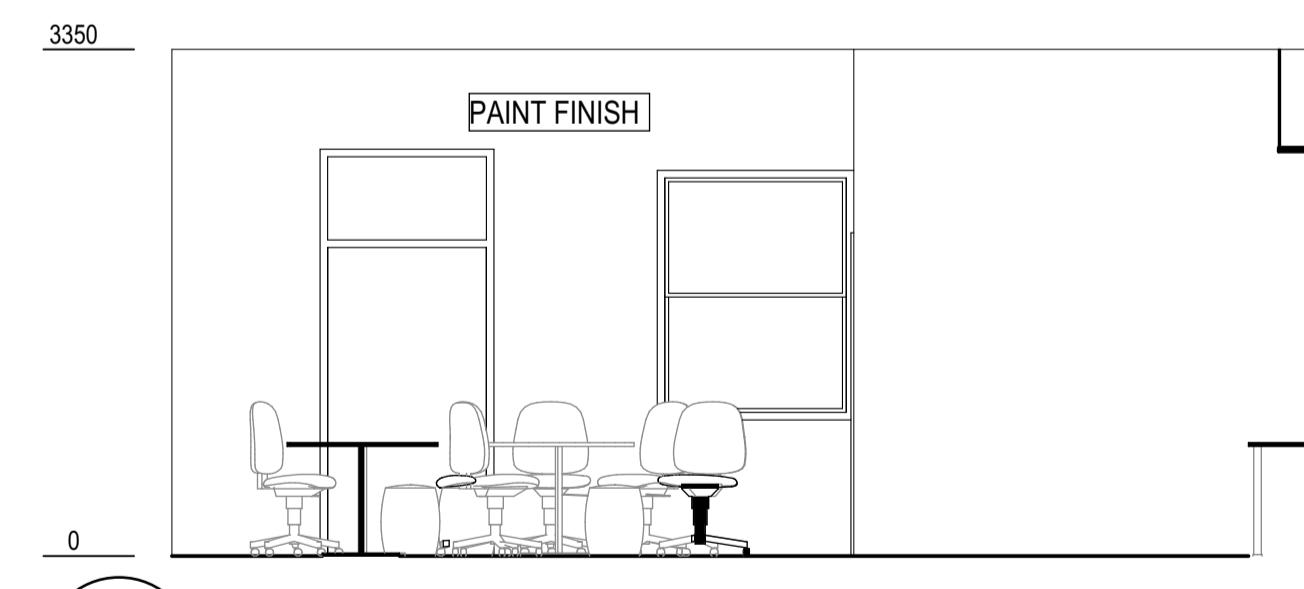
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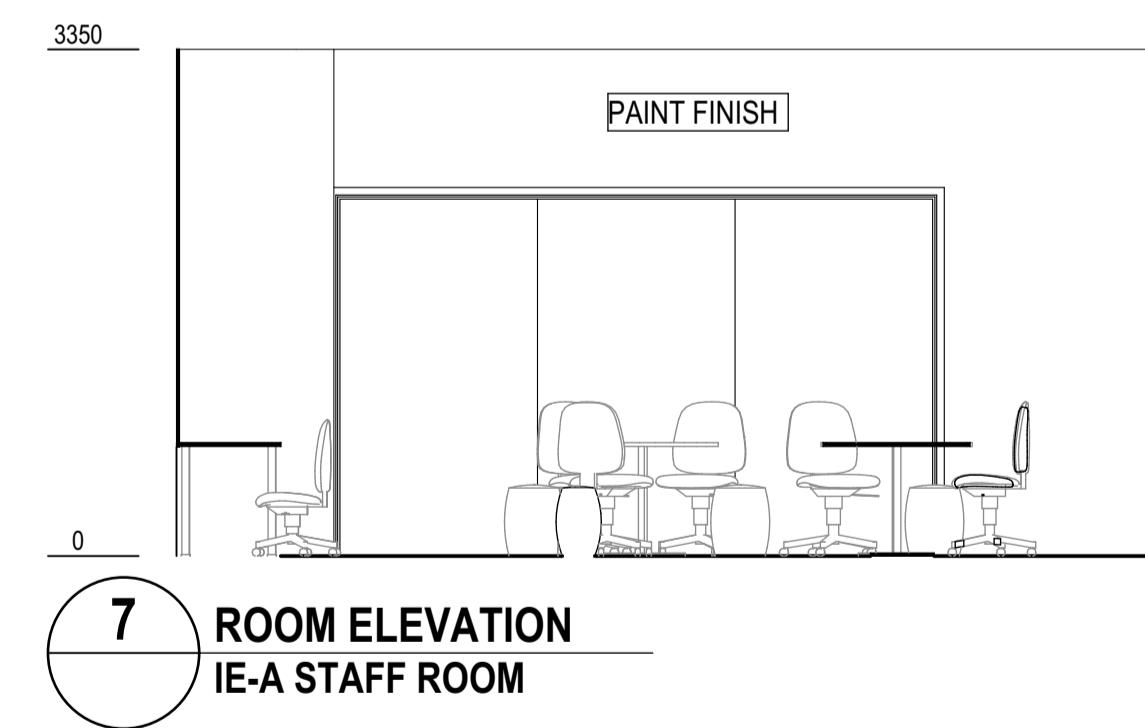
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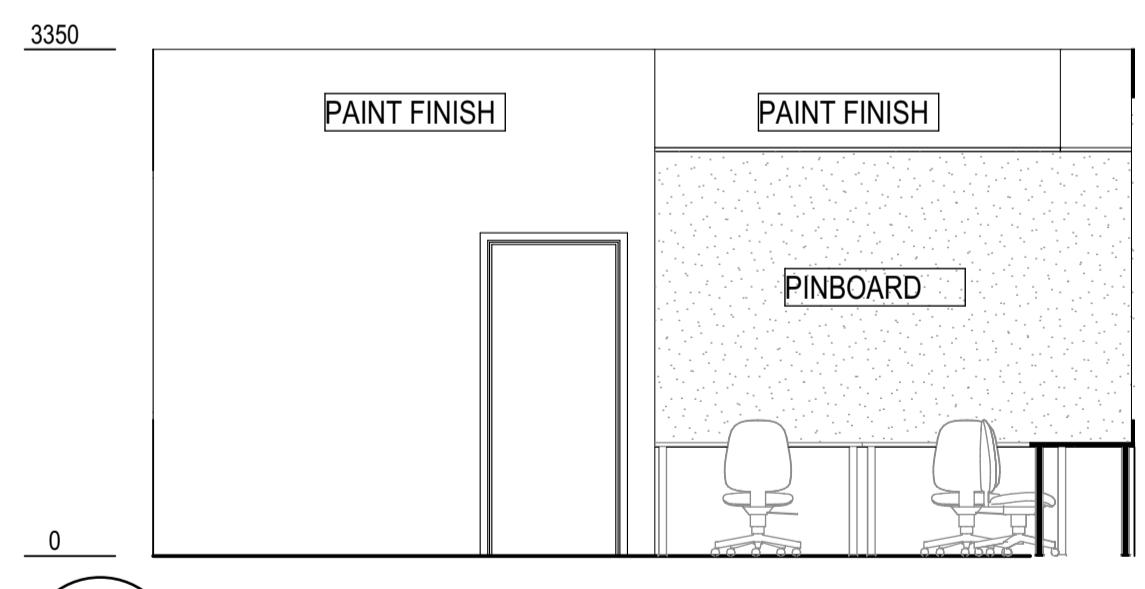
5 ROOM ELEVATION IE-A STAFF ROOM

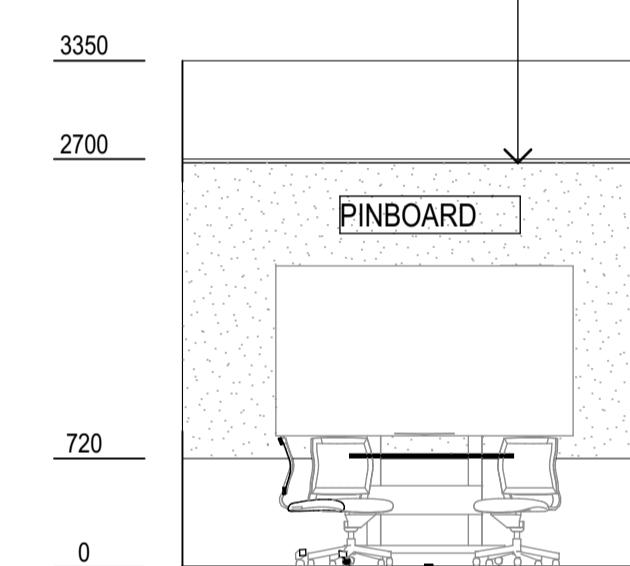

6 ROOM ELEVATION IE-A STAFF ROOM

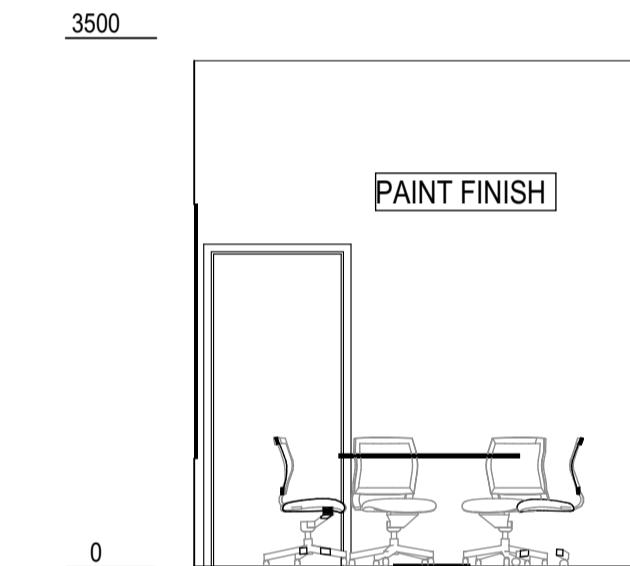

7 ROOM ELEVATION IE-A STAFF ROOM

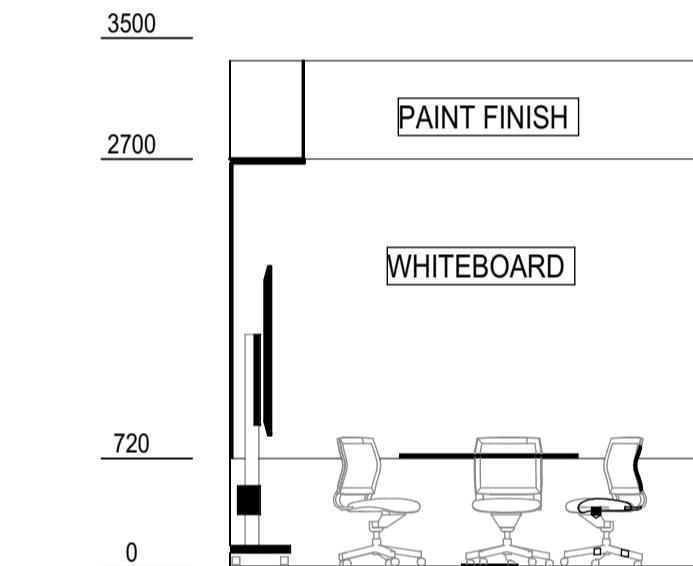

8 ROOM ELEVATION IE-A STAFF ROOM

REV.	DESCRIPTION	DATE	INIT.
02	100% SCHEMATIC DESIGN	19/12/2024	NK
01	95% SCHEMATIC DESIGN	10/12/2024	AK

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Karen Dimopoulos ria

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NSW 6855 QLD 2950

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NSW 7434 QLD 3847

NSW 7780 QLD 4259

NSW 7788 QLD 4508


VIC 18804 QLD 4500

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DRAWING NUMBER: NPS-FTA-B00A-ZZ-DR-A-5003  
PHASE: SCHEMATIC DESIGN  
CLIENT: NORTHMEAD PUBLIC SCHOOL  
ADDRESS: MOXHAMS ROAD, NORTHMEAD, NSW













PROJECT NUMBER: NPS-FTA-B00A-ZZ-DR-A-5003  
DRAWING NUMBER: NPS-FTA-B00A-ZZ-DR-A-5003  
PHASE: SCHEMATIC DESIGN  
CLIENT: NORTHMEAD PUBLIC SCHOOL  
ADDRESS: MOXHAMS ROAD, NORTHMEAD, NSW

BUILDING A - STAFF ROOM  
Figured dimensions take precedence over scale dimensions. Contractors must verify all dimensions on site before commencing any work or making shop drawings.  
PROJECT NUMBER: 7068ND01 DIRECTOR: JW  
DRAWING NUMBER: NPS-FTA-B00A-ZZ-DR-A-5003 REVISION: 02  
CHECKED: NK

REFER TO "INTERIOR CONCEPT PRESENTATION" FILE FOR THE PROPOSED APPLICATION OF THE FINISHES AND FIXTURES

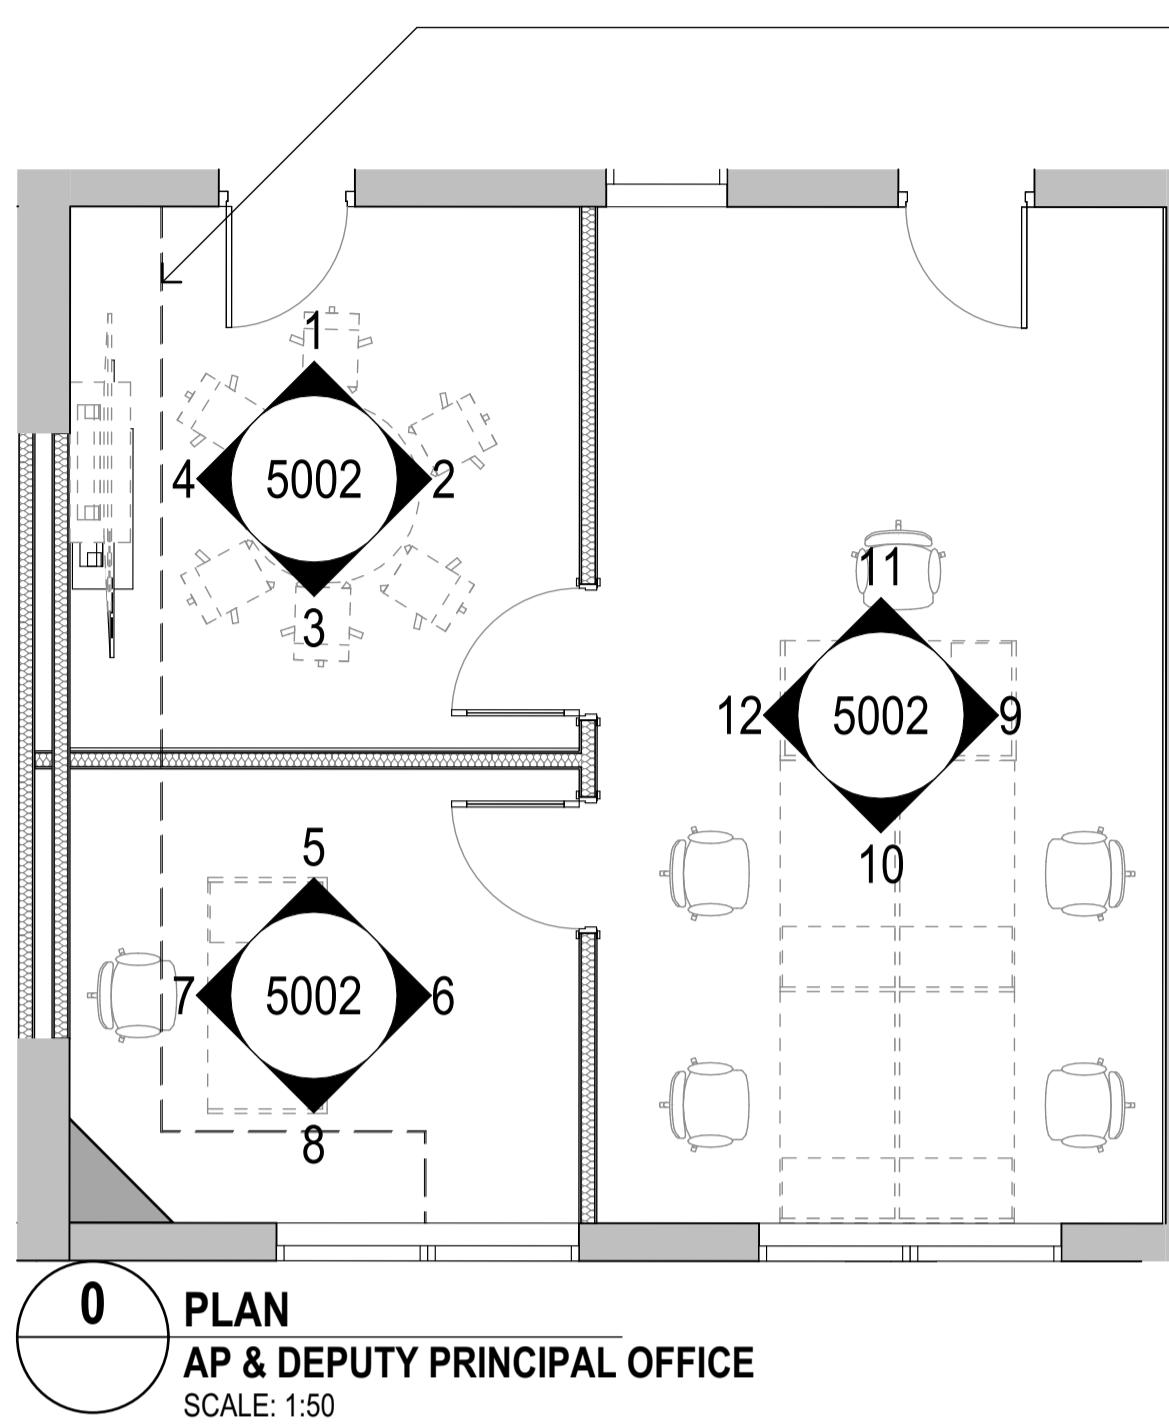

LINE SHOWING BULKHEAD OVER SITTING ON 2700MM HIGH INCORPORATING MECHANICAL DUCTS RUN.

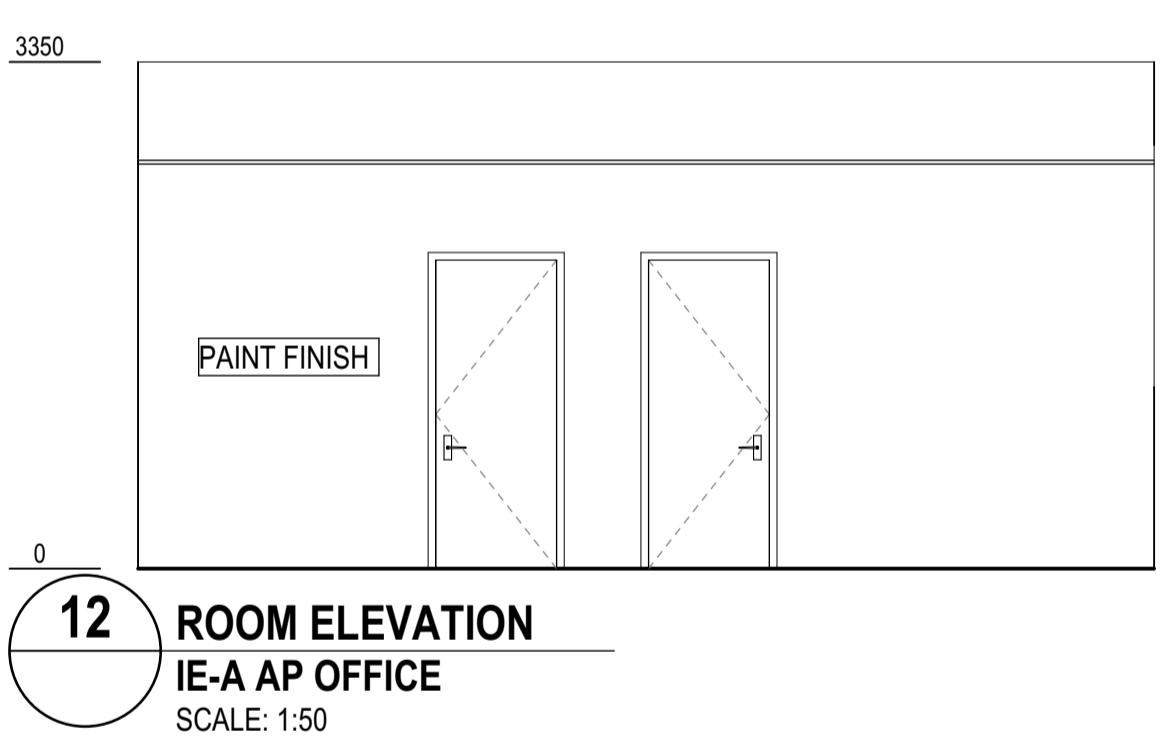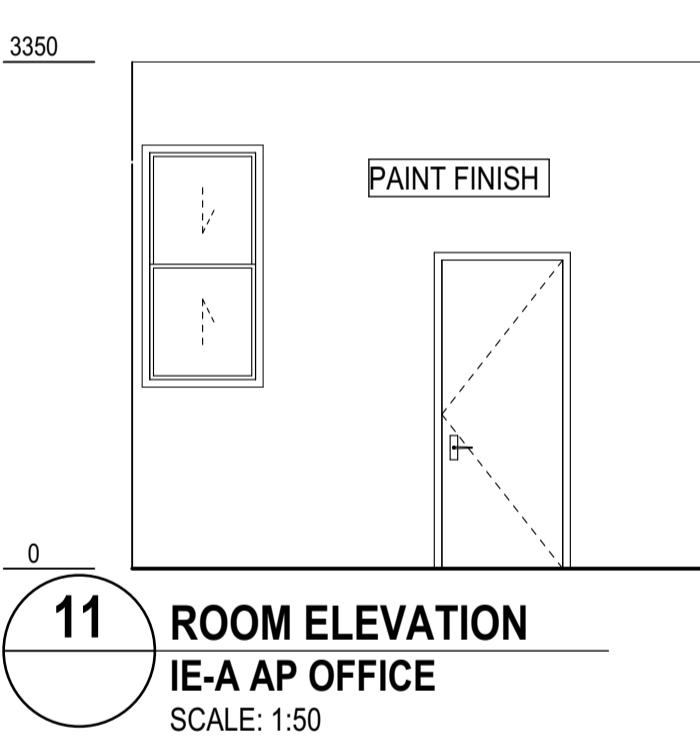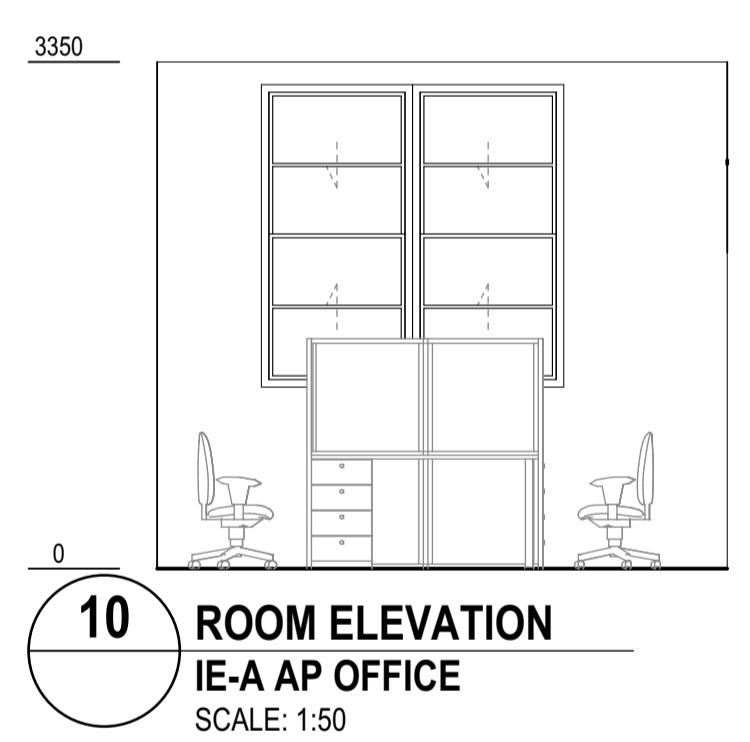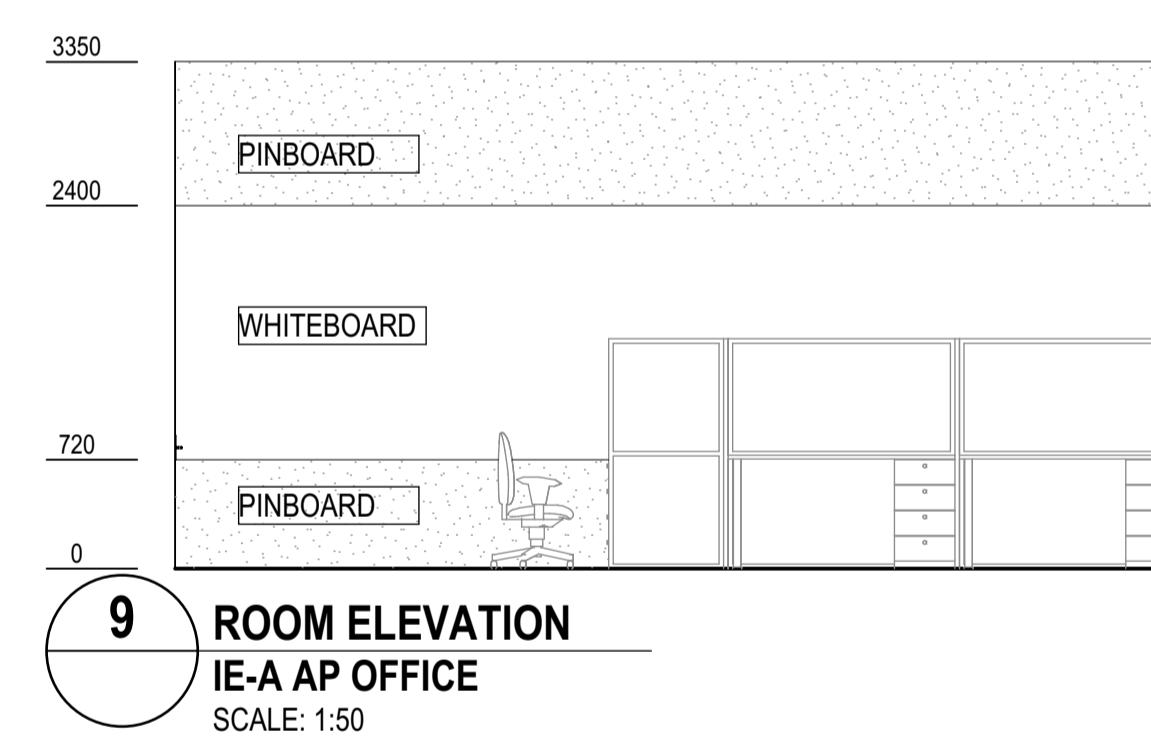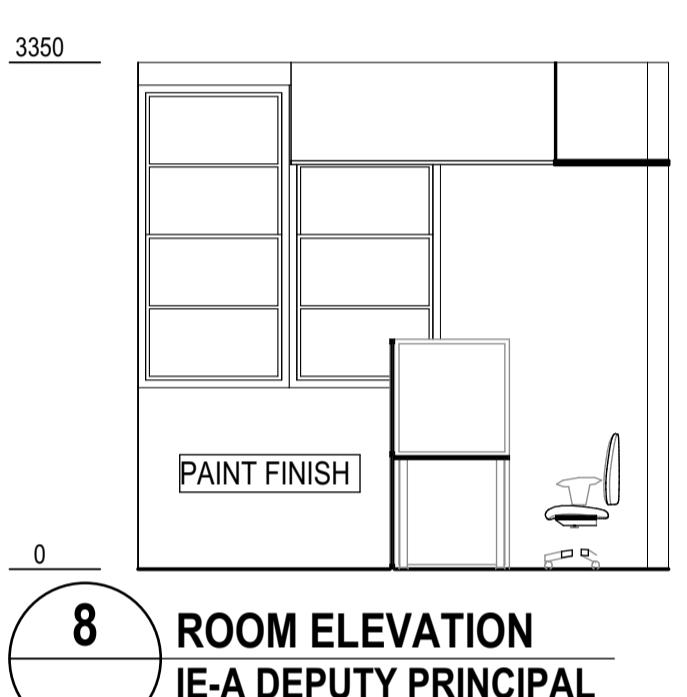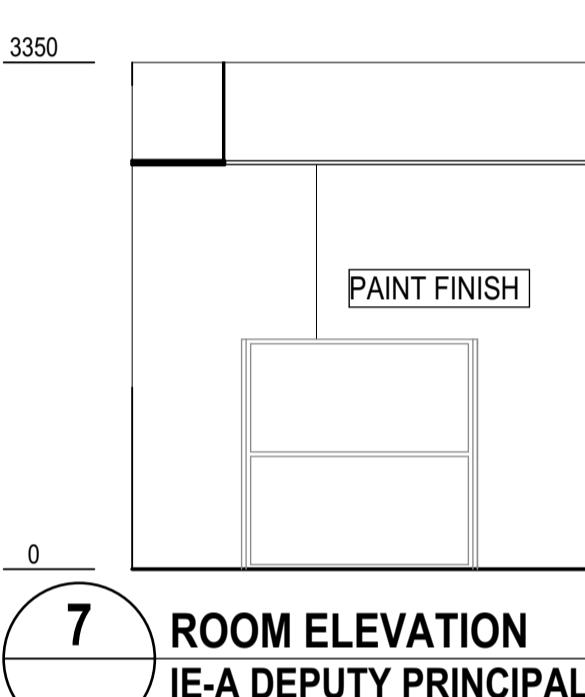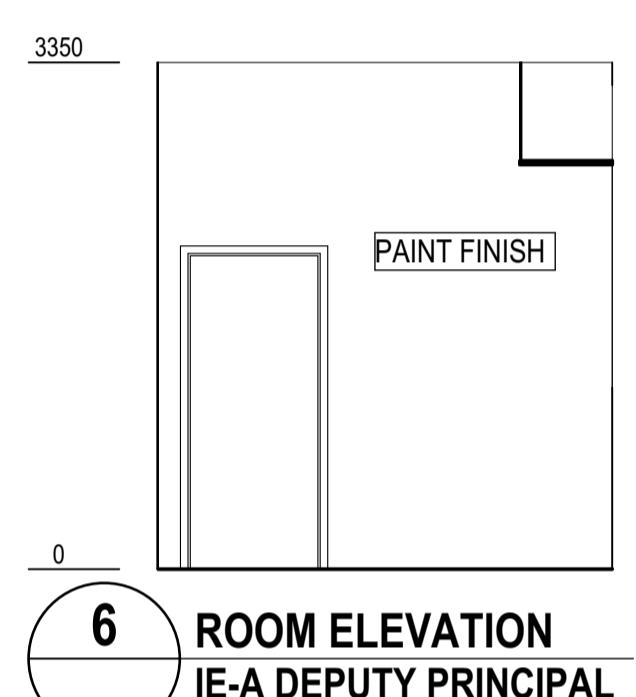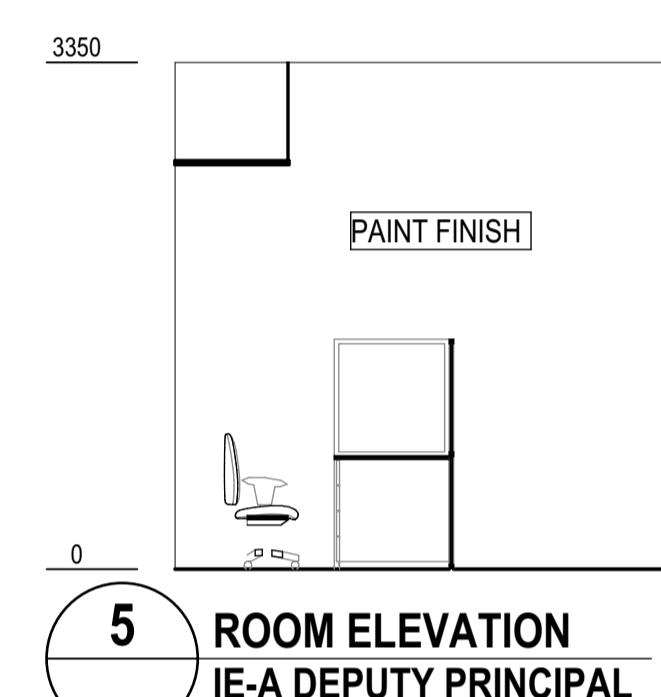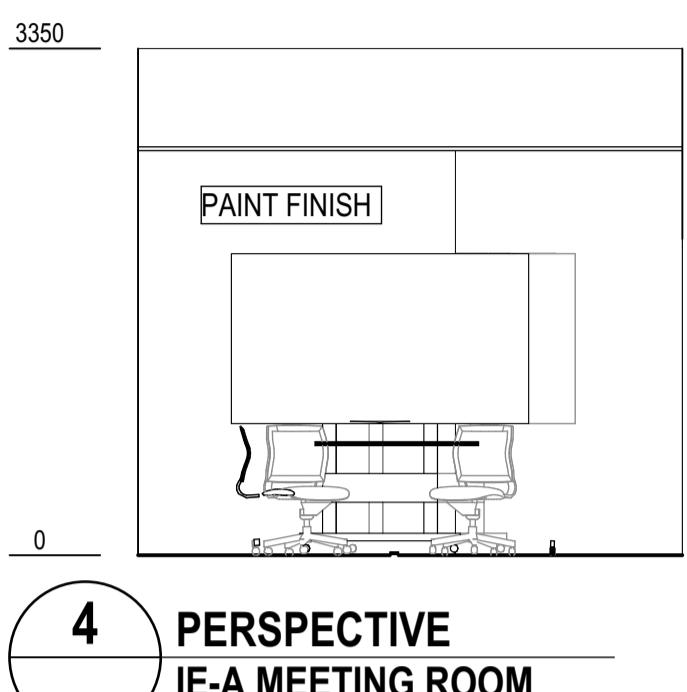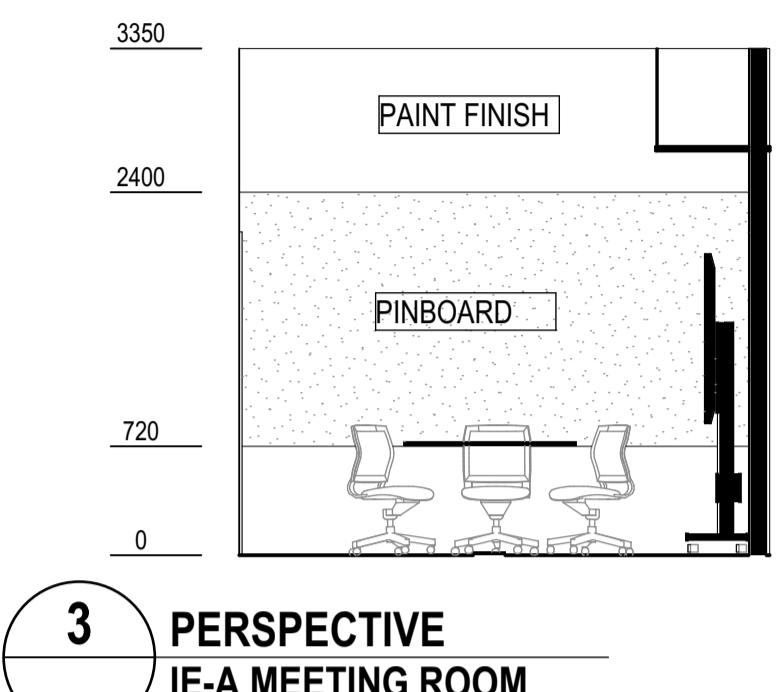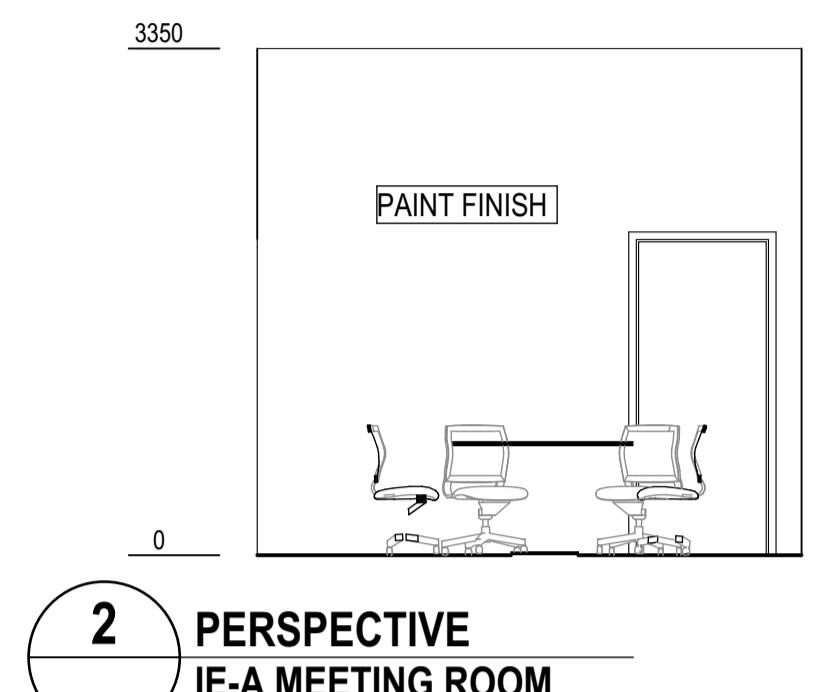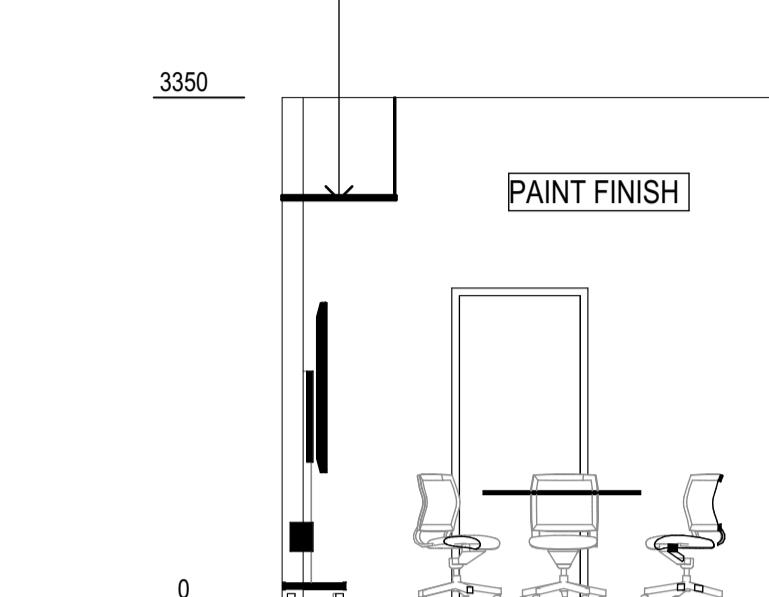

150mm @ A1

100

50

150mm @ A1  
50 100  
date: Thursday, 19 December 2024 2:47 PM file location: BIMcloud: FTA-SYD-BIM26 - BIMcloud Basic for Archicad 26/7068ND01 Northmead Public School

REV.	DESCRIPTION	DATE	INIT.
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01	95% SCHEMATIC DESIGN	10/12/2024	AK











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Kieren D'Amato Frais  
Paul Searle Frais  
Ryan Lovelady Frais

NSW 6855 QLD 2950  
VIC 18804 NSW 8371 QLD 3847  
NSW 7434 QLD 4529  
NSW 7780 QLD 4518  
Ryan Lovelady Frais QLD 4500

PROJECT NUMBER: **7068ND01** DIRECTOR: **JW** CHECKED: **NK**  
DRAWING NUMBER: **NPS-FTA-B00A-ZZ-DR-A-5002** REVISION: **02**  
PHASE: **SCHEMATIC DESIGN**  
CLIENT: **SCHOOL INFRASTRUCTURE NSW**  
ADDRESS: **NORTHMEAD PUBLIC SCHOOL**  
**MOXHAMS ROAD,**  
**NORTHMEAD, NSW**

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John Ward (Chair)  
Kieren Diment (Chair)  
Paul Sutcliffe (Chair)  
Ryan Lovelady (Chair)

NSW 6855 QLD 2950  
NSW 8371 QLD 3847  
NSW 7434 QLD 4529  
NSW 7780 QLD 4508  
VIC 18804 QLD 5313

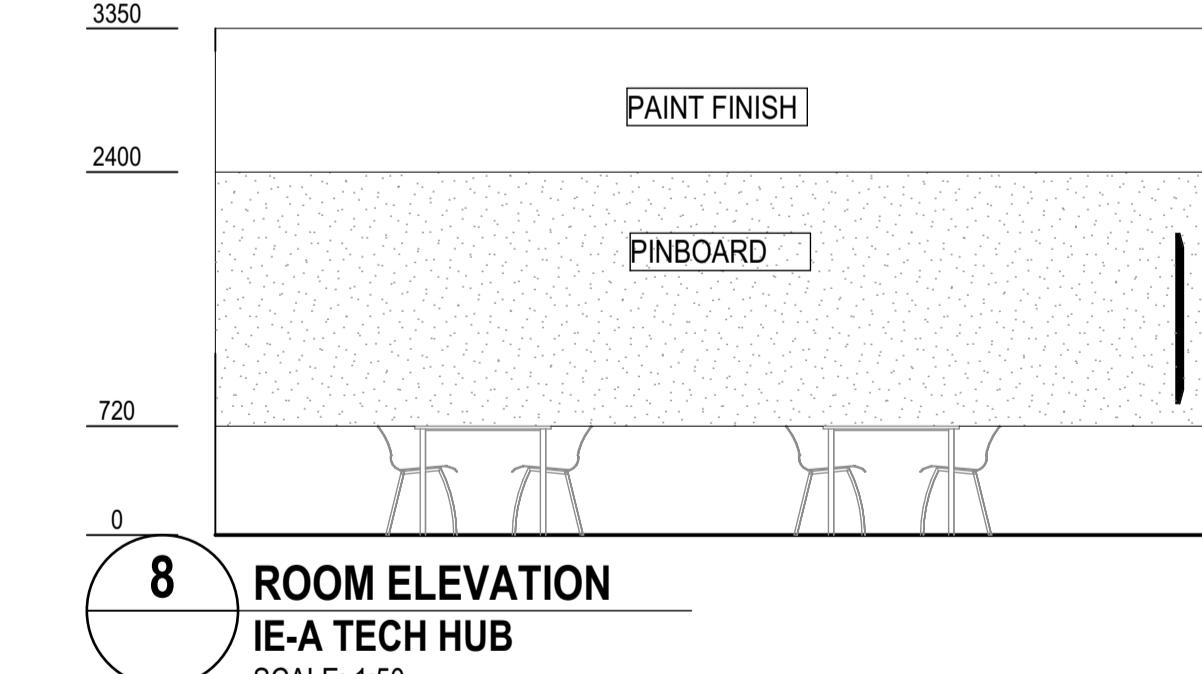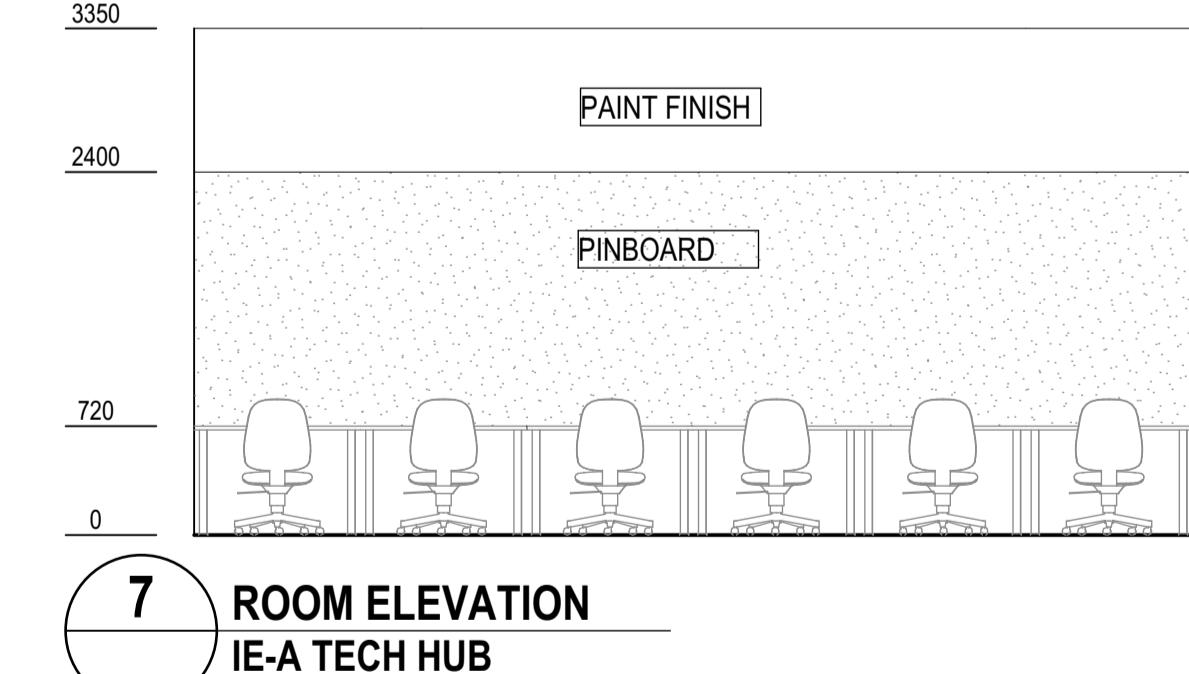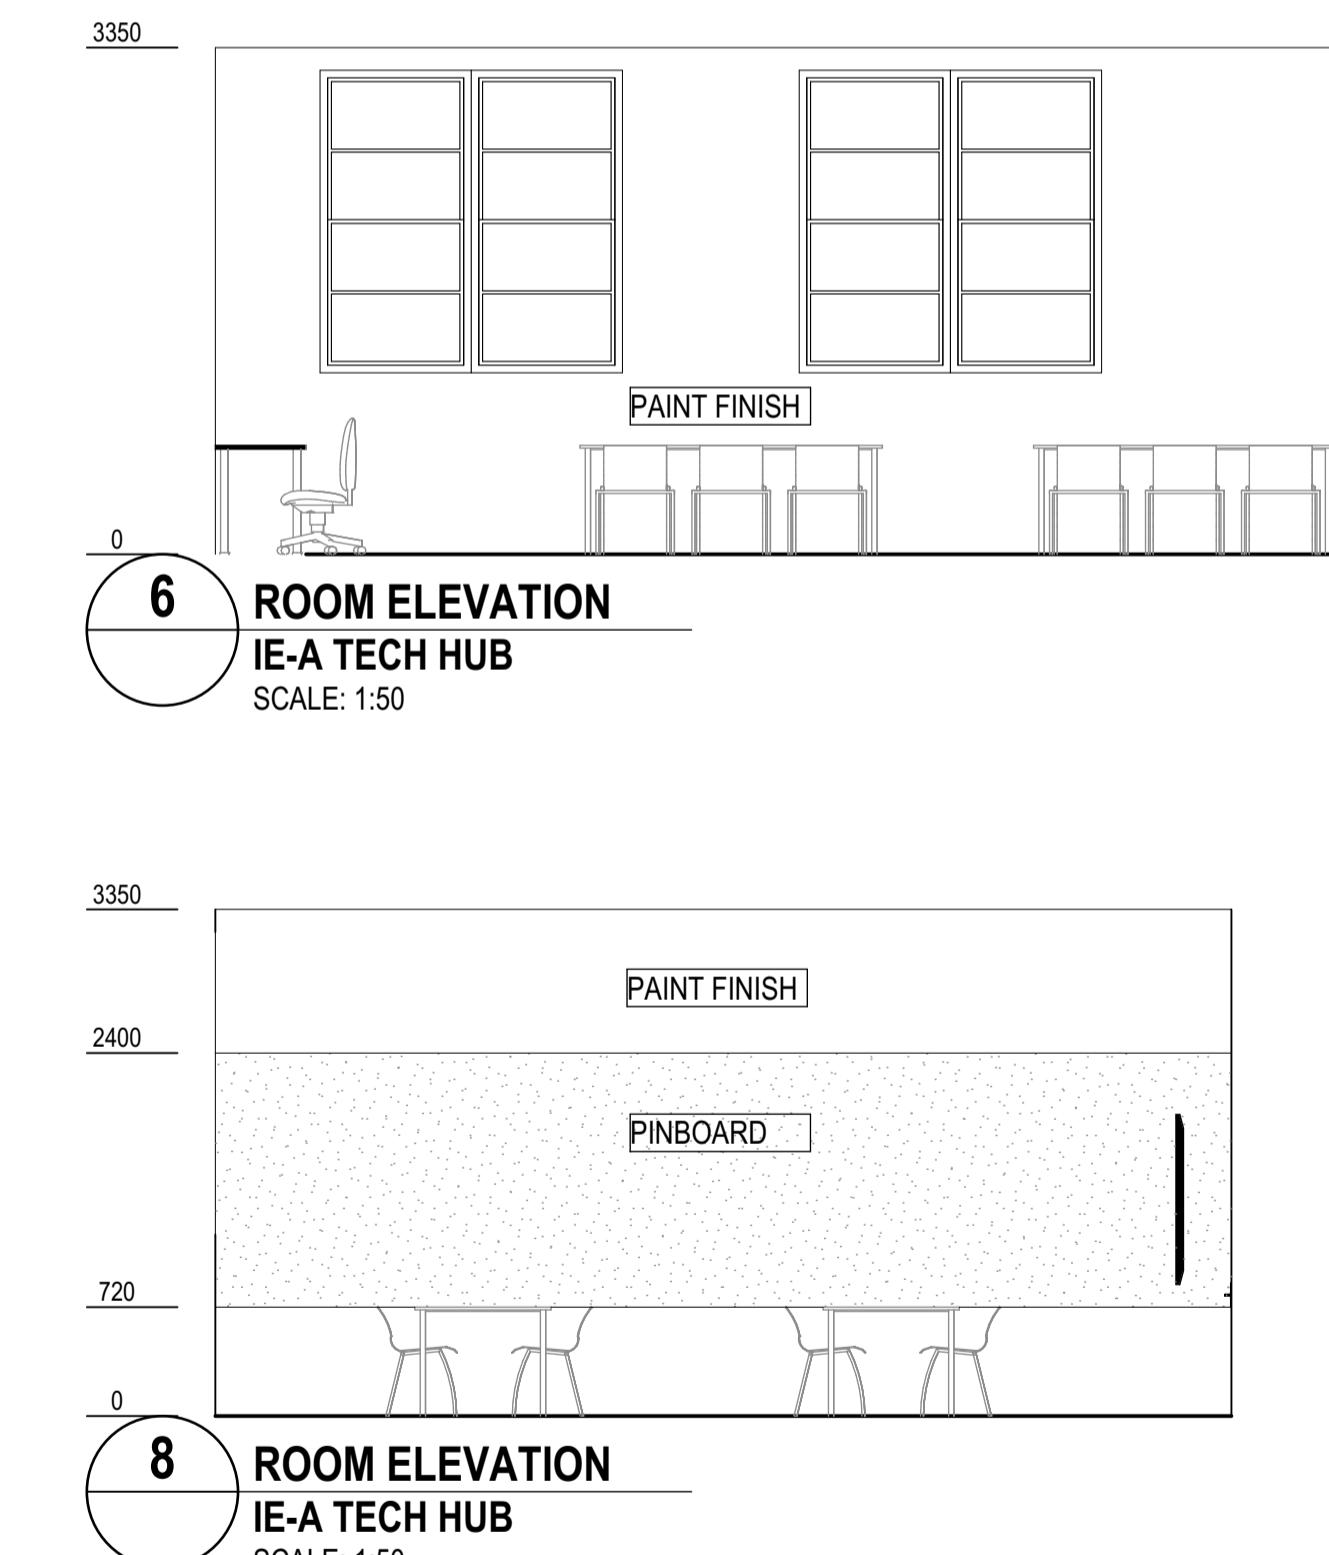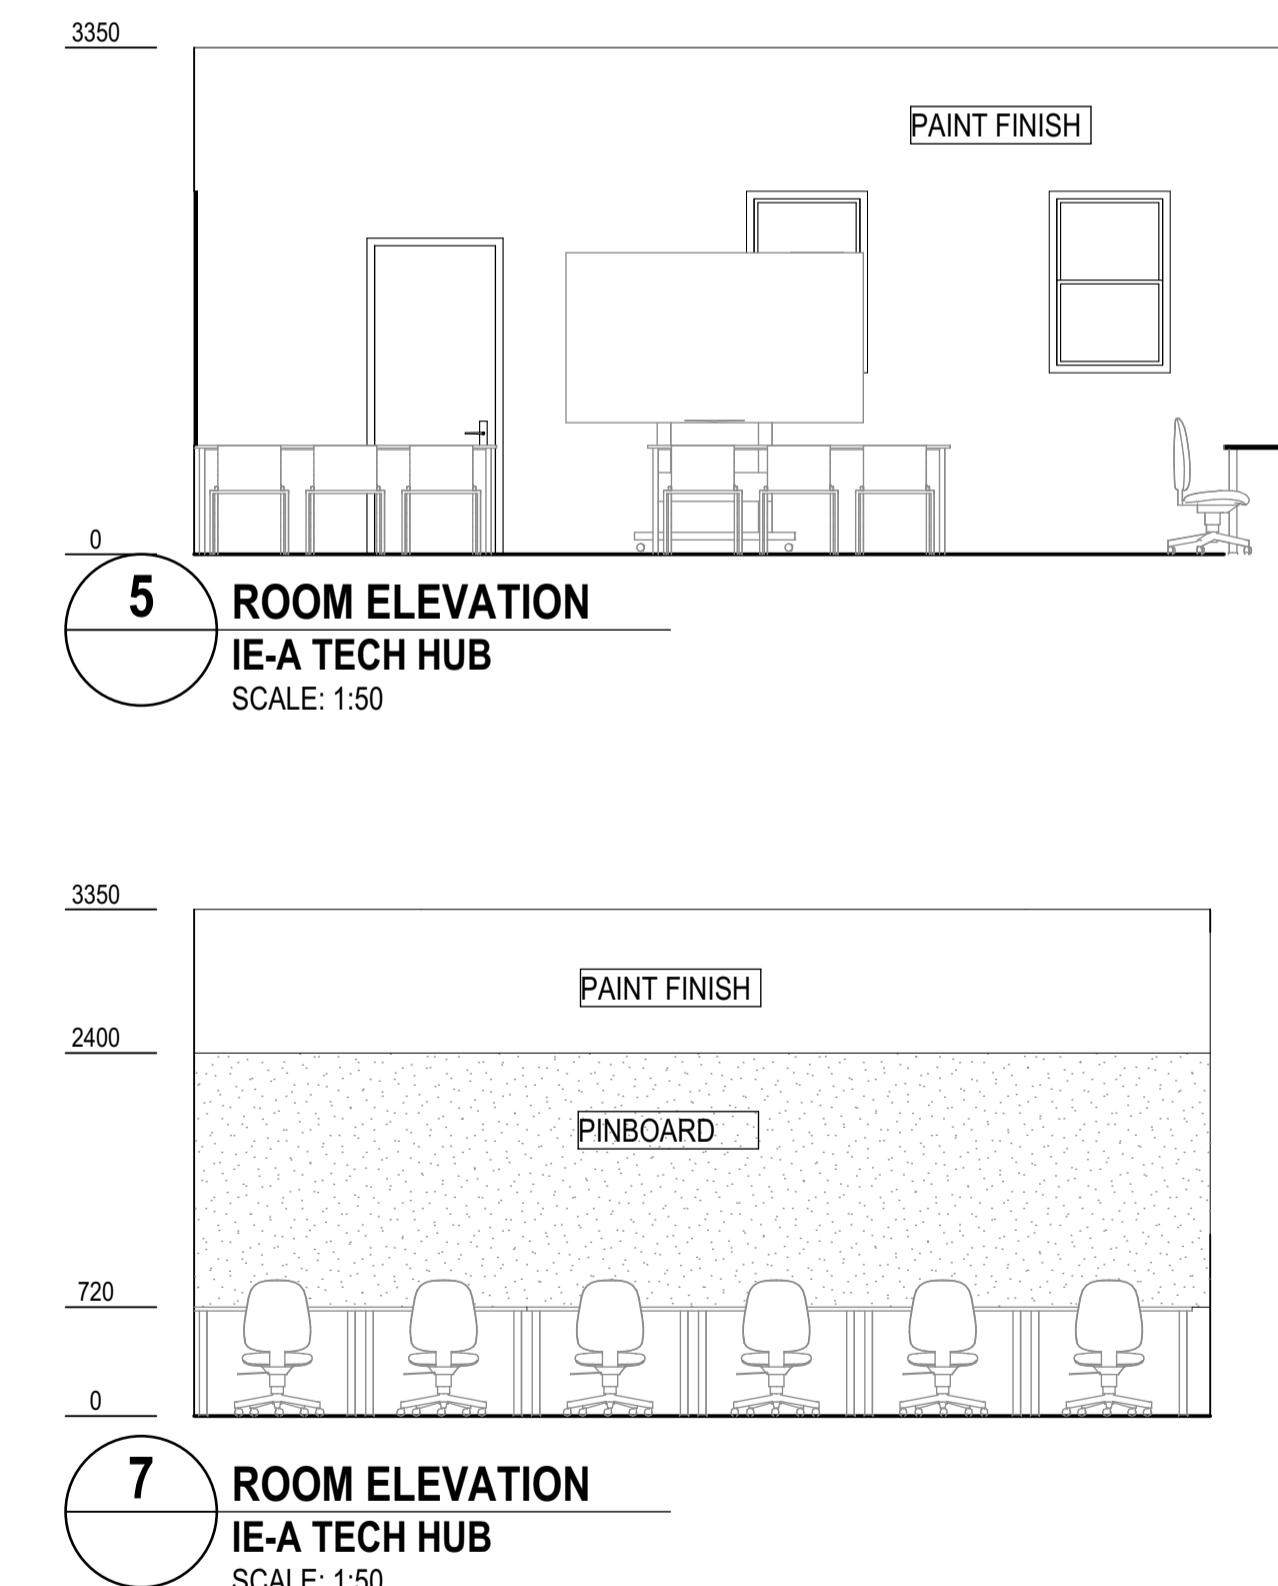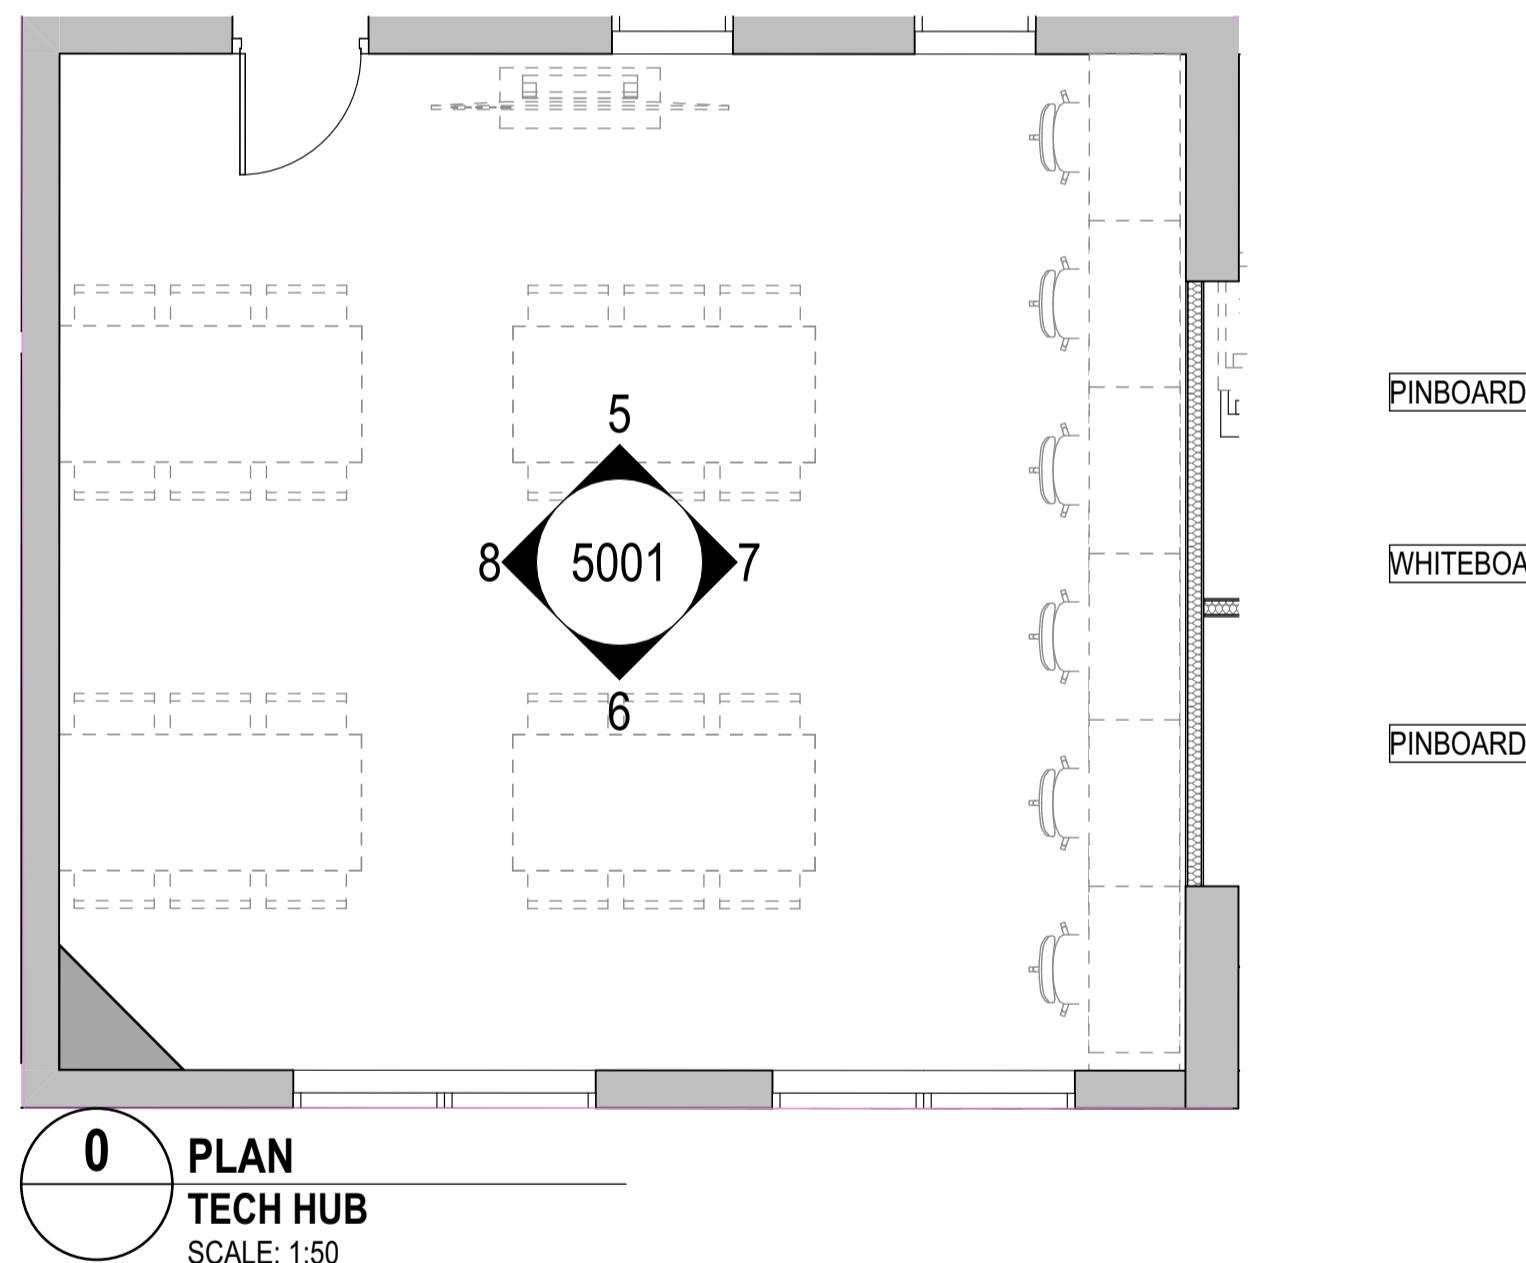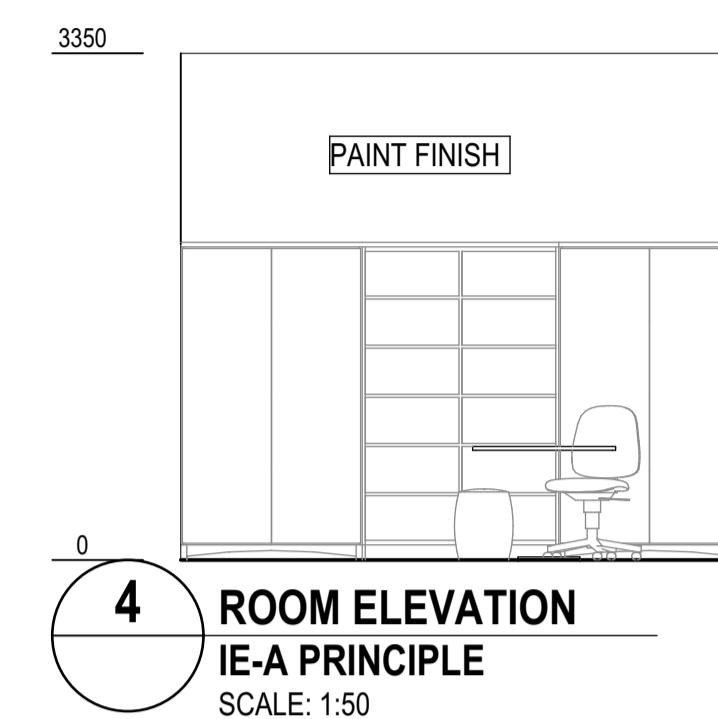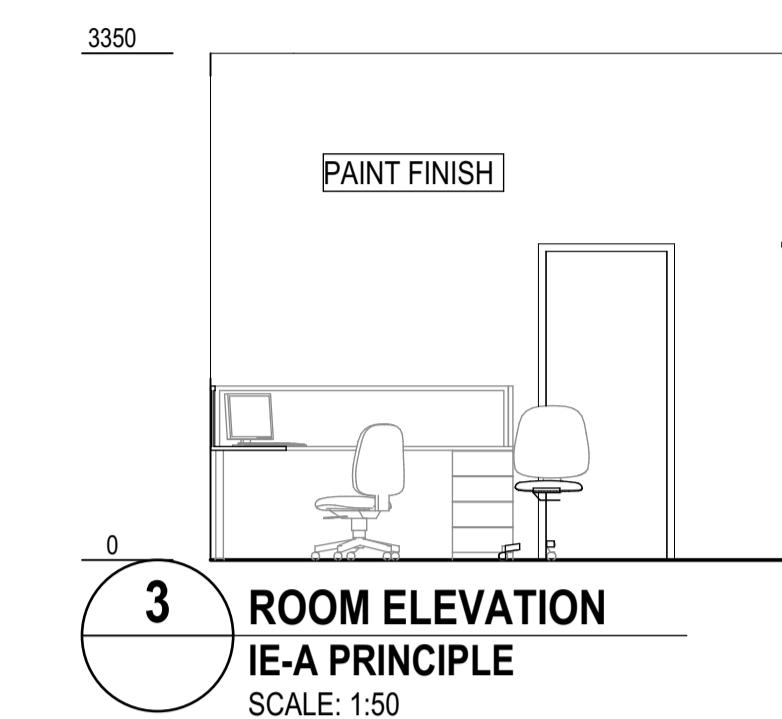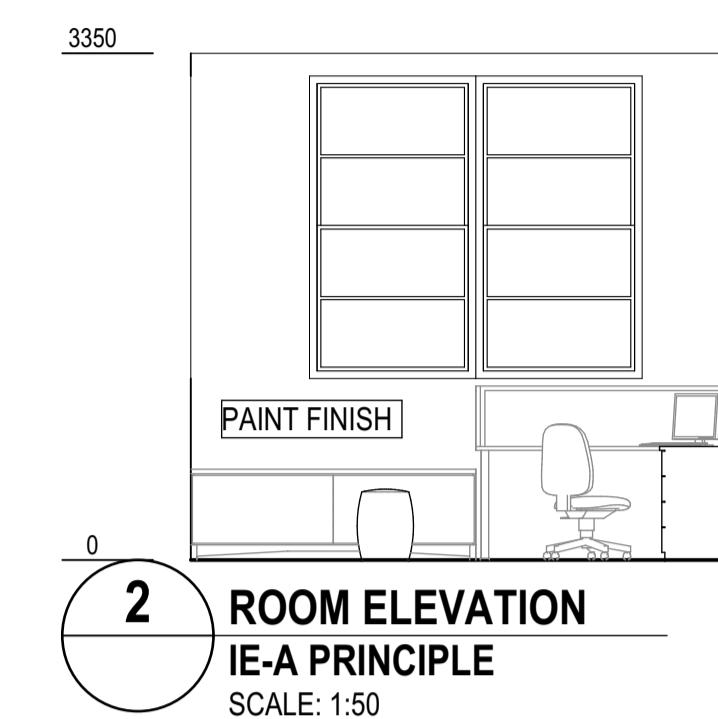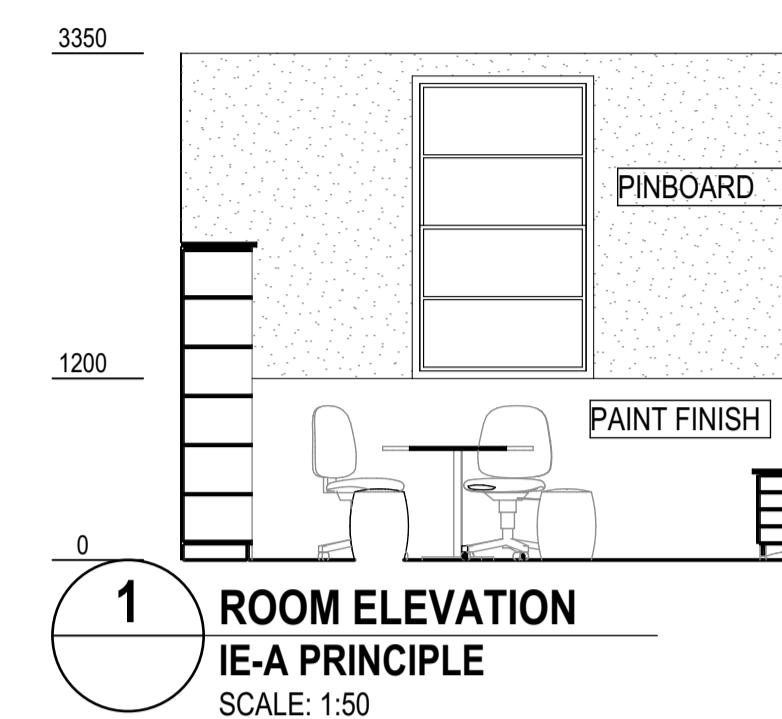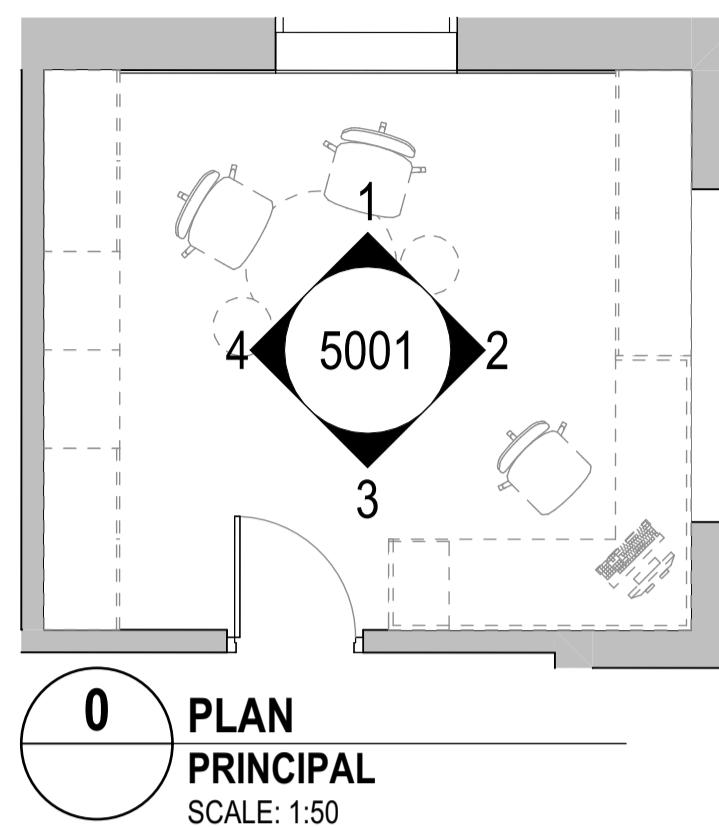PROJECT PHASE  
**SCHEMATIC DESIGN**  
SCHOOL INFRASTRUCTURE  
NSW

PROJECT CLIENT  
NORTHMEAD PUBLIC SCHOOL  
ADDRESS  
MOXHAMS ROAD,  
NORTHMEAD, NSW

BUILDING A - TECH HUB /  
PRINCIPAL ROOM

Figured dimensions take precedence over scale dimensions. Contractors must verify all dimensions on site before commencing any work or making shop drawings.


PROJECT NUMBER DIRECTOR  
**7068ND01** **JW**

DRAWING NUMBER  
**NPS-FTA-B00A-ZZ-DR-A-5001** **02**

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01	95% SCHEMATIC DESIGN	10/12/2024	AK

02 100% SCHEMATIC DESIGN 19/12/2024 NK  
01 95% SCHEMATIC DESIGN 10/12/2024 AK  
REV. DESCRIPTION DATE INIT.

02 100% SCHEMATIC DESIGN 19/12/2024 NK  
01 95% SCHEMATIC DESIGN 10/12/2024 AK  
REV. DESCRIPTION DATE INIT.

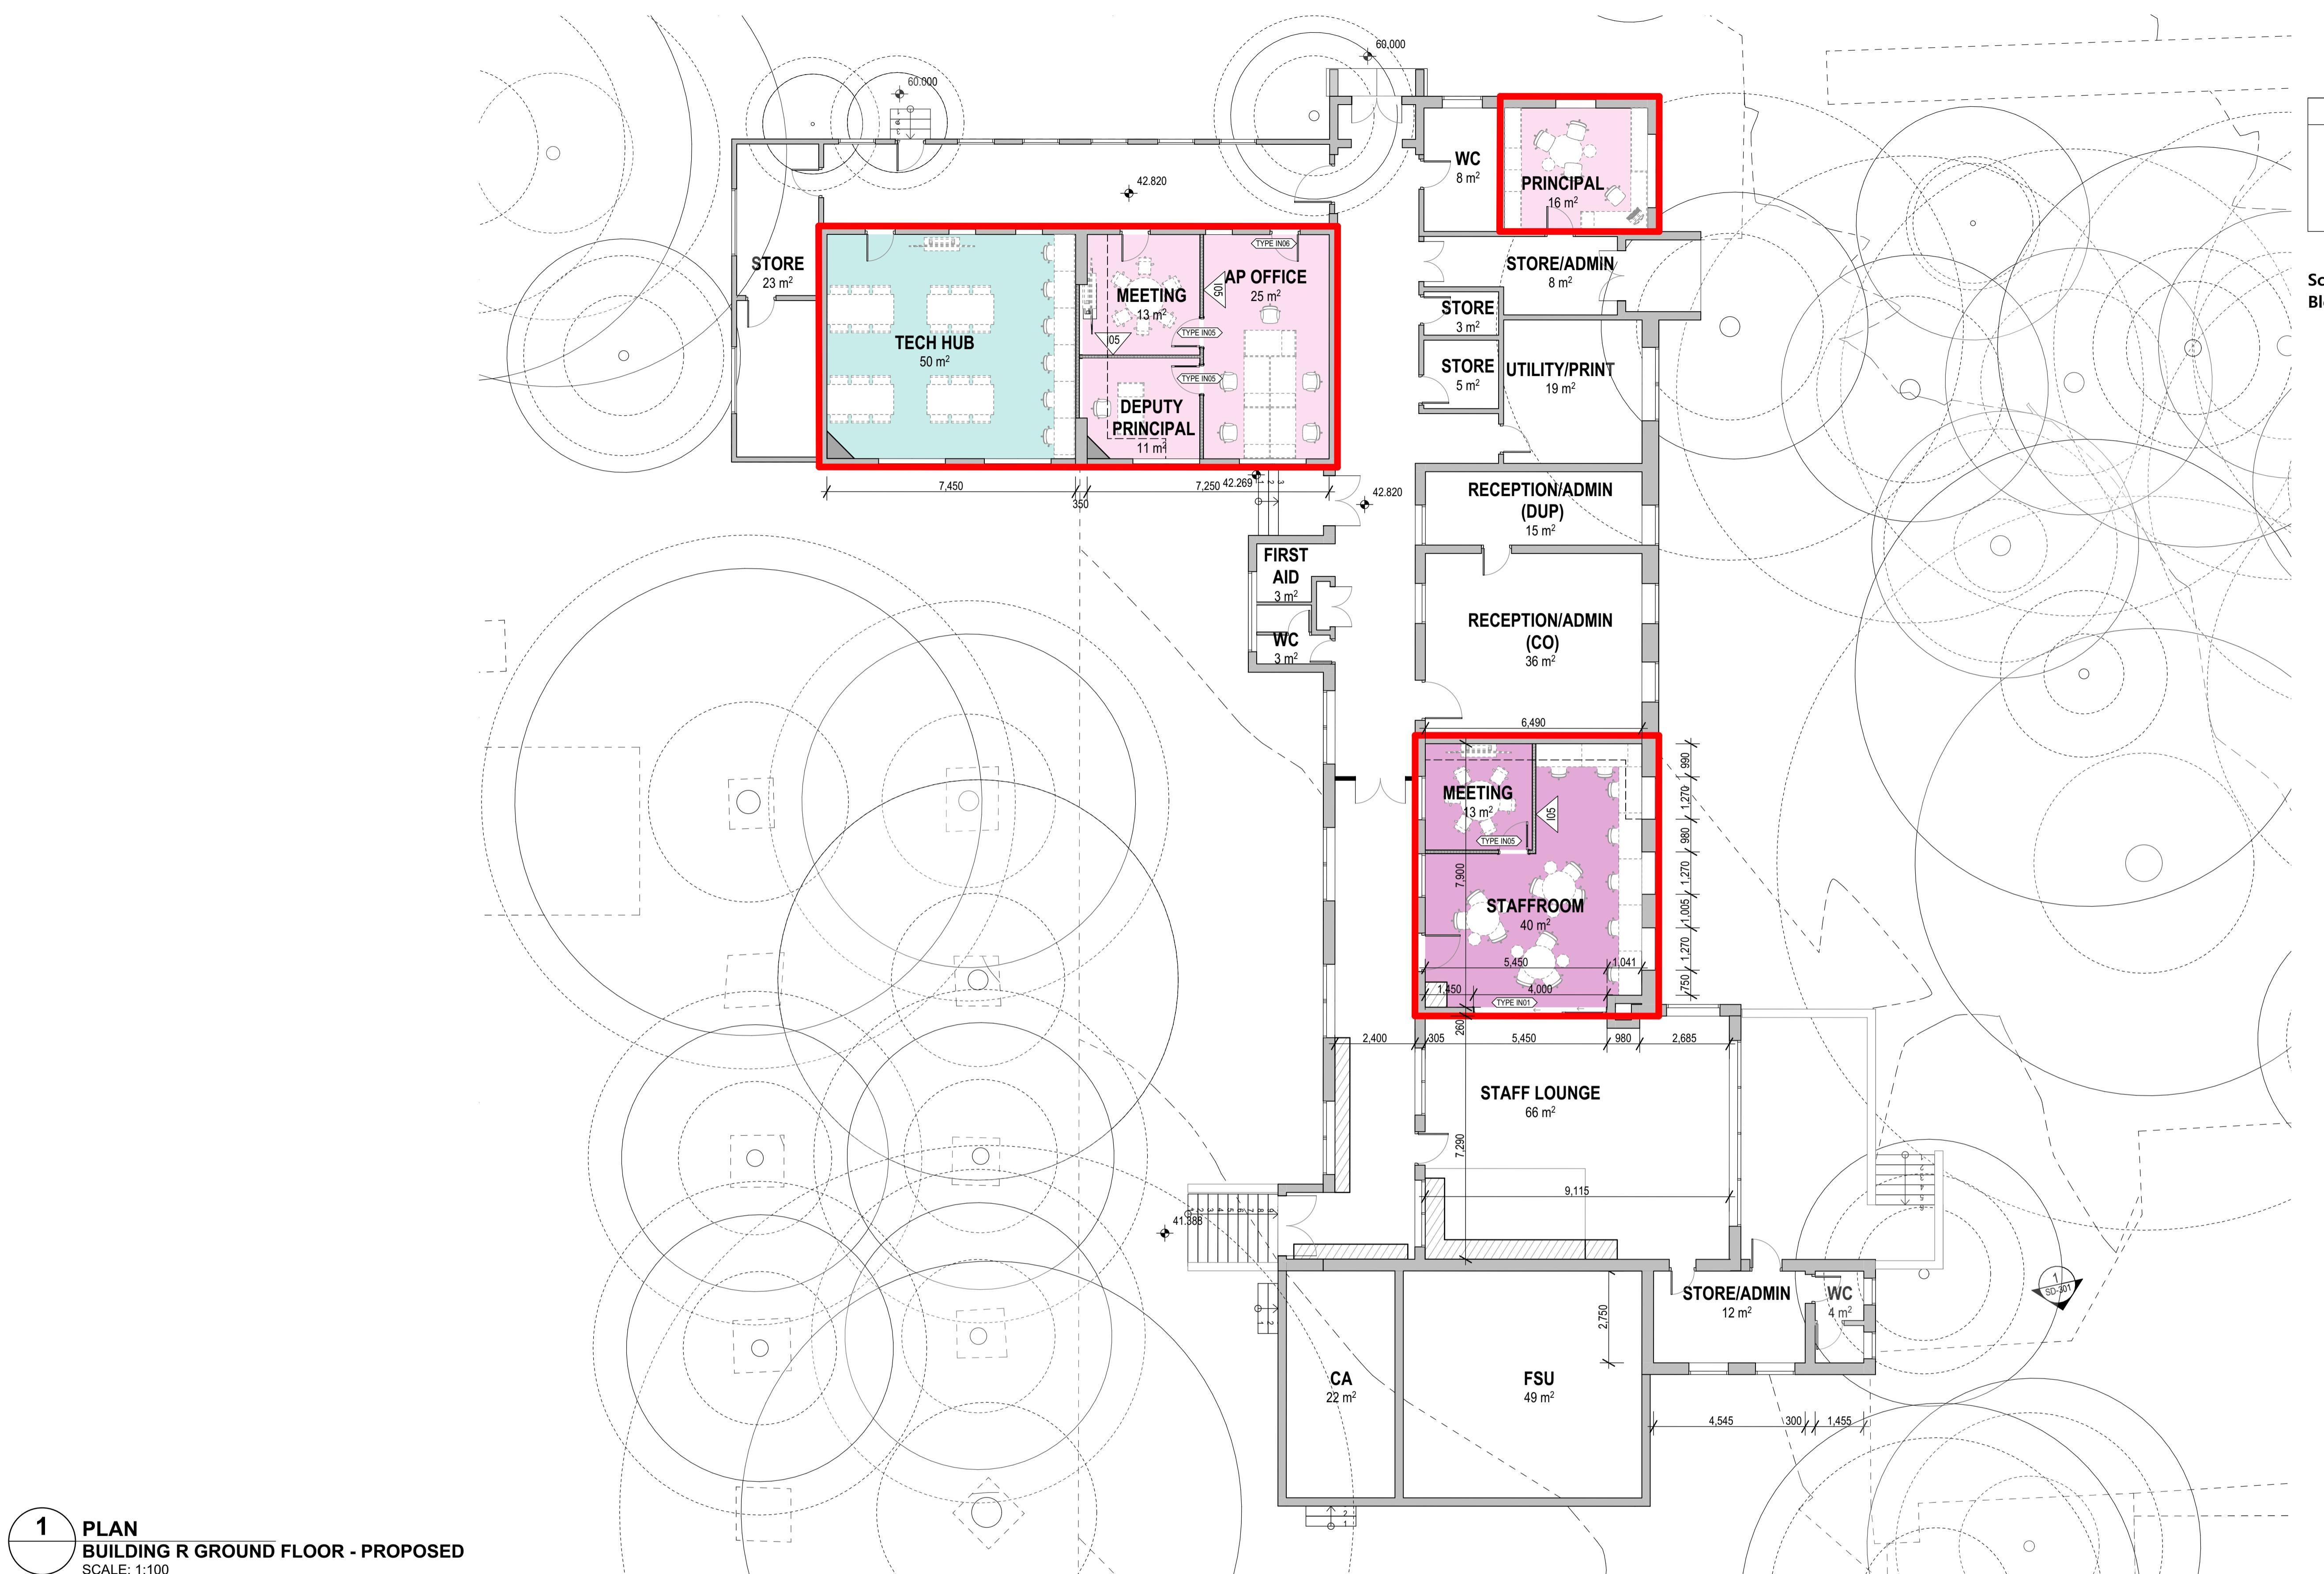

**1 PLAN**  
BUILDING R GROUND FLOOR - PROPOSED  
SCALE: 1:100


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02	80% SCHEMATIC DESIGN	26/11/2024	AK
01	SD-01 - 50% SCHEMATIC DESIGN	15/11/2024	AK

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1 (02) 8383 5151 e. [sydney@fultontrotter.com.au](mailto:sydney@fultontrotter.com.au)  
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PROJECT NUMBER: **7068ND01** DIRECTOR: **JW** CHECKED: **NK**  
DRAWING NUMBER: **NPS-FTA-B00A-GF-DR-A-2101** REVISION: **03**  
PHASE: **SCHEMATIC DESIGN**  
PROJECT: **SCHOOL INFRASTRUCTURE NSW**  
CLIENT: **NORTHMEAD PUBLIC SCHOOL**  
ADDRESS: **MOXHAMS ROAD, NORTHMEAD, NSW**

Figured dimensions take precedence over scale dimensions. Contractors must verify all dimensions on site before commencing any work or making shop drawings.

N  
1  
SD-01

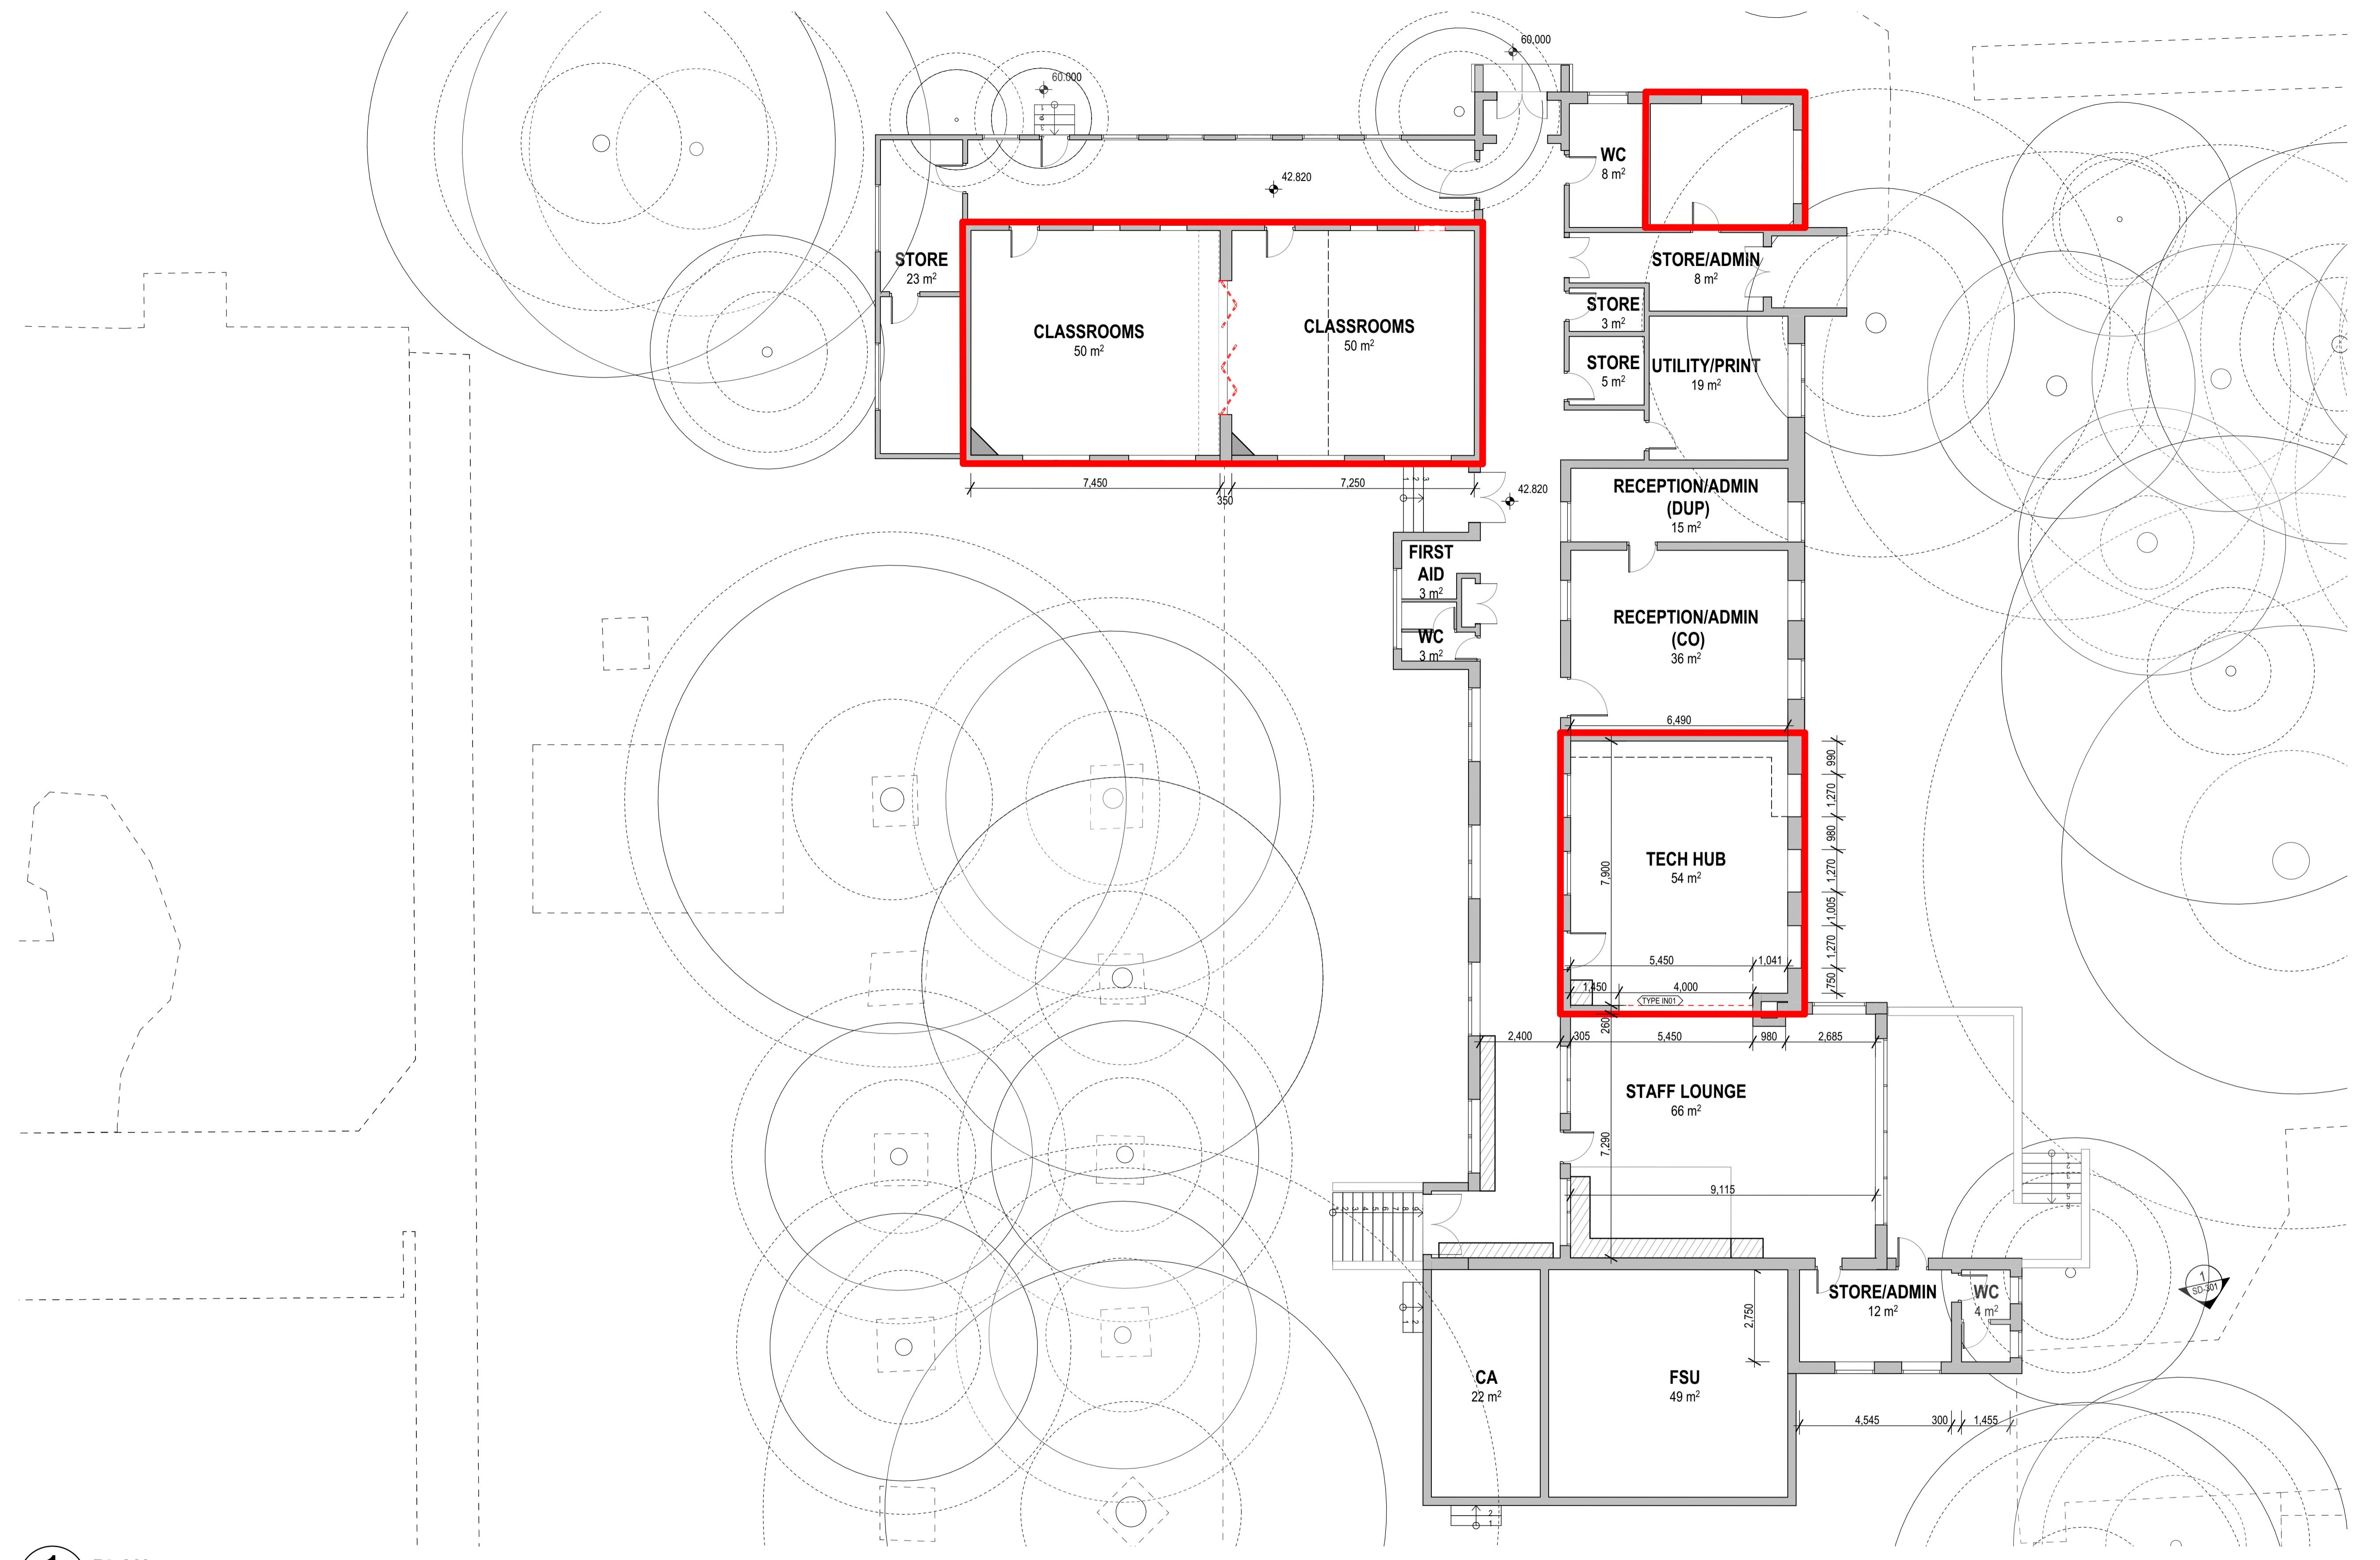

**1 PLAN  
BUILDING R GROUND FLOOR EXISTING  
SCALE: 1:100**

plot date: Thursday, 19 December 2024 2:46 PM file location: BIMcloud: FTA-SYD-BIM26 - BIMcloud Basic for Archicad 26/7068ND01 Northmead Public School

REV.	DESCRIPTION	DATE	INIT.
04	100% SCHEMATIC DESIGN	19/12/2024	NK
03	95% SCHEMATIC DESIGN	10/12/2024	AK
02		26/11/2024	
01	SD-01 - 50% SCHEMATIC DESIGN	15/11/2024	AK

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QLD 3313

Justine Lozery fraia VIC 18804 NSW 8371 QLD 3313  
John Ward raia VIC 18804 NSW 7434 QLD 3847  
Katerina Dracopoulos fraia VIC 18804 NSW 7434 QLD 4529

Paul Sekava fraia NSW 7180 QLD 3108  
Ryan Loveday fraia QLD 4500

**PHASE** | **SCHEMATIC DESIGN**

---

**CLIENT** | **SCHOOL INFRASTRUCTURE NSW**

---

**PROJECT** | **NORTHMEAD PUBLIC SCHOOL**

---

**ADDRESS** | **MOXHAMS ROAD,  
NORTHMEAD, NSW**

# **BUILDING A - EXISTING GROUND FLOOR PLAN**

any work or making shop drawings.


**PROJECT NUMBER** 123456789 **DIRECTOR** John Doe

7068ND01 | JW

**DRAWING NUMBER**

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NBS ETA B00A GE DR A 3100



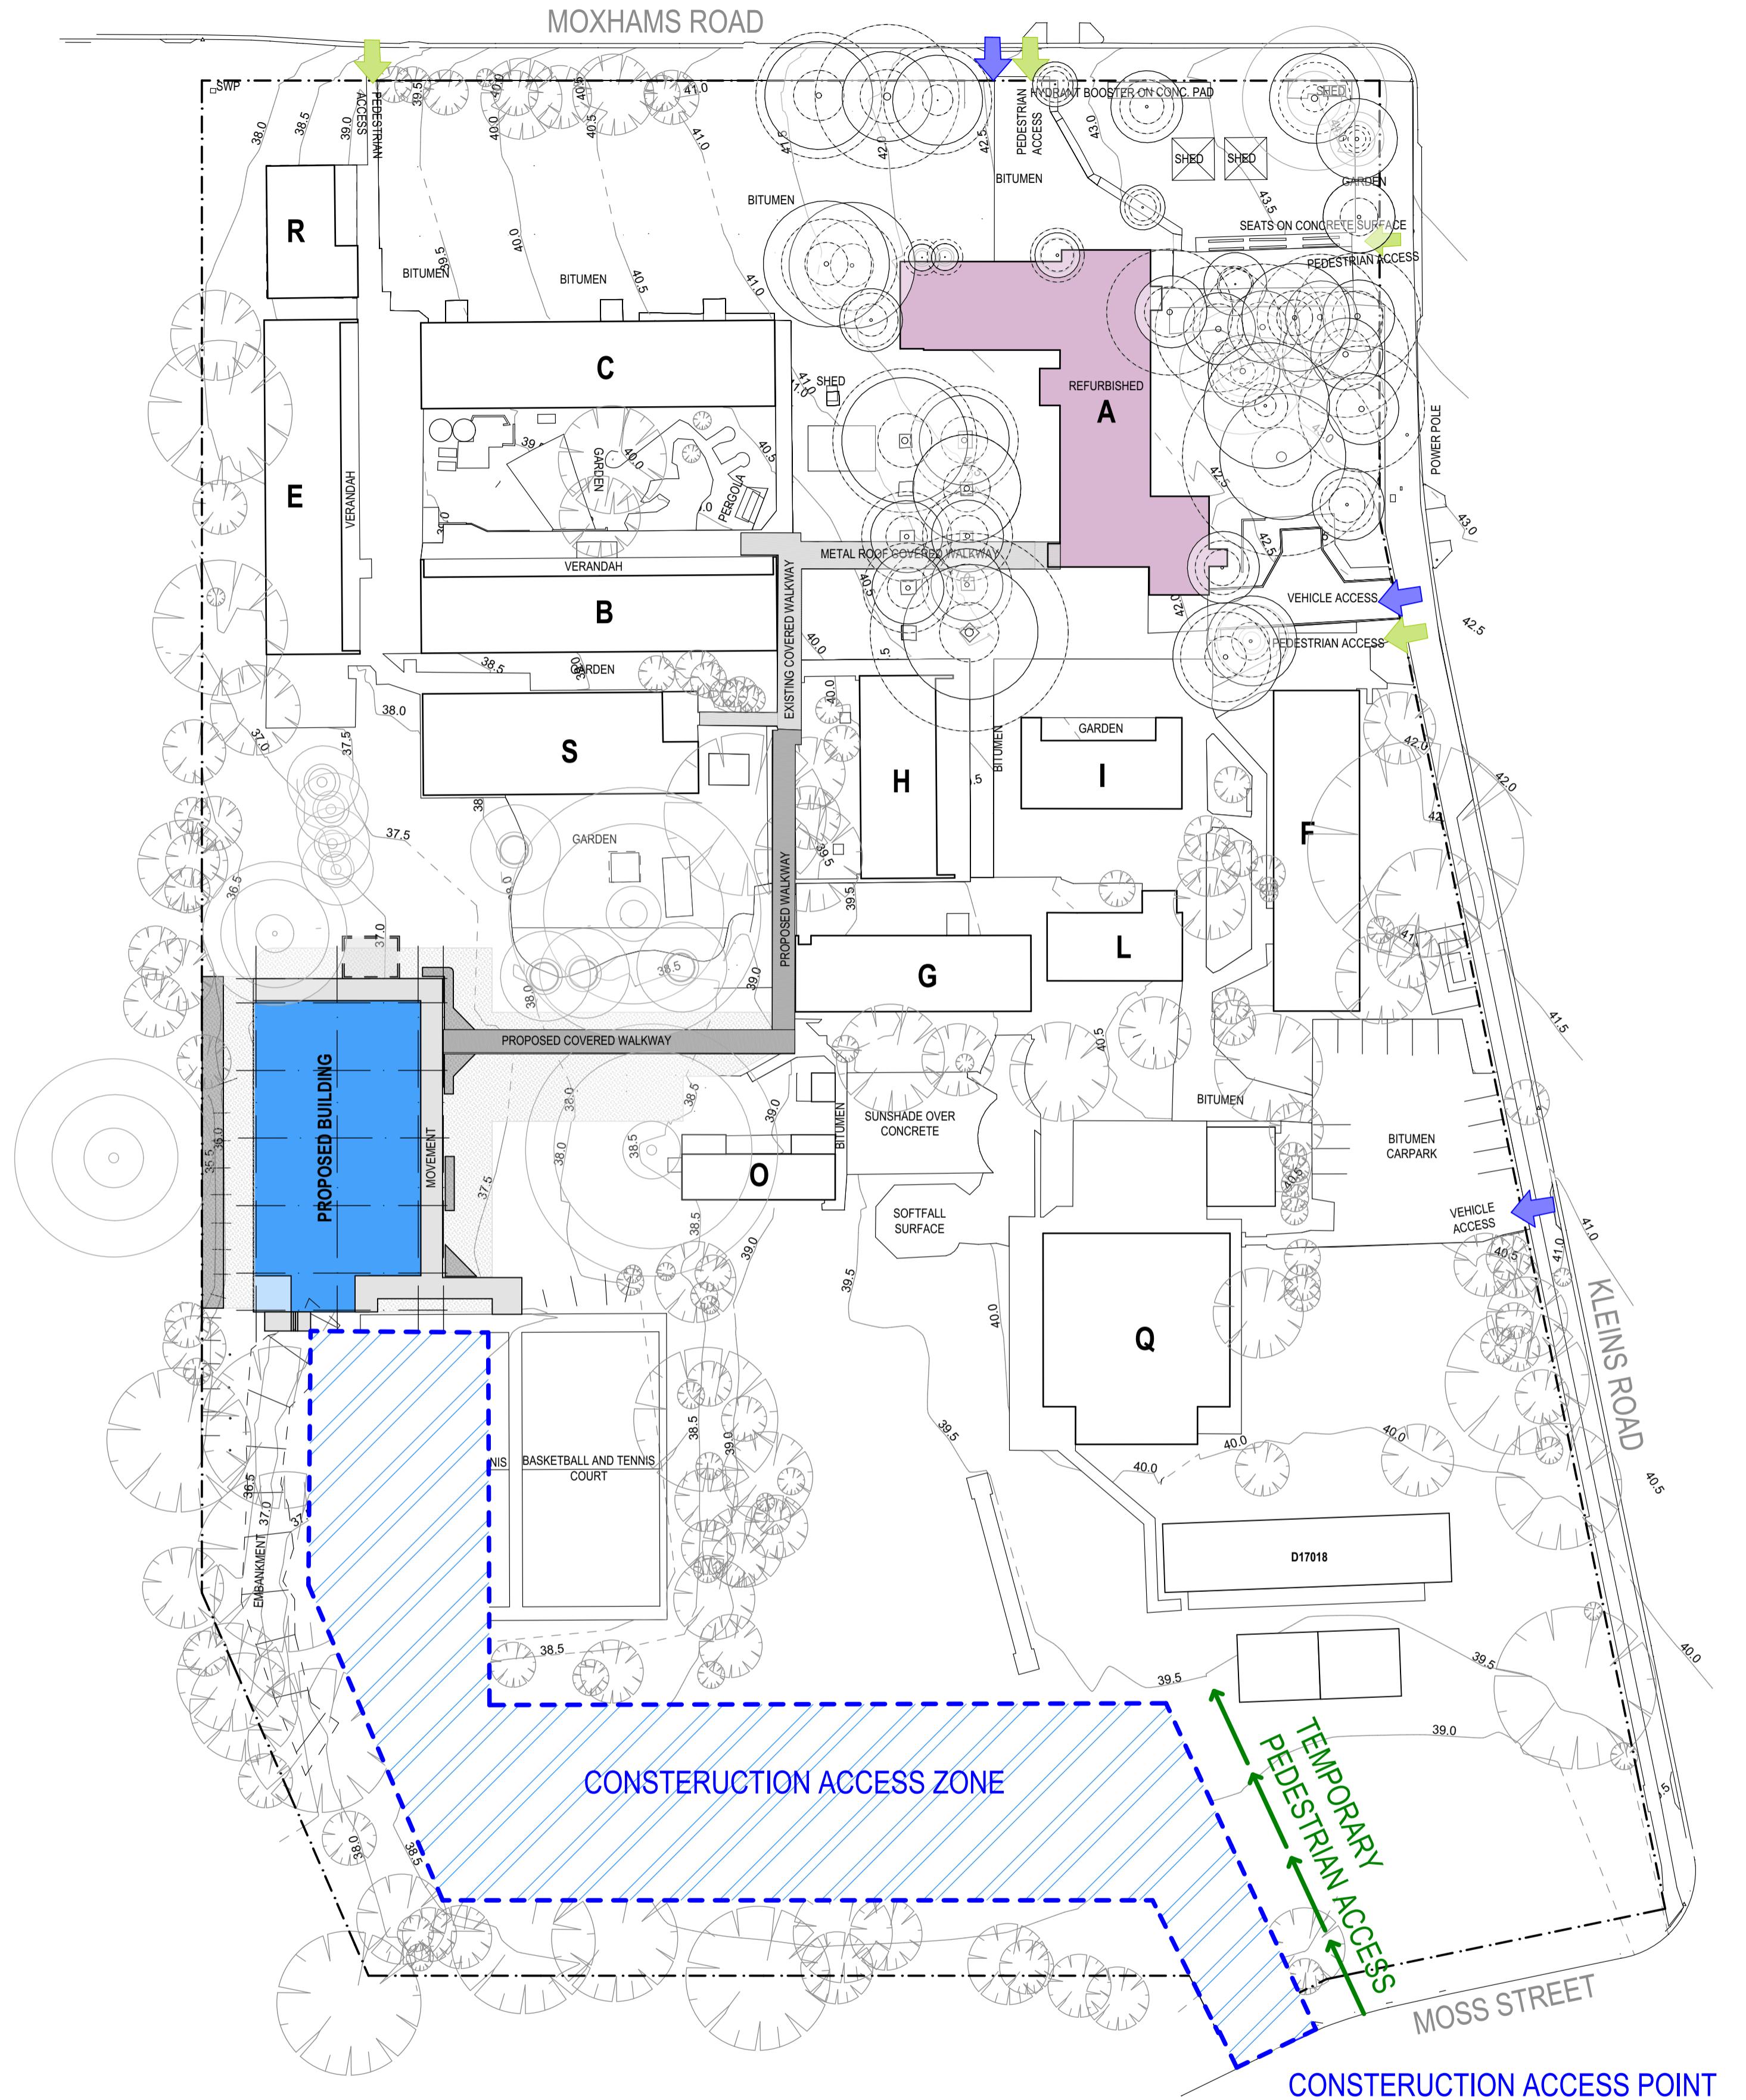

# **1 PLAN**

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## **CONSTRUCTION MANAGEMENT PLAN**

SCALE: 1:500

plot date: Thursday, 19 December 2024 2:46 PM file location: BIMcloud: FTA-SYD-BIM26 - BIMcloud Basic for Archicad 26/7068ND01 Northmead Public School

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**PHASE** | **SCHEMATIC DESIGN**  
**CLIENT** | **SCHOOL INFRASTRUCTURE**  
**NSW**

---


**PROJECT** | **NORTHMEAD PUBLIC SCHOOL**

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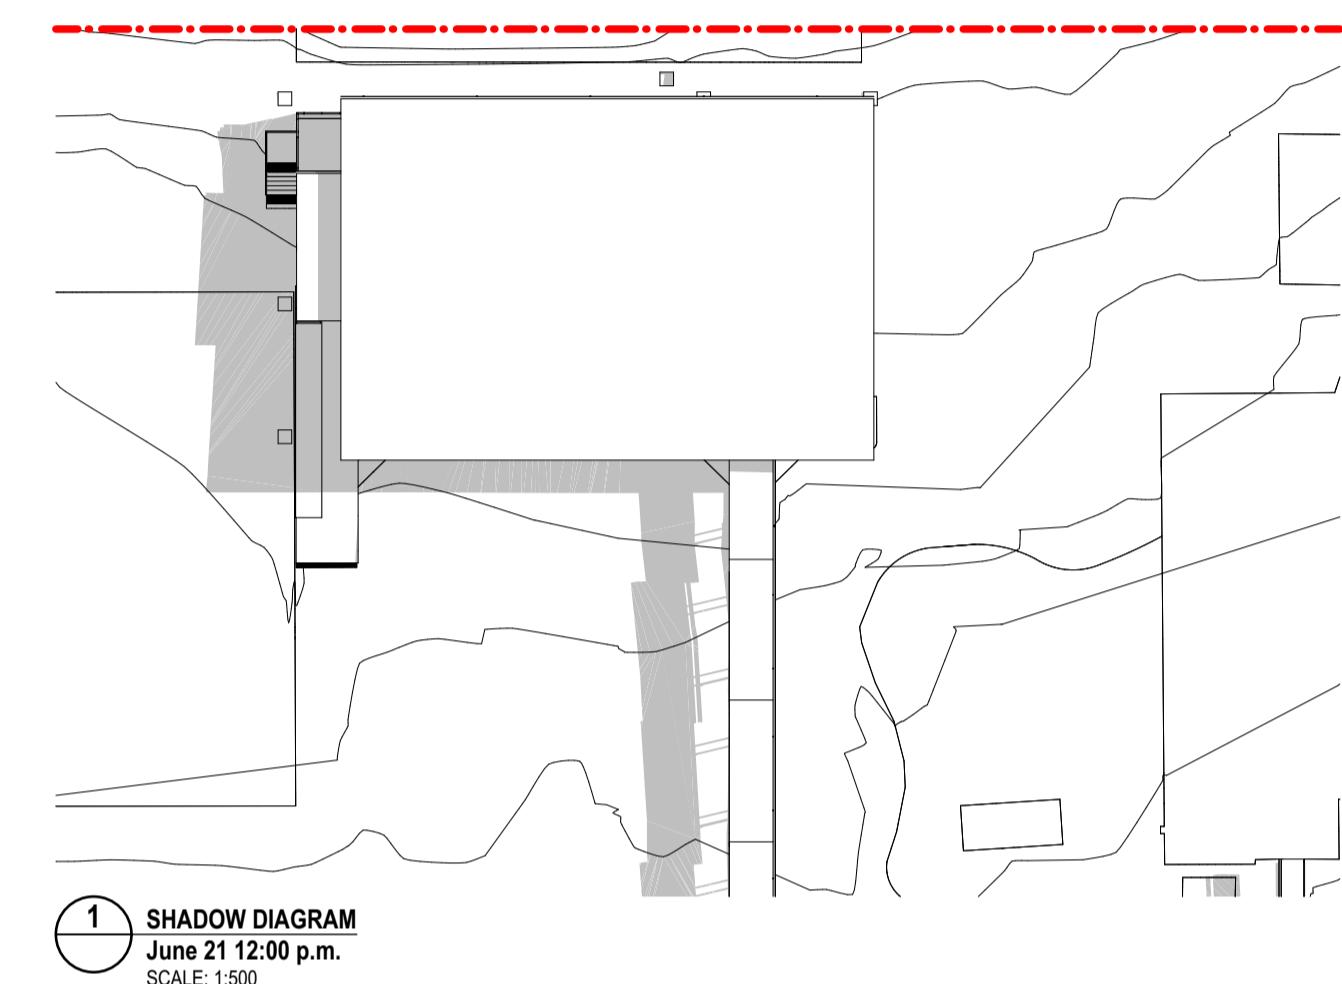
**ADDRESS** | **MOXHAMS ROAD,  
NORTHMEAD, NSW**

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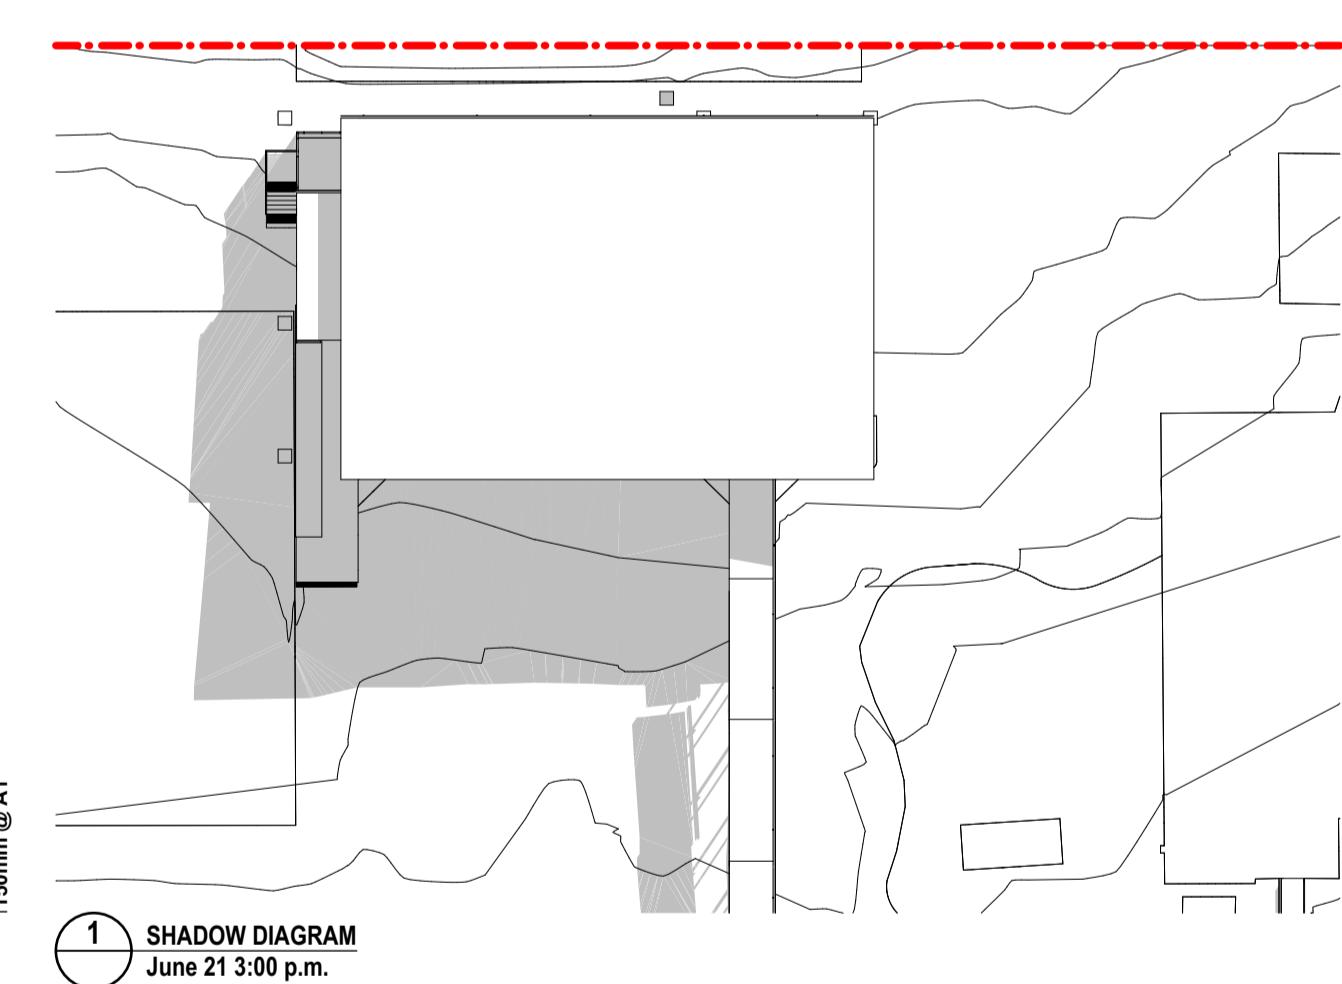
<b>CONSTRUCTION MANAGEMENT STRATEGY</b>	
ured dimensions take precedence over ale dimensions. Contractors must verify dimensions on site before commencing y work or making shop drawings.	
JECT NUMBER	DIRECTOR
<b>068ND01</b>	<b>JW</b>
WING NUMBER	CHE
<b>IPS-FTA-00-00-DR-A-1650</b>	
REV	O




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SCALE: 1:500

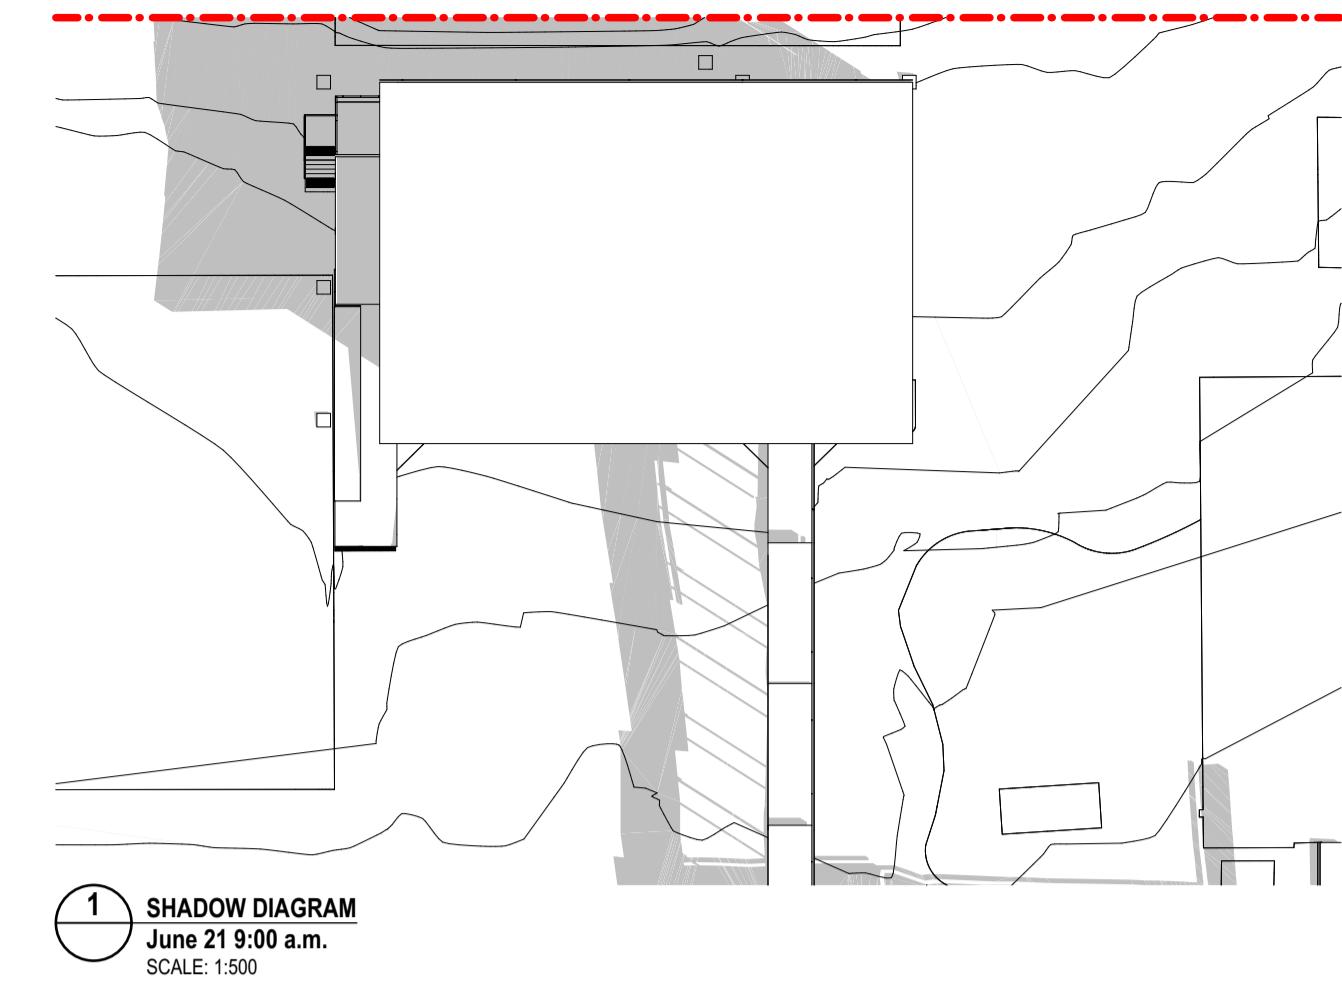


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SCALE: 1:500




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SCALE: 1:500

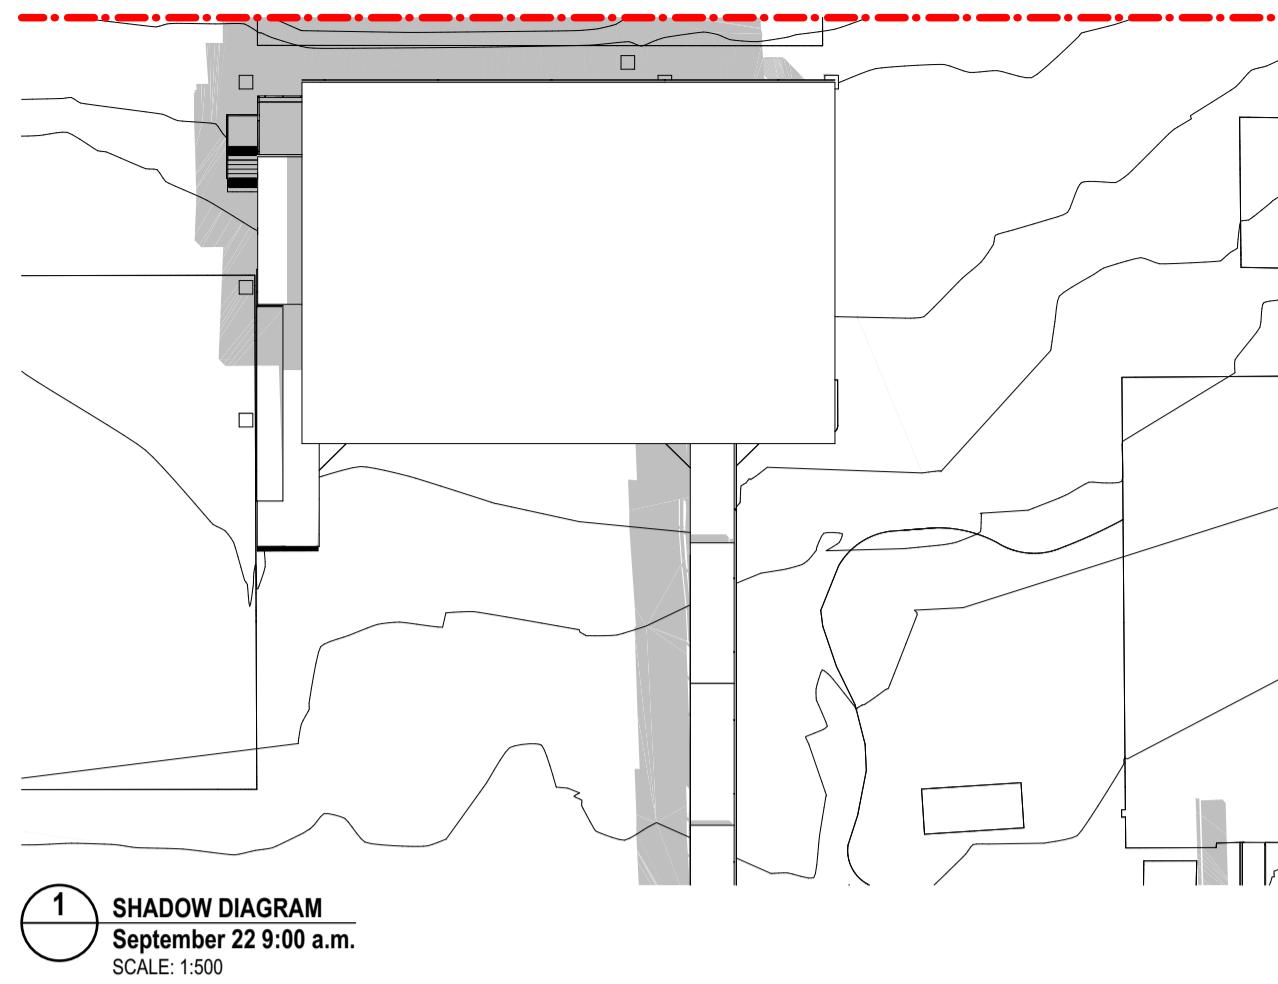


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SCALE: 1:500

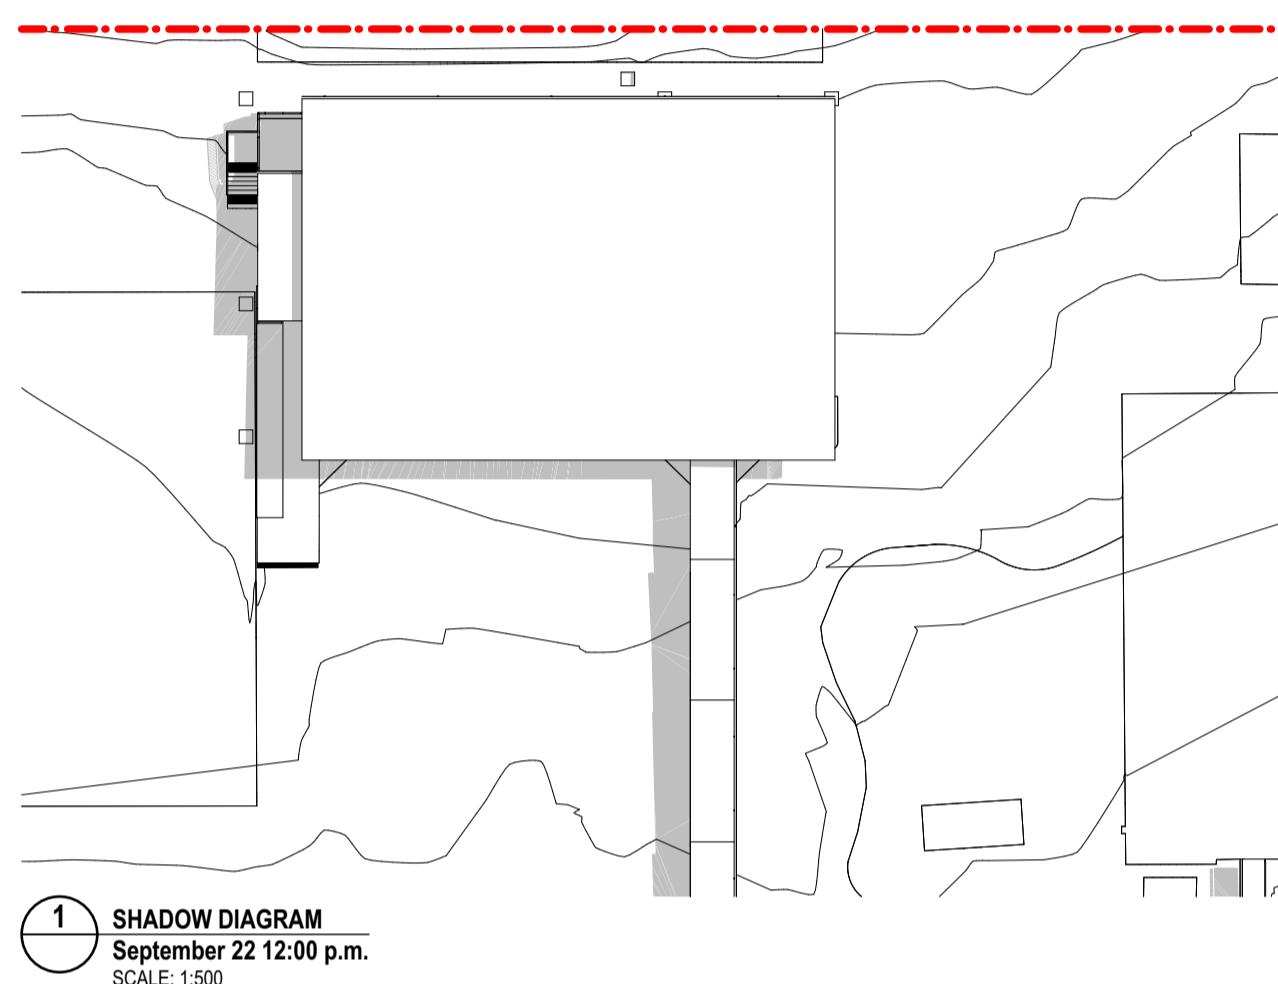


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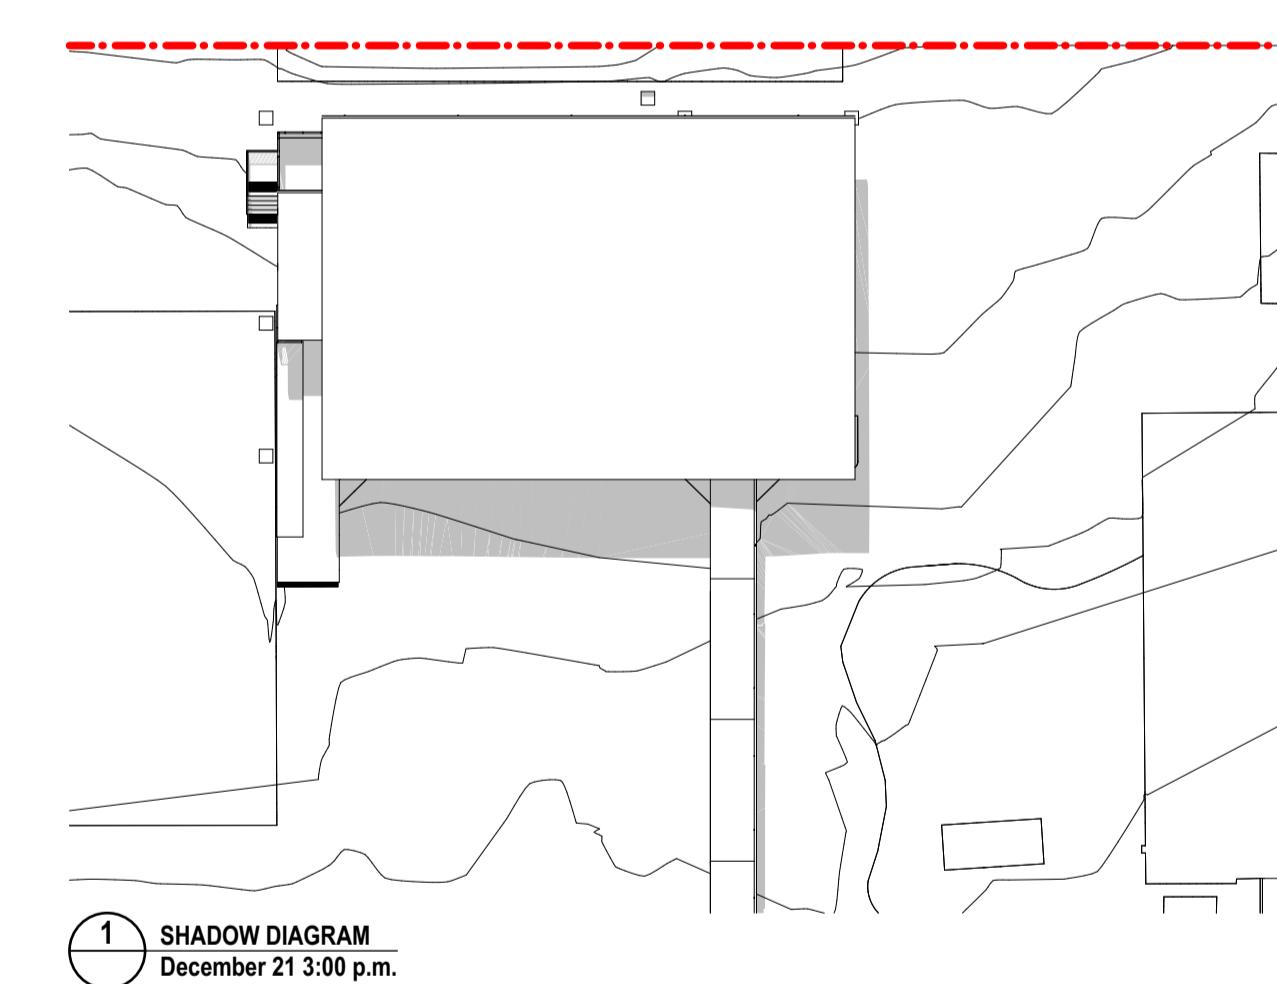
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1 SHADOW DIAGRAM  
December 21 9:00 a.m.  
SCALE: 1:500

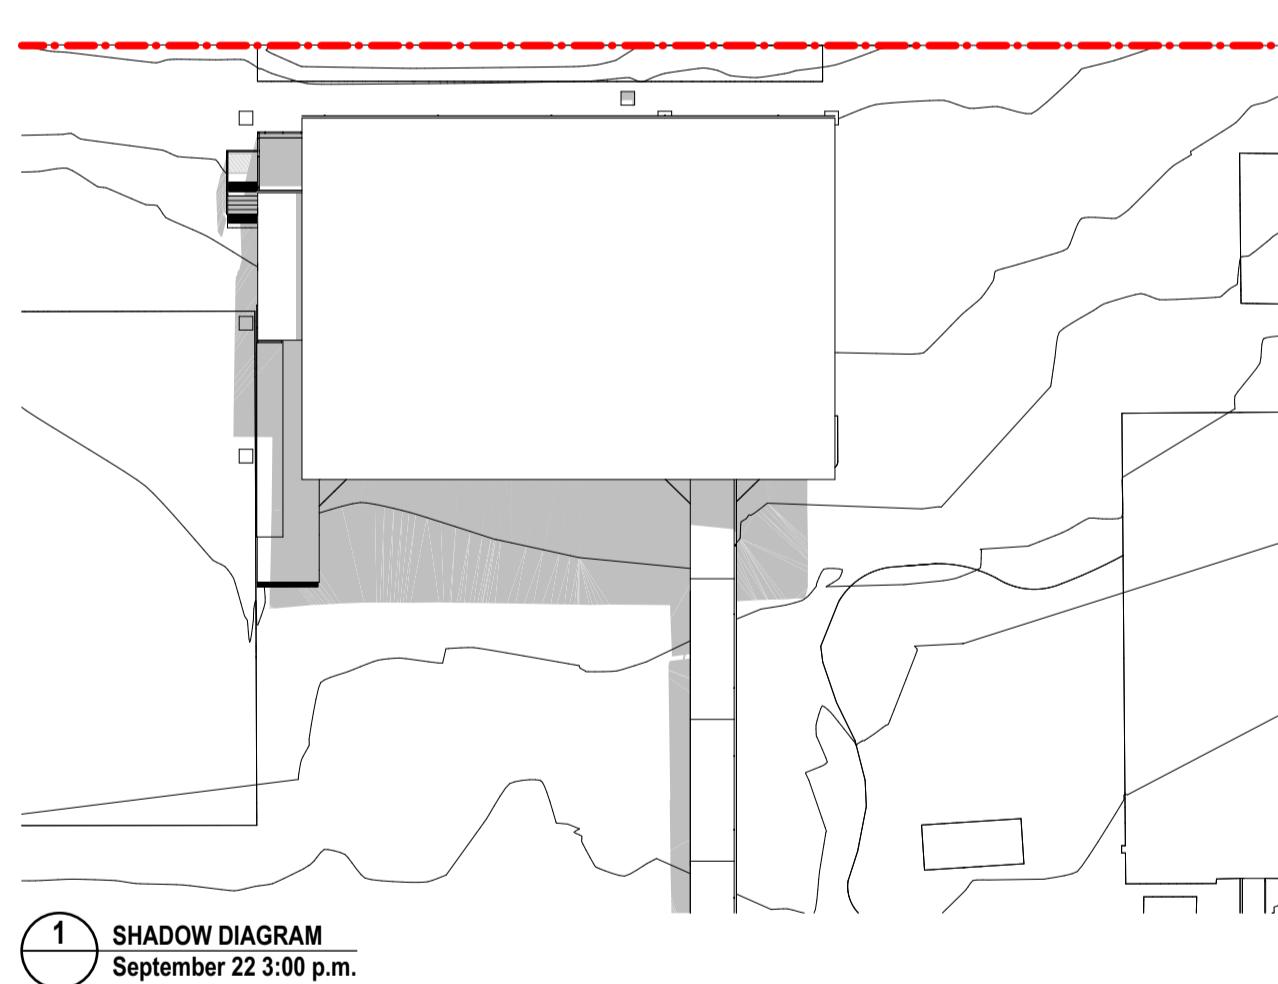

1 SHADOW DIAGRAM  
December 21 12:00 p.m.  
SCALE: 1:500

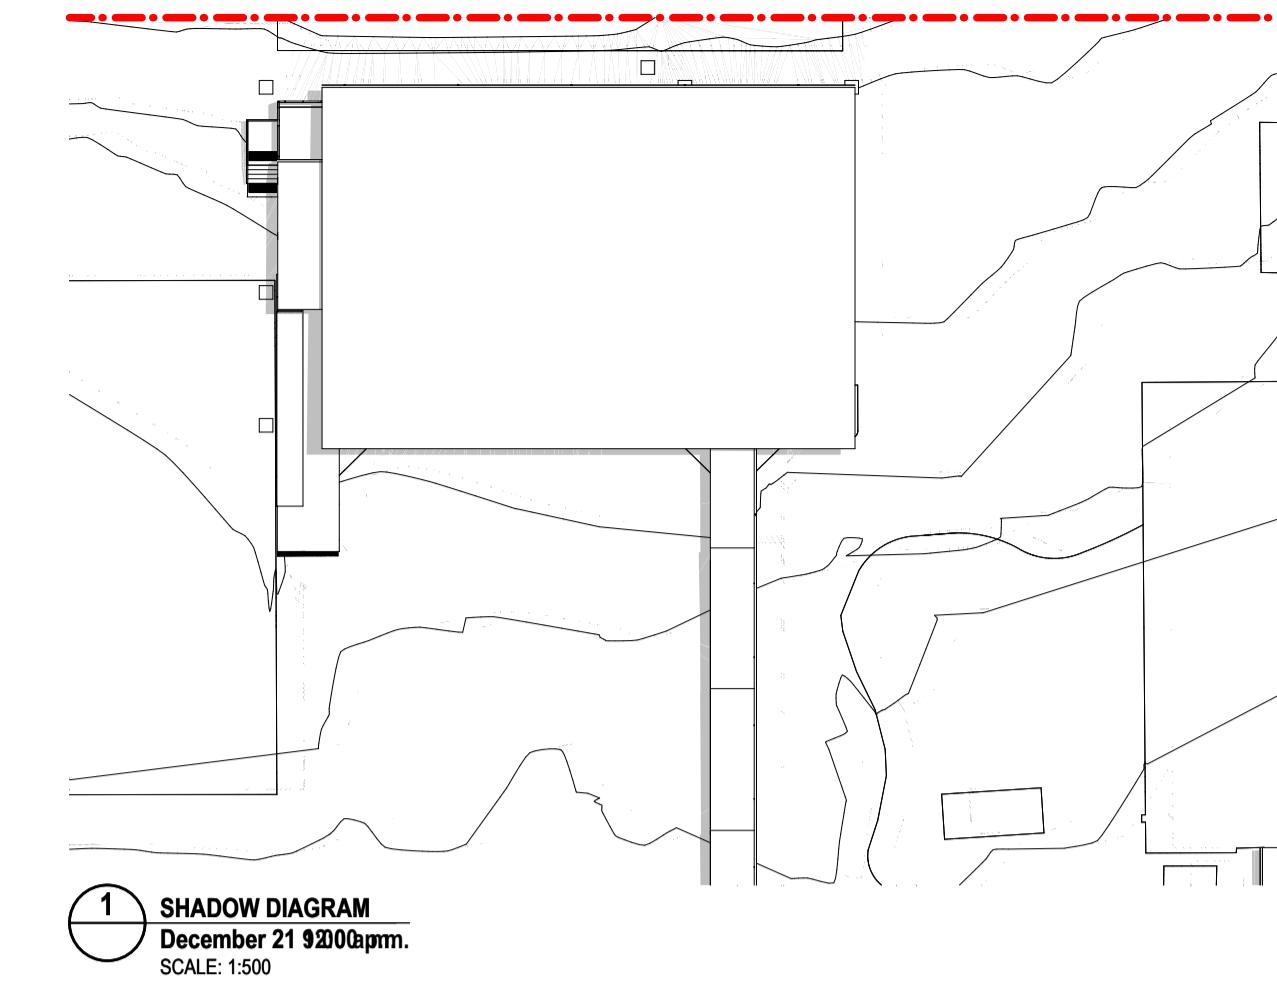

1 SHADOW DIAGRAM  
December 21 3:00 p.m.  
SCALE: 1:500

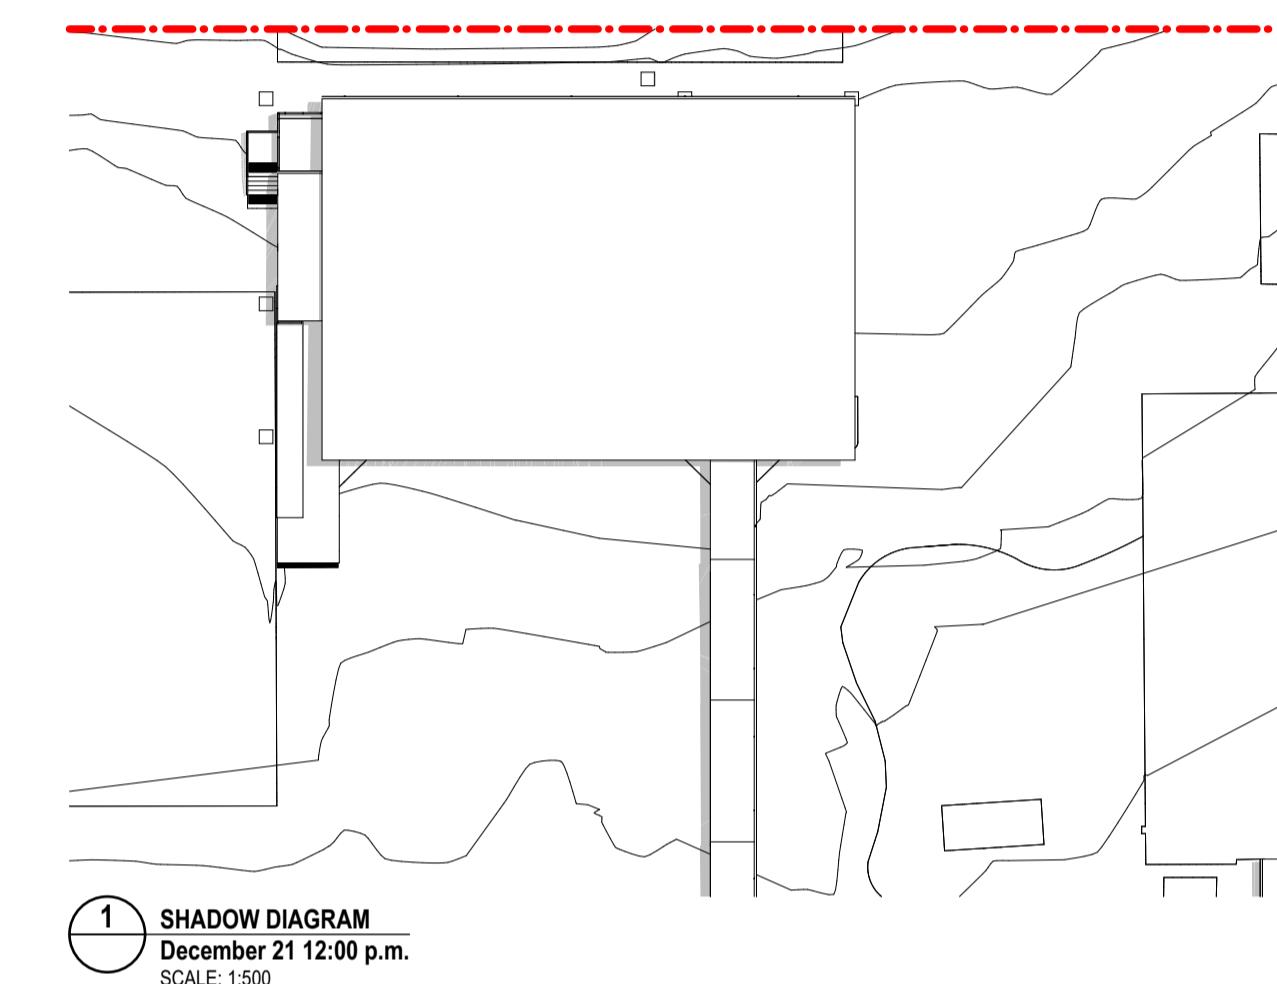150mm @ A1

100

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REV.	DESCRIPTION	DATE	INIT.
02	100% SCHEMATIC DESIGN	19/12/2024	AK
01	95% SCHEMATIC DESIGN	10/12/2024	AK

SYDNEY	Suite 904, Level 9, 26-38 Foveaux Street, Surry Hills, NSW 2010 1 (02) 8383 5151 e. sydney@fultontrotter.com.au	NSW 6855 QLD 2950 QLD 5313
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VIC 18804 NSW 8371 QLD 3847 NSW 7434 QLD 4529 NSW 7780 QLD 4518 Ryan Lovelady Frais		
NSW 6855 QLD 2950 QLD 5313		



PROJECT NUMBER: 7068ND01  
DRAWING NUMBER: NPS-FTA-00-00-DR-A-1640  
PHASE: SCHEMATIC DESIGN  
CLIENT: NORTHMEAD PUBLIC SCHOOL  
ADDRESS: MOXHAMS ROAD, NORTHMEAD, NSW

DIRECTOR: JW  
REVISION: 02  
CHECKED: NK

DRAWING NUMBER: NPS-FTA-00-00-DR-A-1640  
REVISION: 02  
CHECKED: NK

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all dimensions on site before commencing  
any work or making shop drawings.

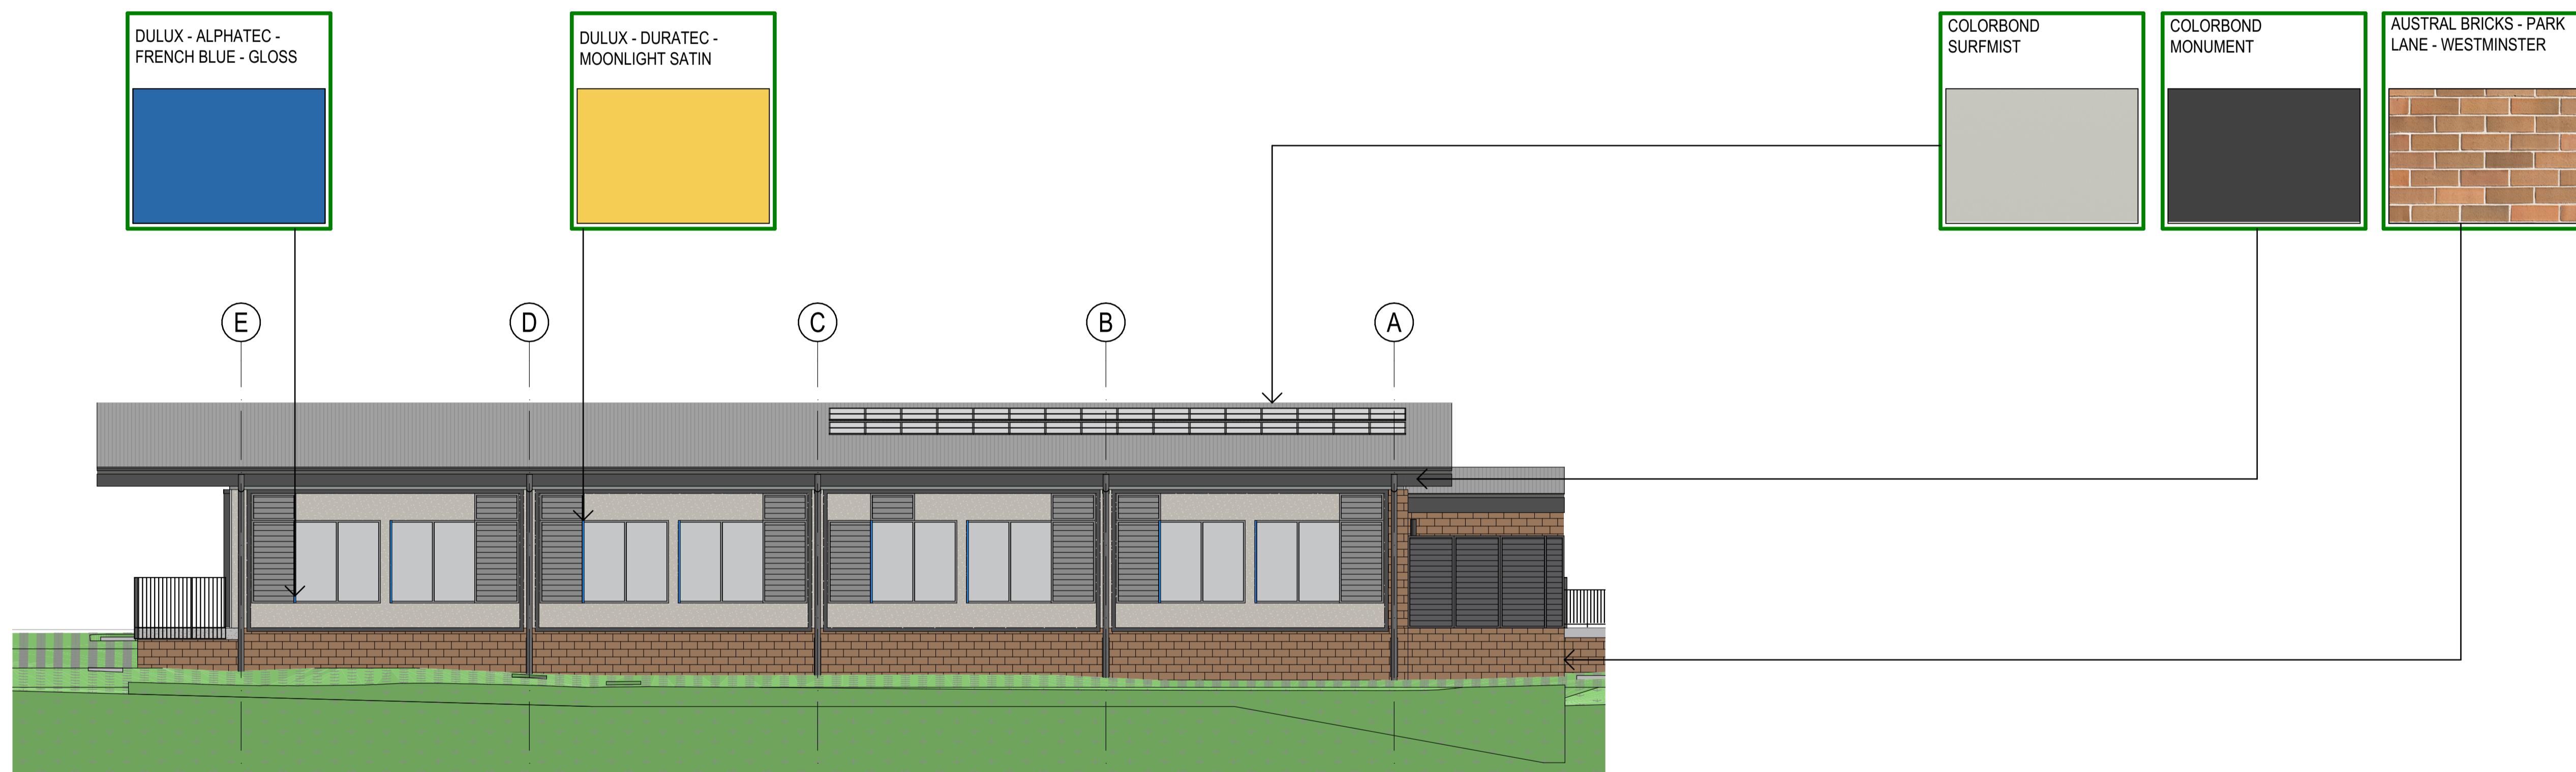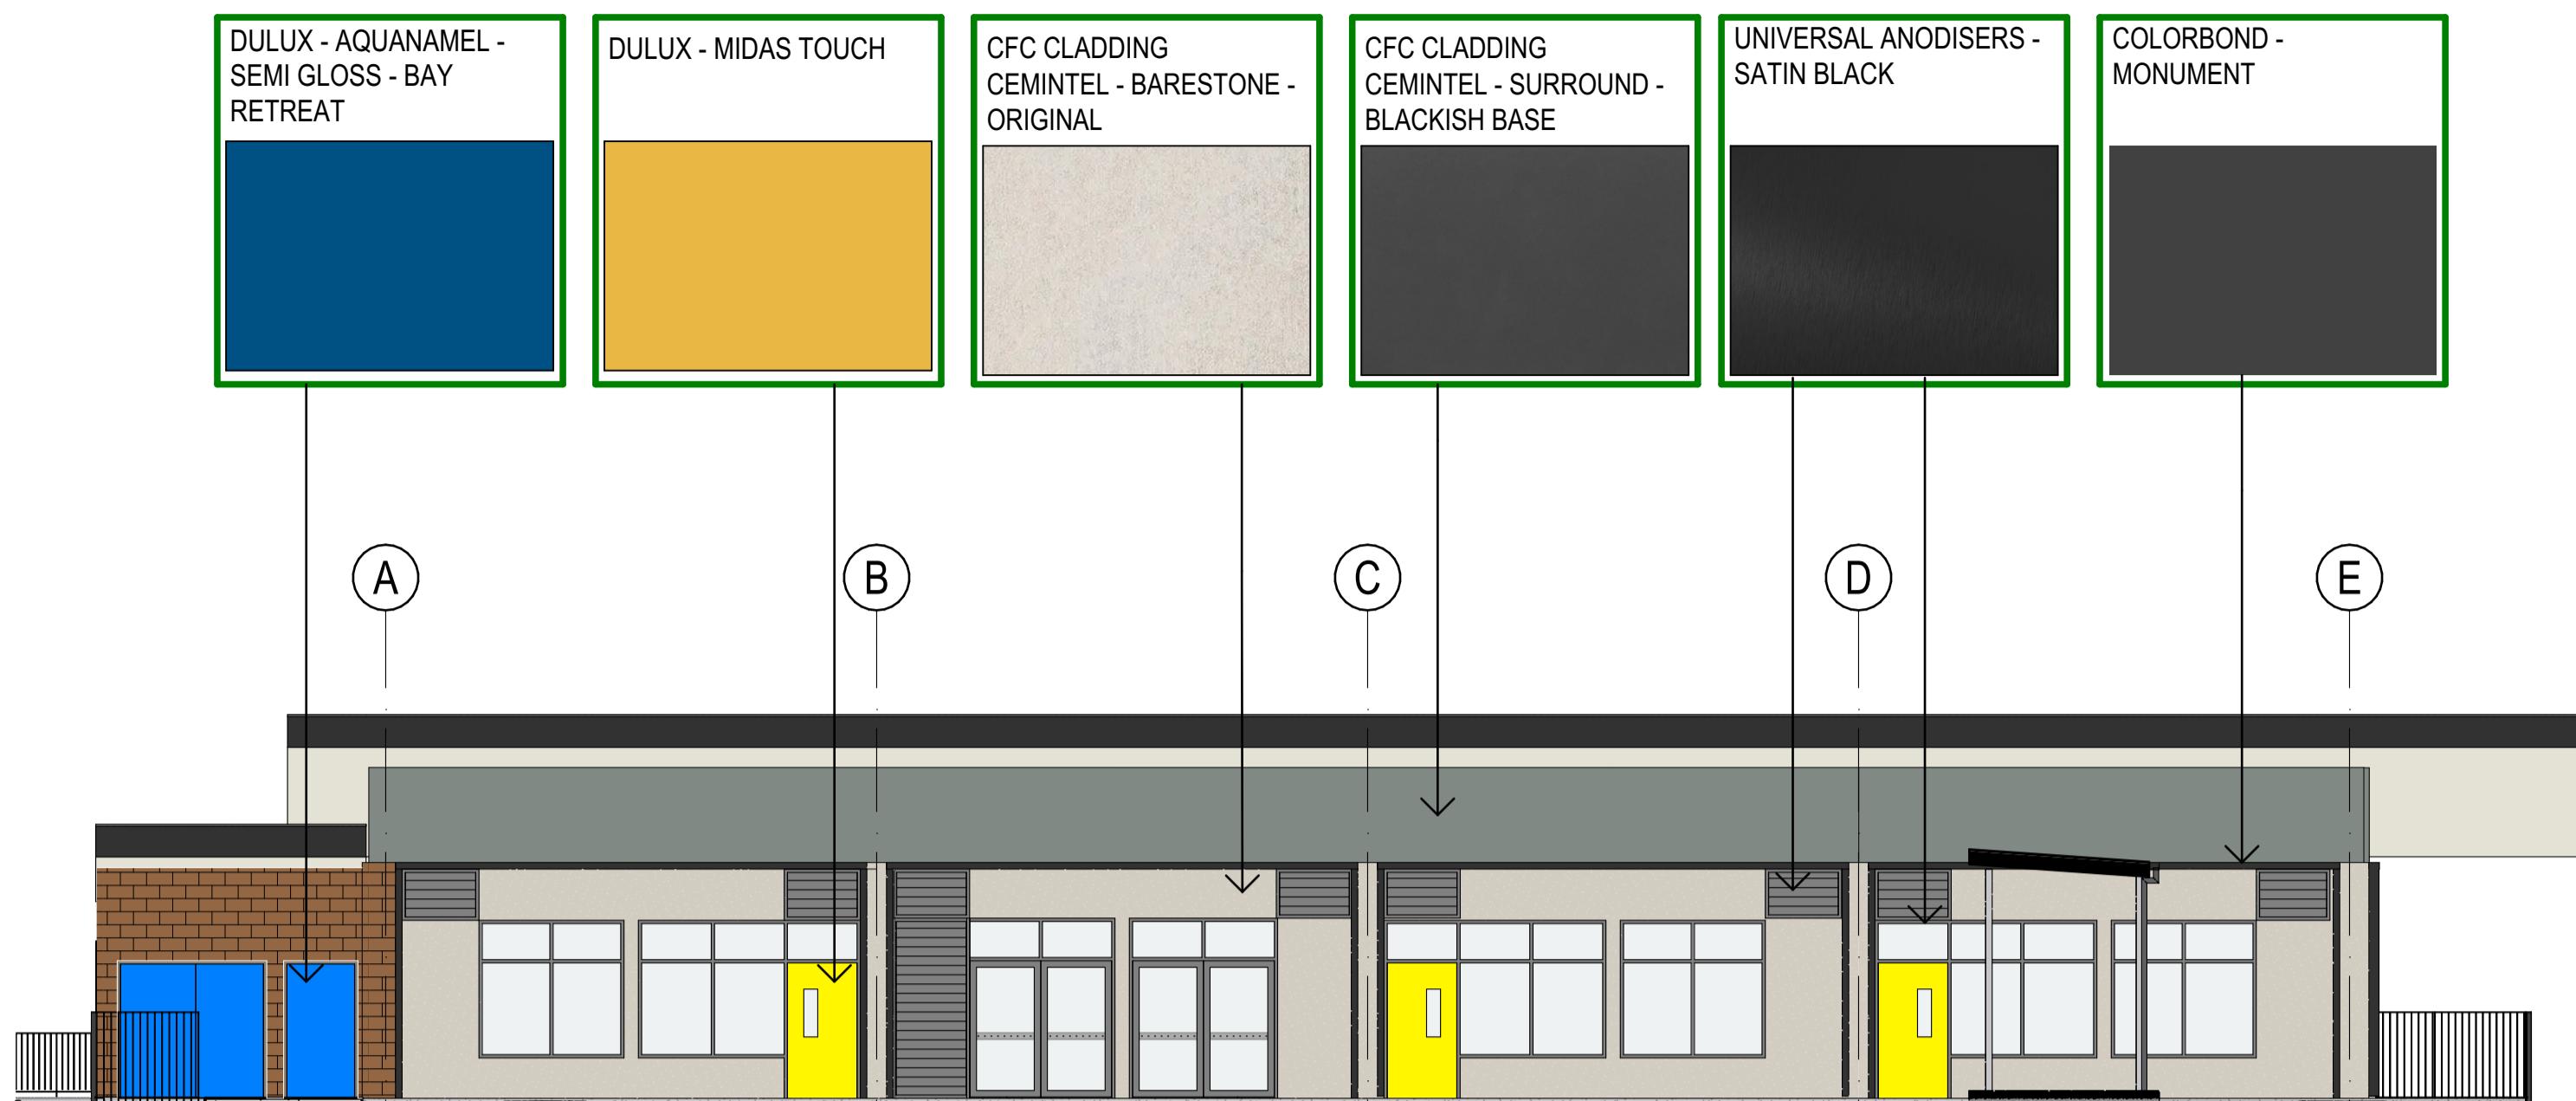

**ALL COLOURS AND MATERIALS  
ARE TO BE CONFIRMED PRIOR  
TO TENDER**

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John Ward raia VIC 18804 NSW 8371 QLD 3847

Katerina Dracopoulos fraia NSW 7434 QLD 4529  
Paul Sekava fraia NSW 7180 QLD 3108

Ryan Loveday fraia QLD 4500

# **SCHEMATIC DESIGN**

---

## SCHOOL INFRASTRUCTURE NOW

PROJECT | NORTHMEAD PUBLIC SCHOOL

---


## **EXTERNAL MATERIAL AND TECHNOLOGY**

Figured dimensions take precedence over scale dimensions. Contractors must verify all dimensions on site before commencing any work or making shop drawings.

any work or making shop drawings.


**7068ND01** | **JW** | **NK**

**DRAWING NUMBER** **NBS-ETA-00-00-DB-A-1630** **REVISION** **03**

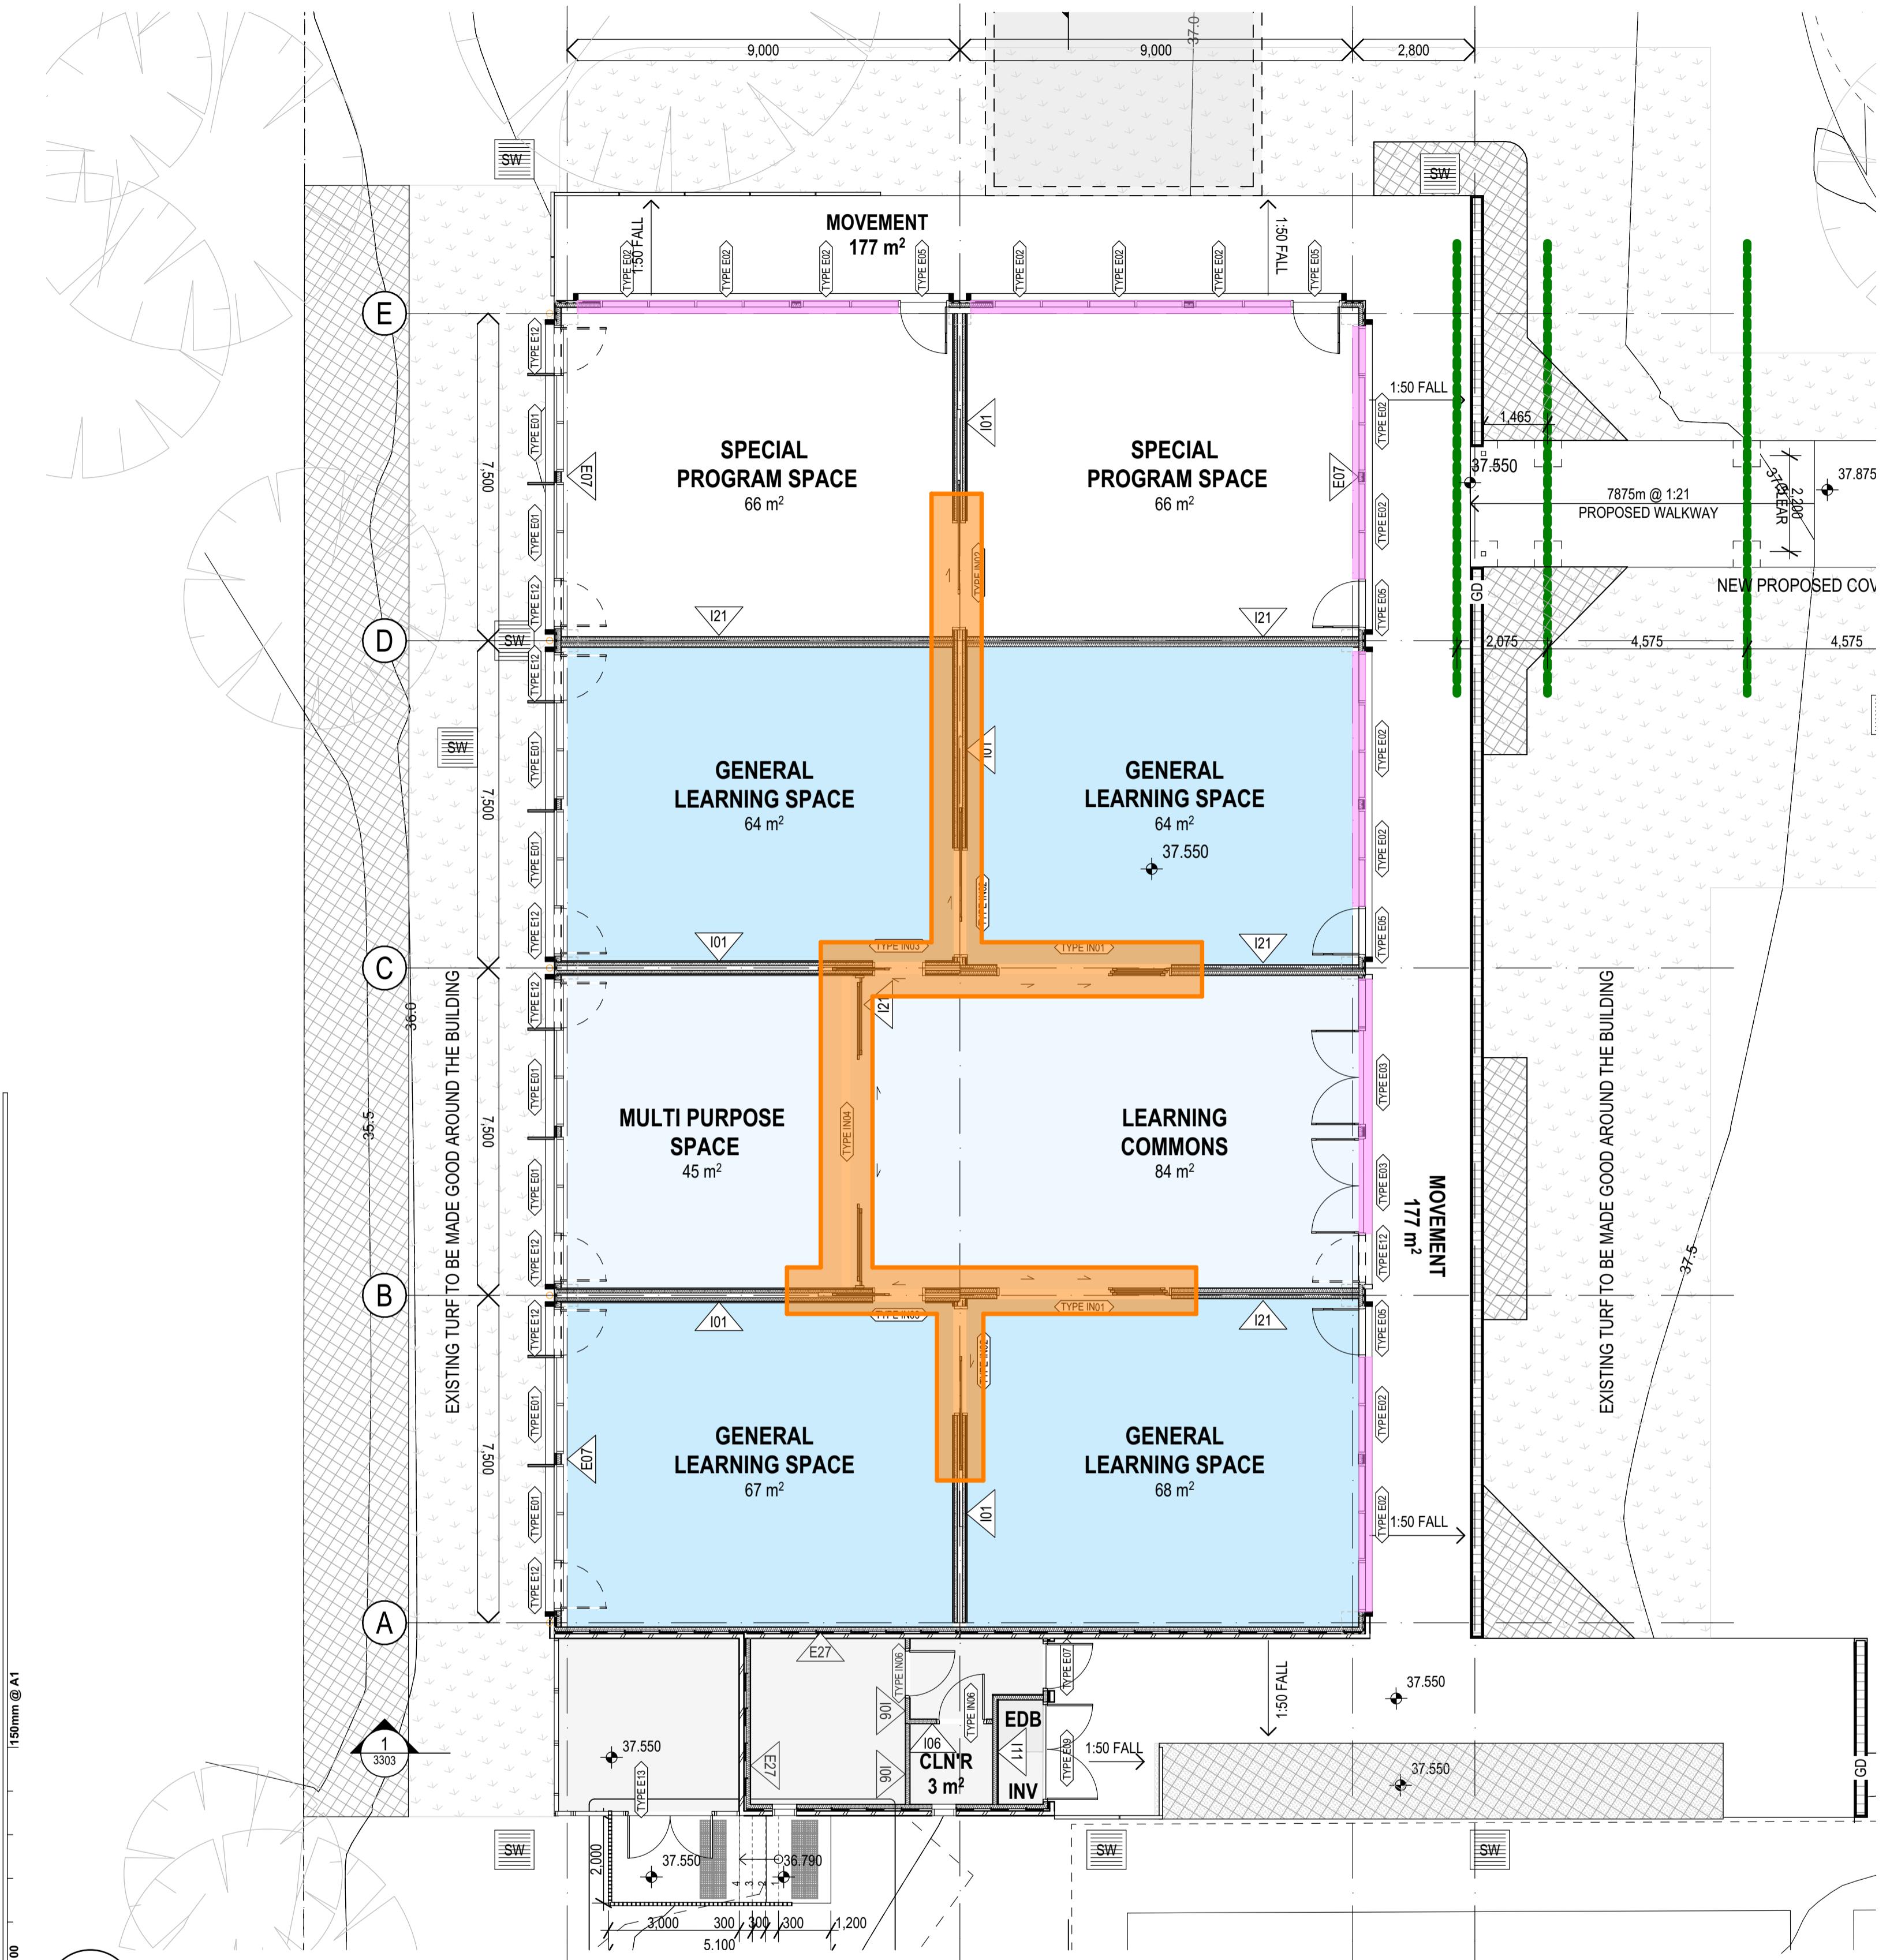

# 1 PLAN INDIGENOUS ARTWORK STRATEGY

plot date: Thursday, 19 December 2024 2:46 PM file location: BIMcloud: FTA-SYD-BIM26 - BIMcloud Basic for Archicad 26/7068ND01 Northmead Public School

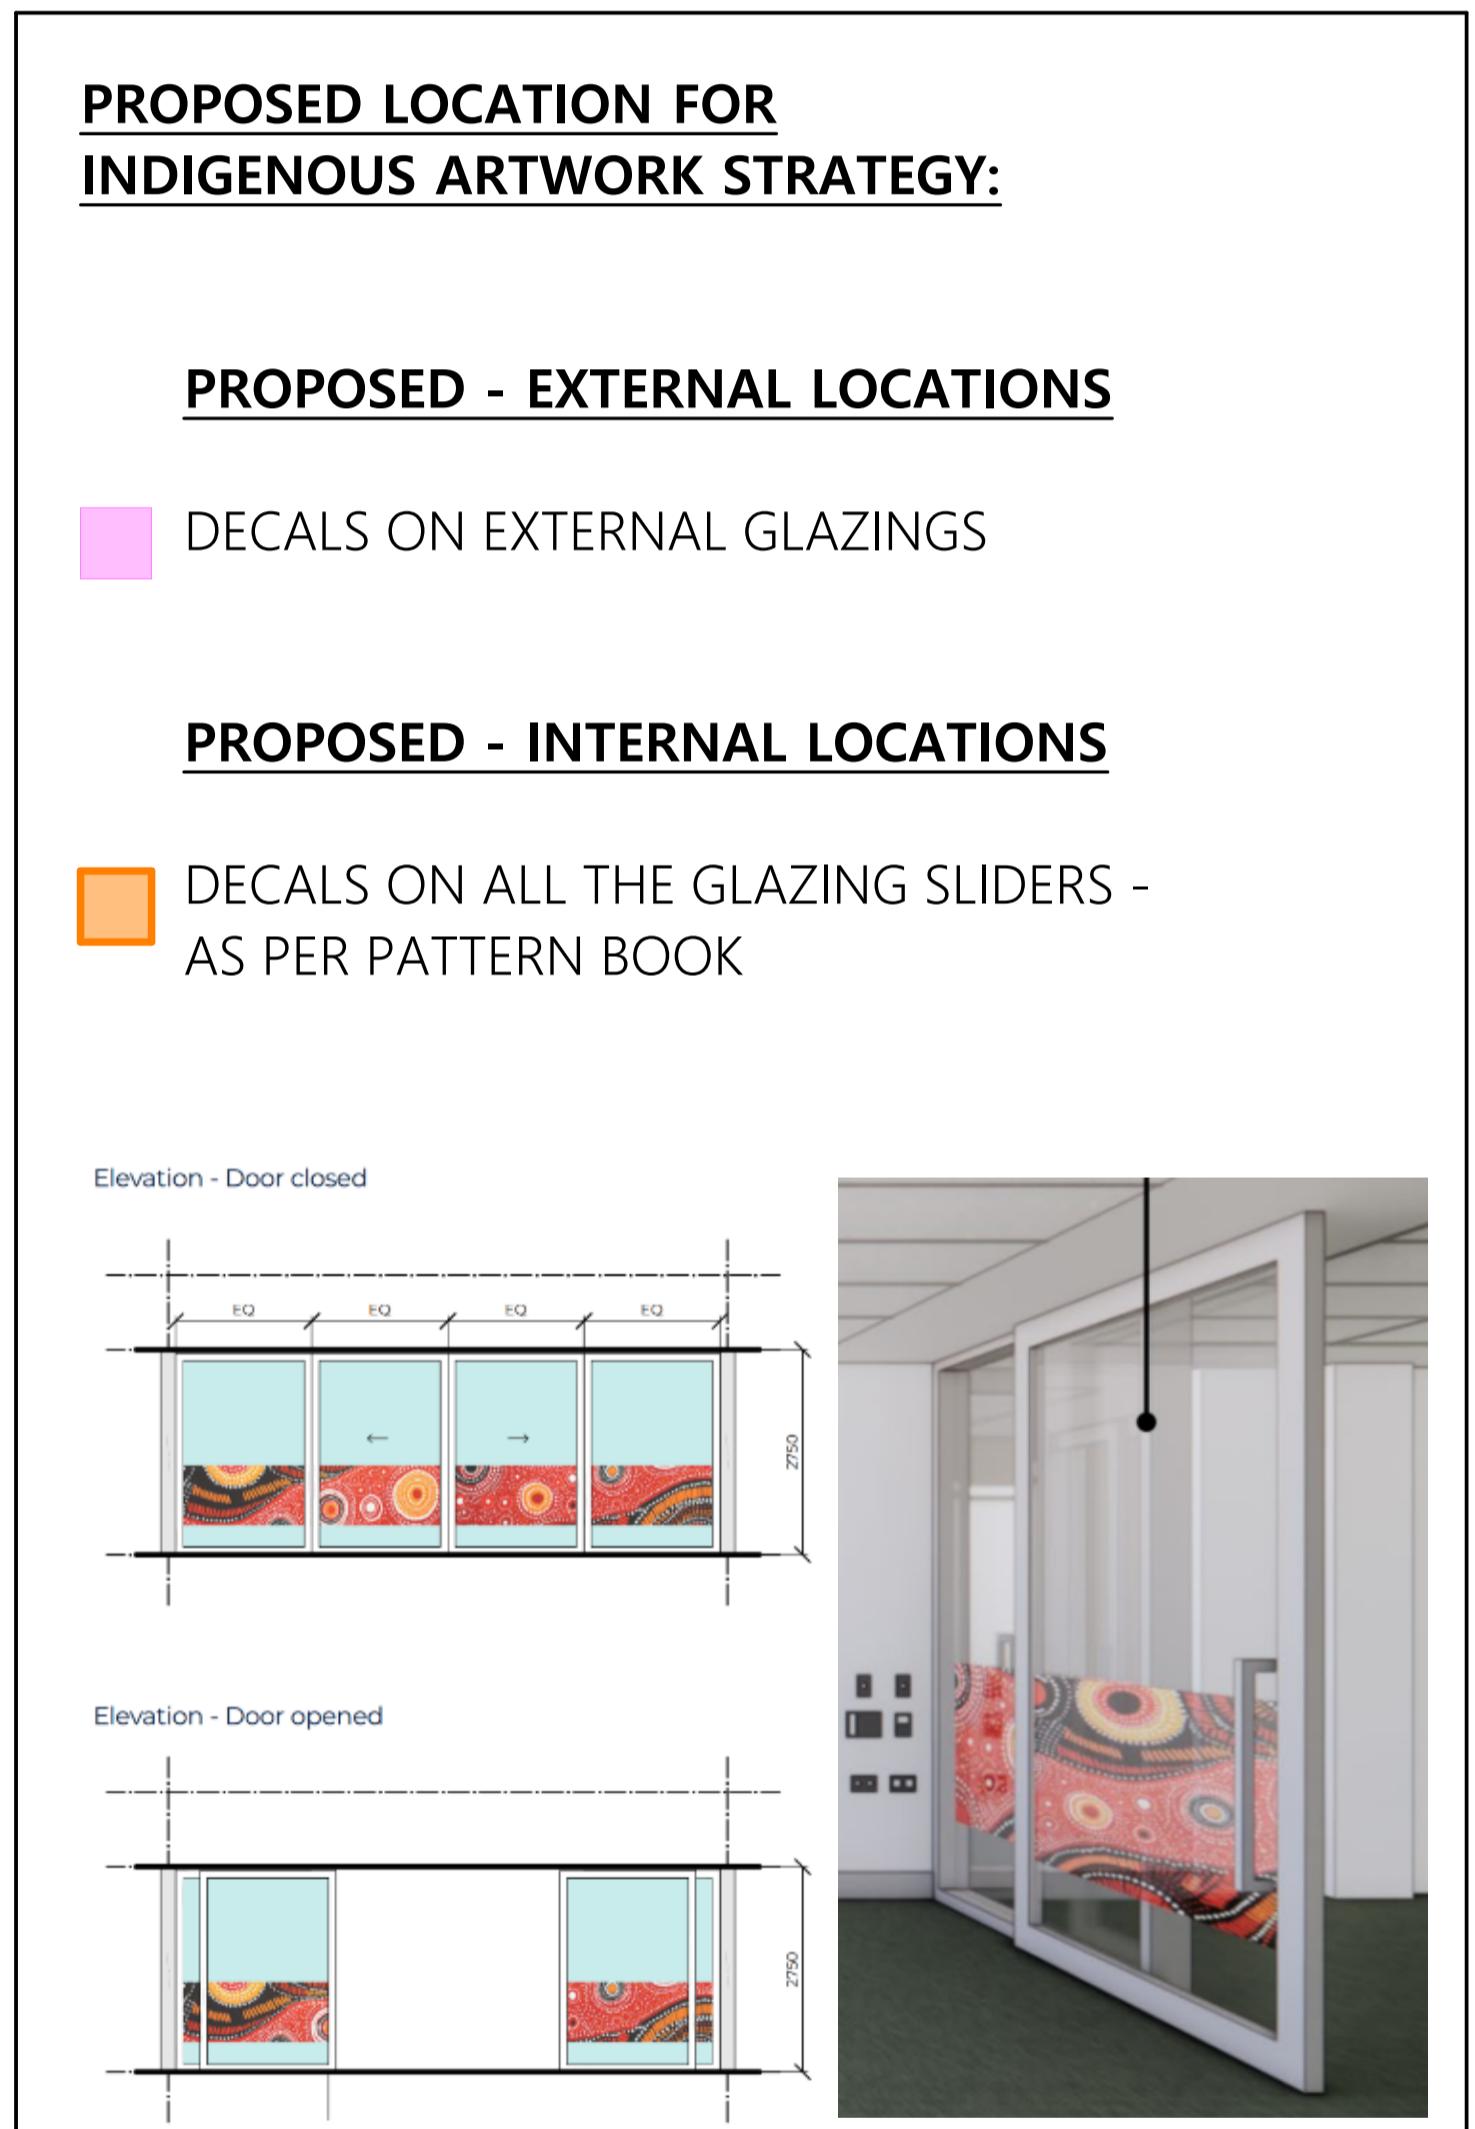

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**Fulton Trotter Architects ACN 677 264 550 ABN 57 677 264 550**

# **SCHEMATIC DESIGN**

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## SCHOOL INFRASTRUCTURE

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ADDRESS | PROJECT  
**NORTHMEAD PUBLIC SCHOOL**

---

**MOXHAMS ROAD,  
NORTHMEAD, NSW**

# INDIGENOUS ARTWORK STRATEGY

---

J  
JECT NUMBER  
068ND01  
DIRECTOR  
JW  
WING NUMBER  
RS-ETA-00-00-DB-A-1610





# **PLAN**

## **TREE REMOVAL PLAN**

SCALE: 1:500

SCALE: 1:500

REV	DESCRIPTION	DATE	INIT
02	100% SCHEMATIC DESIGN	19/12/2024	AK
01	95% SCHEMATIC DESIGN	10/12/2024	AK

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Justino Ebzery fraia QLD 3313

Justine Ebzery fraia VIC 18804 NSW 8371 QLD 3313  
John Ward raiia VIC 18804 NSW 7434 QLD 3847  
Katerina Dracopoulos fraia VIC 18804 NSW 7434 QLD 4529

Paul Sekava fraia NSW 7180 QLD 3108  
Ryan Loveday fraia QLD 4500

PHASE I  
**SCHEMATIC DESIGN**  
SCHOOL INFRASTRUCTURE  
NSW

PROJECT | ADDRESS  
**NORTHMEAD PUBLIC SCHOOL**

---

**MOXHAMS ROAD,  
NORTHMEAD. NSW**

# **TREE REMOVAL PLAN**


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**PROJECT NUMBER** 7068ND01 **DIRECTOR** **JW**

**DRAWING NUMBER**

**NBS E7A 00 00 DB A 1601**

**1 PLAN**  
ACCESS STRATEGY PLAN  
SCALE: 1:500

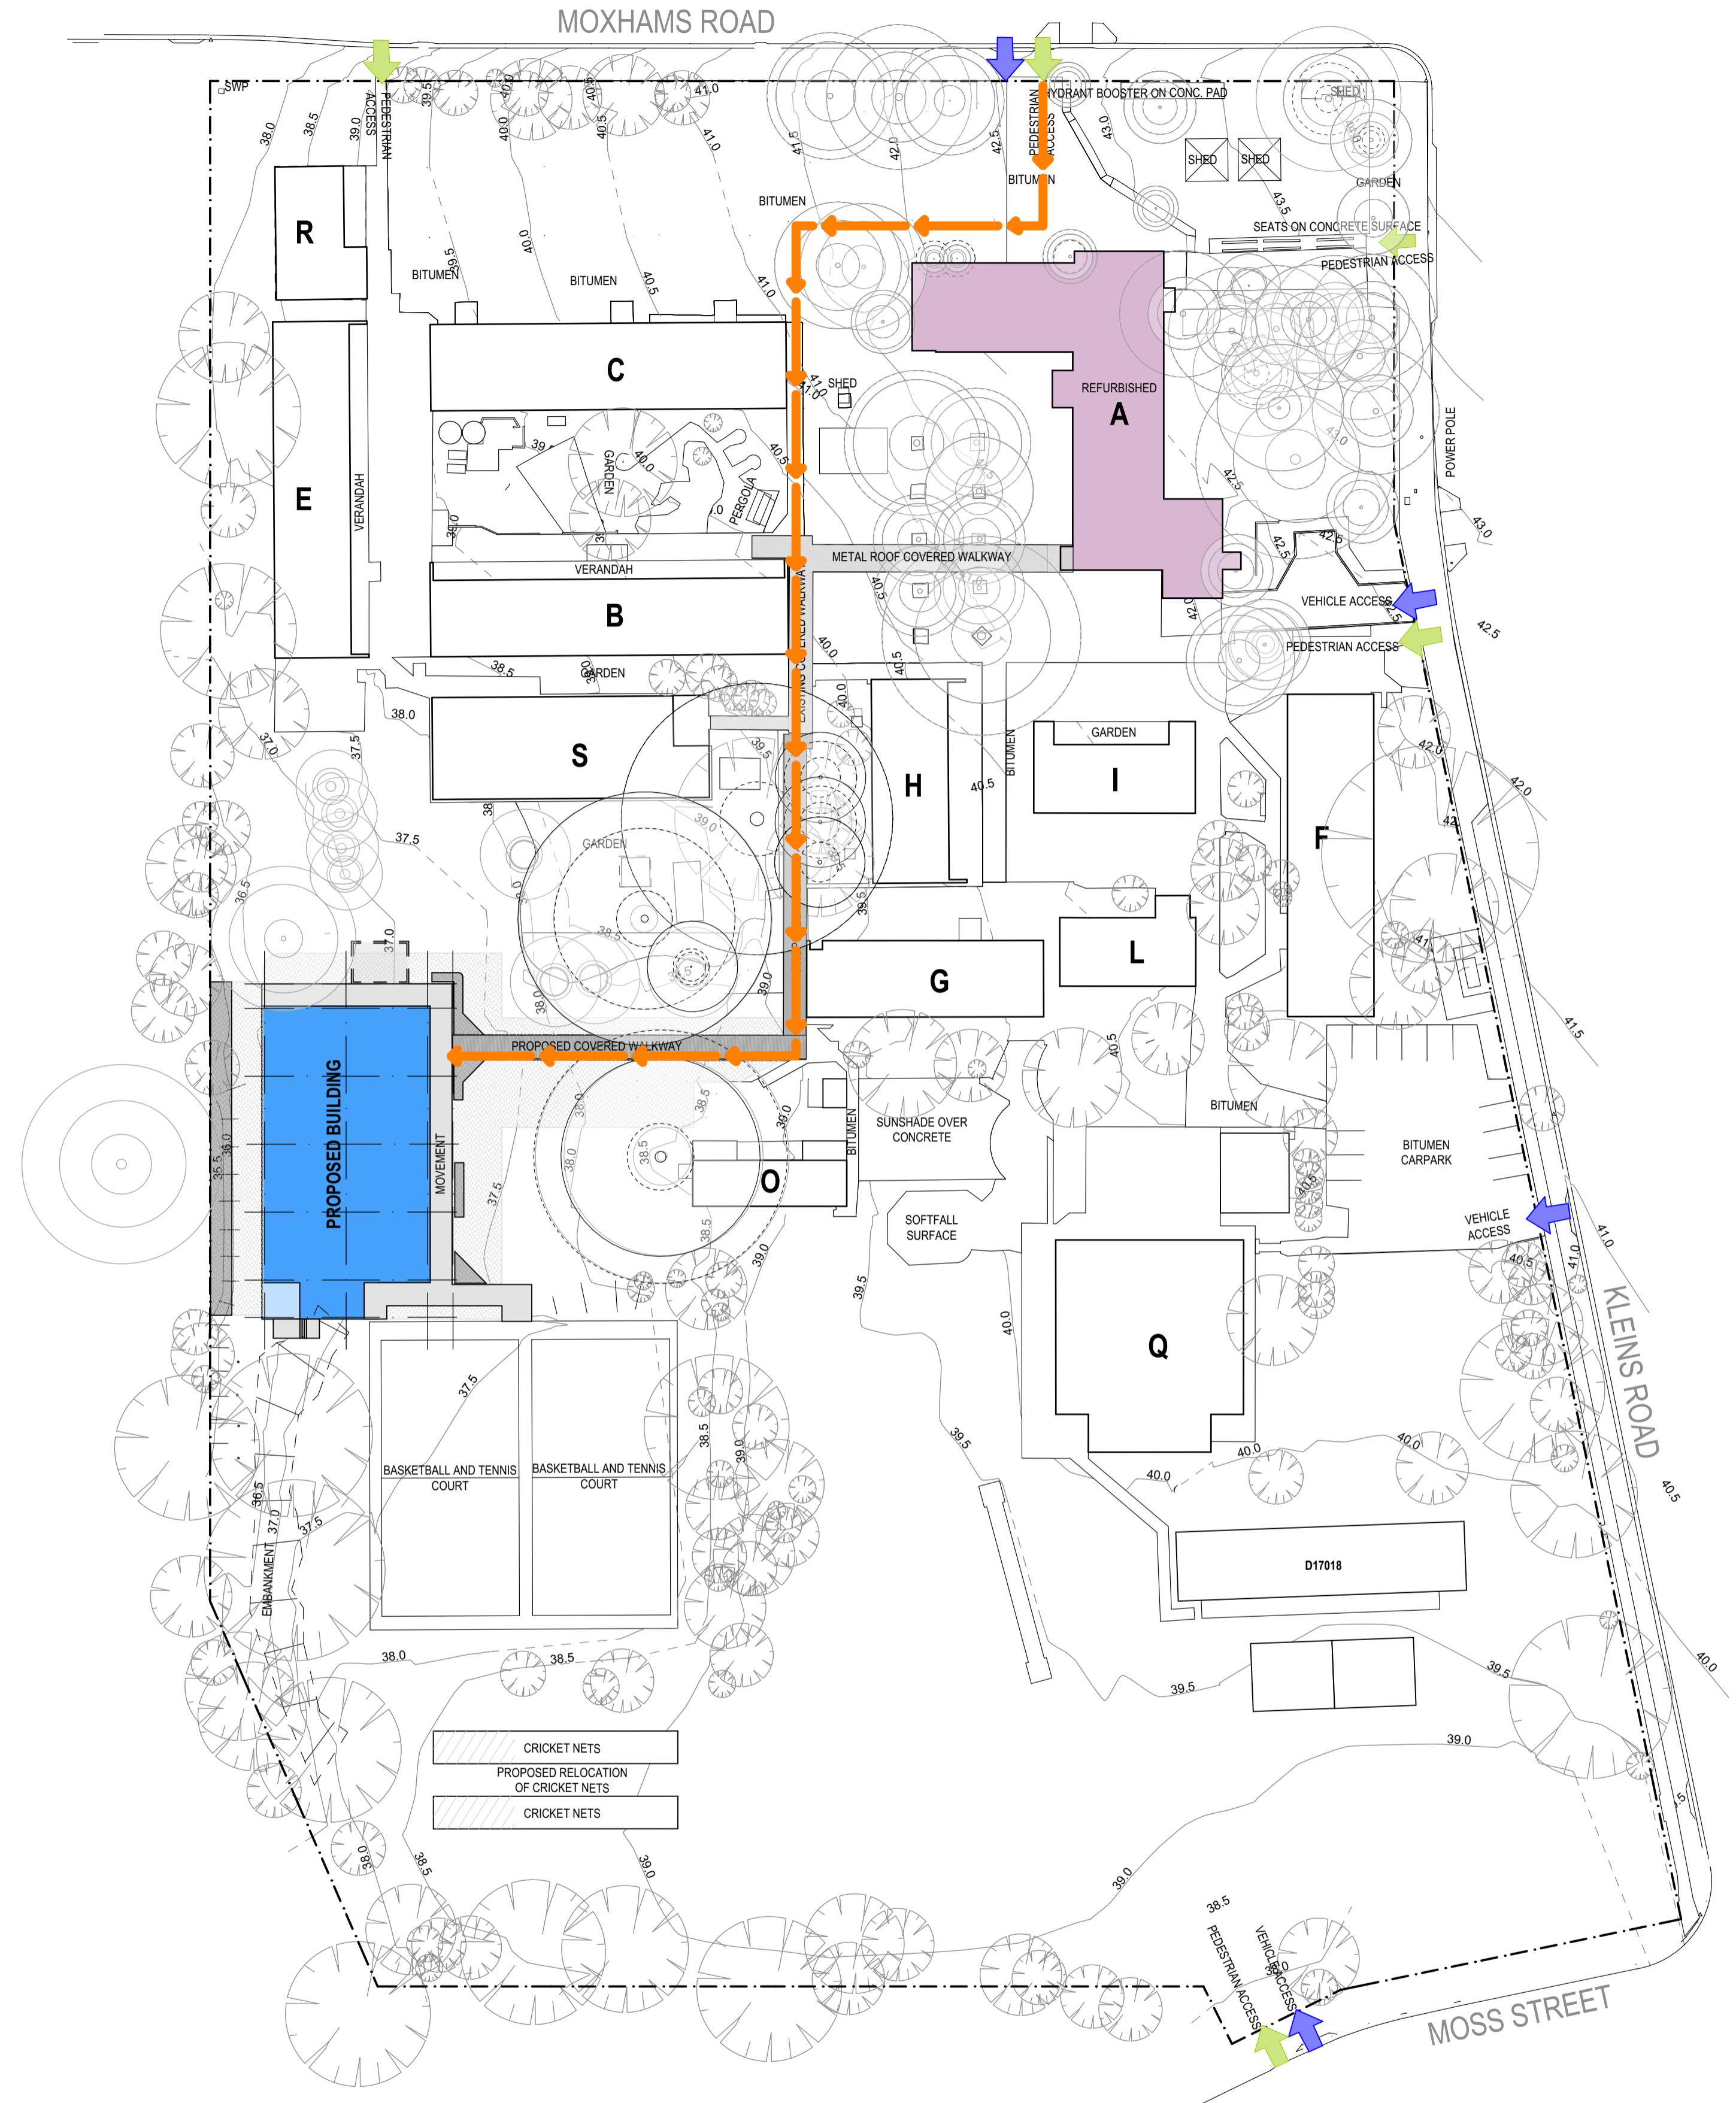

150mm @ A1

50

100

150mm @ A1

01	100% SCHEMATIC DESIGN	19/12/2024	NK
REV.	DESCRIPTION	DATE	INIT.

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NSW 7434 QLD 3847  
NSW 7780 QLD 4529  
VIC 18804 QLD 4508  
QLD 4500


PHASE  
**SCHEMATIC DESIGN**  
SCHOOL INFRASTRUCTURE  
NSW

PROJECT NUMBER: **7068ND01** DIRECTOR: **JW**  
DRAWING NUMBER: **NPS-FTA-00-00-DR-A-1603**  
REVISION: **01**

ADDED: PROJECT: CLIENT: PHASE:

Figured dimensions take precedence over scale dimensions. Contractors must verify all dimensions on site before commencing any work or making shop drawings.

PROJECT NUMBER: **7068ND01** DIRECTOR: **JW**  
DRAWING NUMBER: **NPS-FTA-00-00-DR-A-1603**  
REVISION: **01**

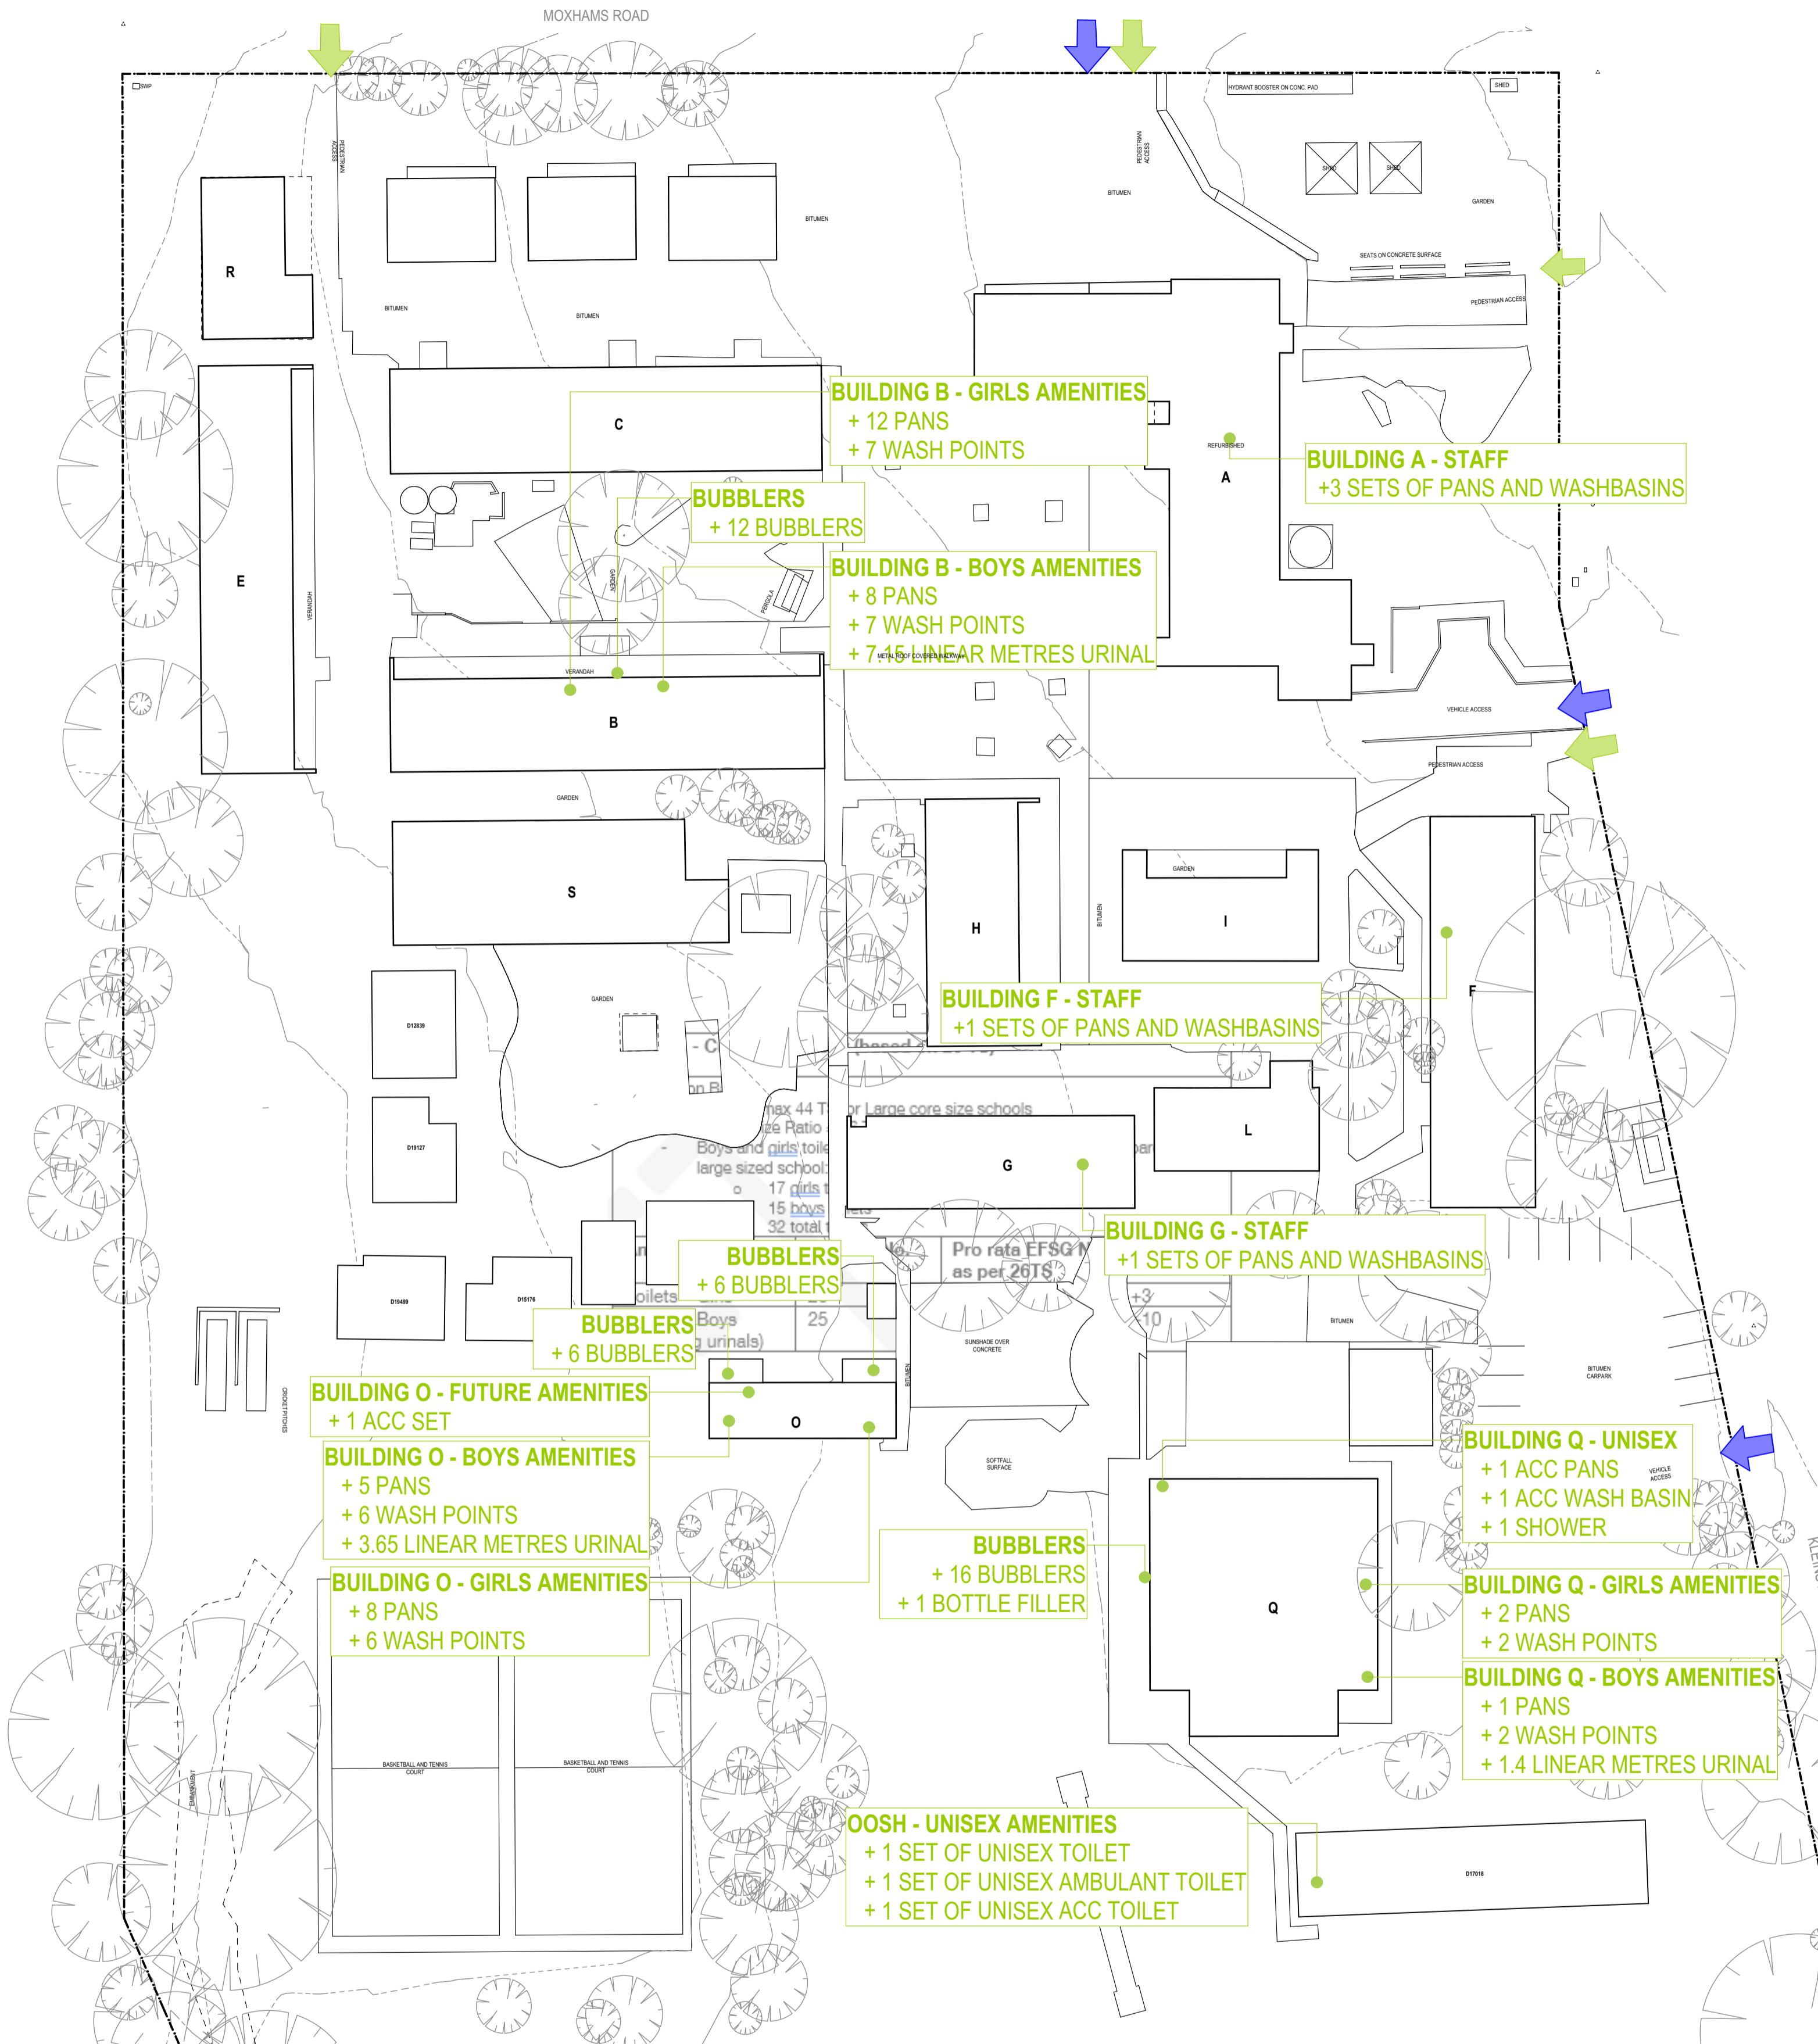

1 PLAN  
EXISTING SITE AMENITIES  
SCALE: 1:400

#### EXISTING AMENITIES

AMENITIES	EXISTING No.	POST DEMOLITION No.	EFSG No.	GAP
TOILETS - GIRLS	20	20	17	+3
TOILETS - BOYS (INCLUDING URINALS)	25	25	15	+5
TOILETS - ACC	1	1	6	-5
TOILETS - STAFF	5	5	-	-
BUBBLER	41	41	29	+12

Table 2 - Current Capacity (based on 26 TS)

Calculation Basis:			
- 26 TS of max 44 TS for Large core size schools			
- School Size Ratio = 26 TS / 44 TS = 0.590			
- Boys and girls toilets calculated based on pro rata basis compared to full large sized school:			
o 17 girls toilets			
o 15 boys toilets			
o 32 total toilets			
Amenities	Existing No.	Pro rata EFSG No. as per 26TS	Gap
Toilets - Girls	20	17	+3
Toilets - Boys (including urinals)	25	15	+10

02	100% SCHEMATIC DESIGN	19/12/2024	AK
01	95% SCHEMATIC DESIGN	10/12/2024	AK
REV.	DESCRIPTION	DATE	INIT.

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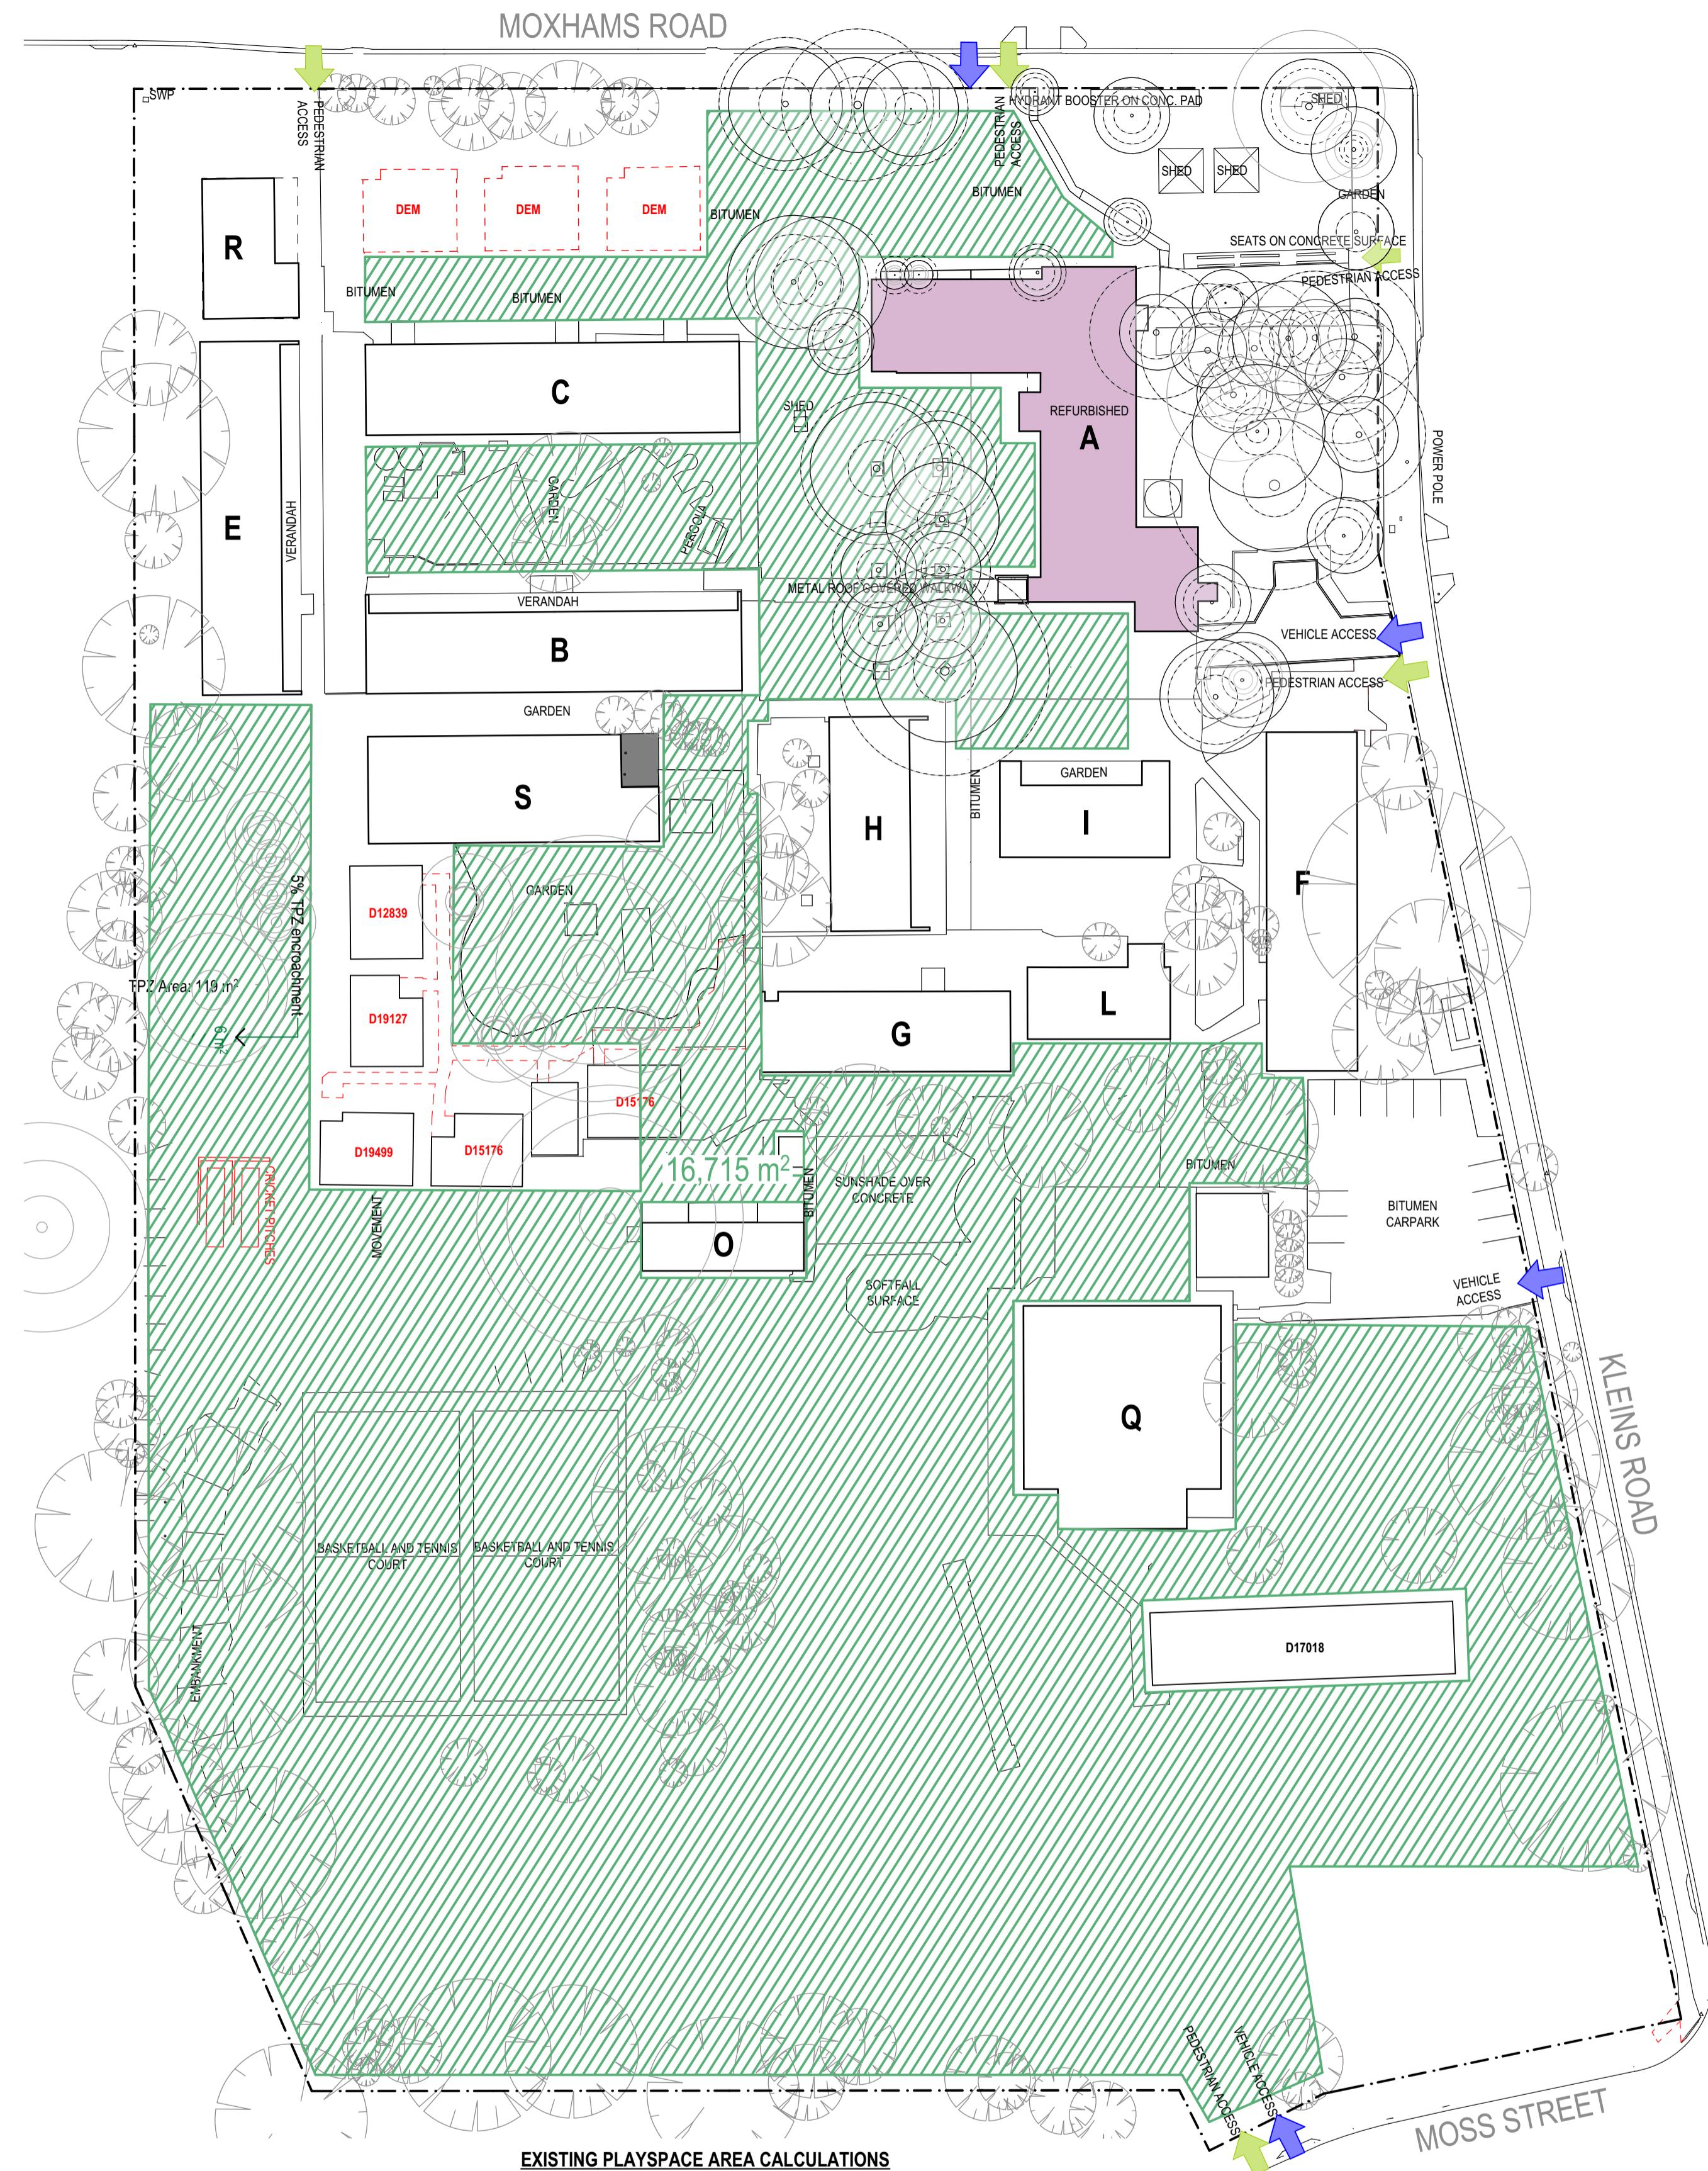
DIRECTORS Greg Hartnall John Ward Esben Fraaij John Ward Esben Fraaij Kieren D'Amato Fraaij Paul Sorensen Fraaij Ryan Lovelady Fraaij

NSW 6855 QLD 2950 QLD 5313 VIC 18804 NSW 8371 QLD 3847 NSW 7434 QLD 4529 NSW 7789 QLD 4508 NSW 7790 QLD 4500


PROJECT NUMBER: 7068ND01 DIRECTOR: JW  
DRAWING NUMBER: NPS-FTA-00-00-DR-A-1602  
REVISION: 02  
PHASE: PROJECT CLIENT: NORTHMEAD PUBLIC SCHOOL  
ADDRESS: MOXHAMS ROAD, NORTHMEAD, NSW

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PROJECT NUMBER: 7068ND01 DIRECTOR: JW  
DRAWING NUMBER: NPS-FTA-00-00-DR-A-1602  
REVISION: 02  
CHECKED: NK



**2 PLAN EXISTING PLAY SPACE**  
SCALE: 1:500

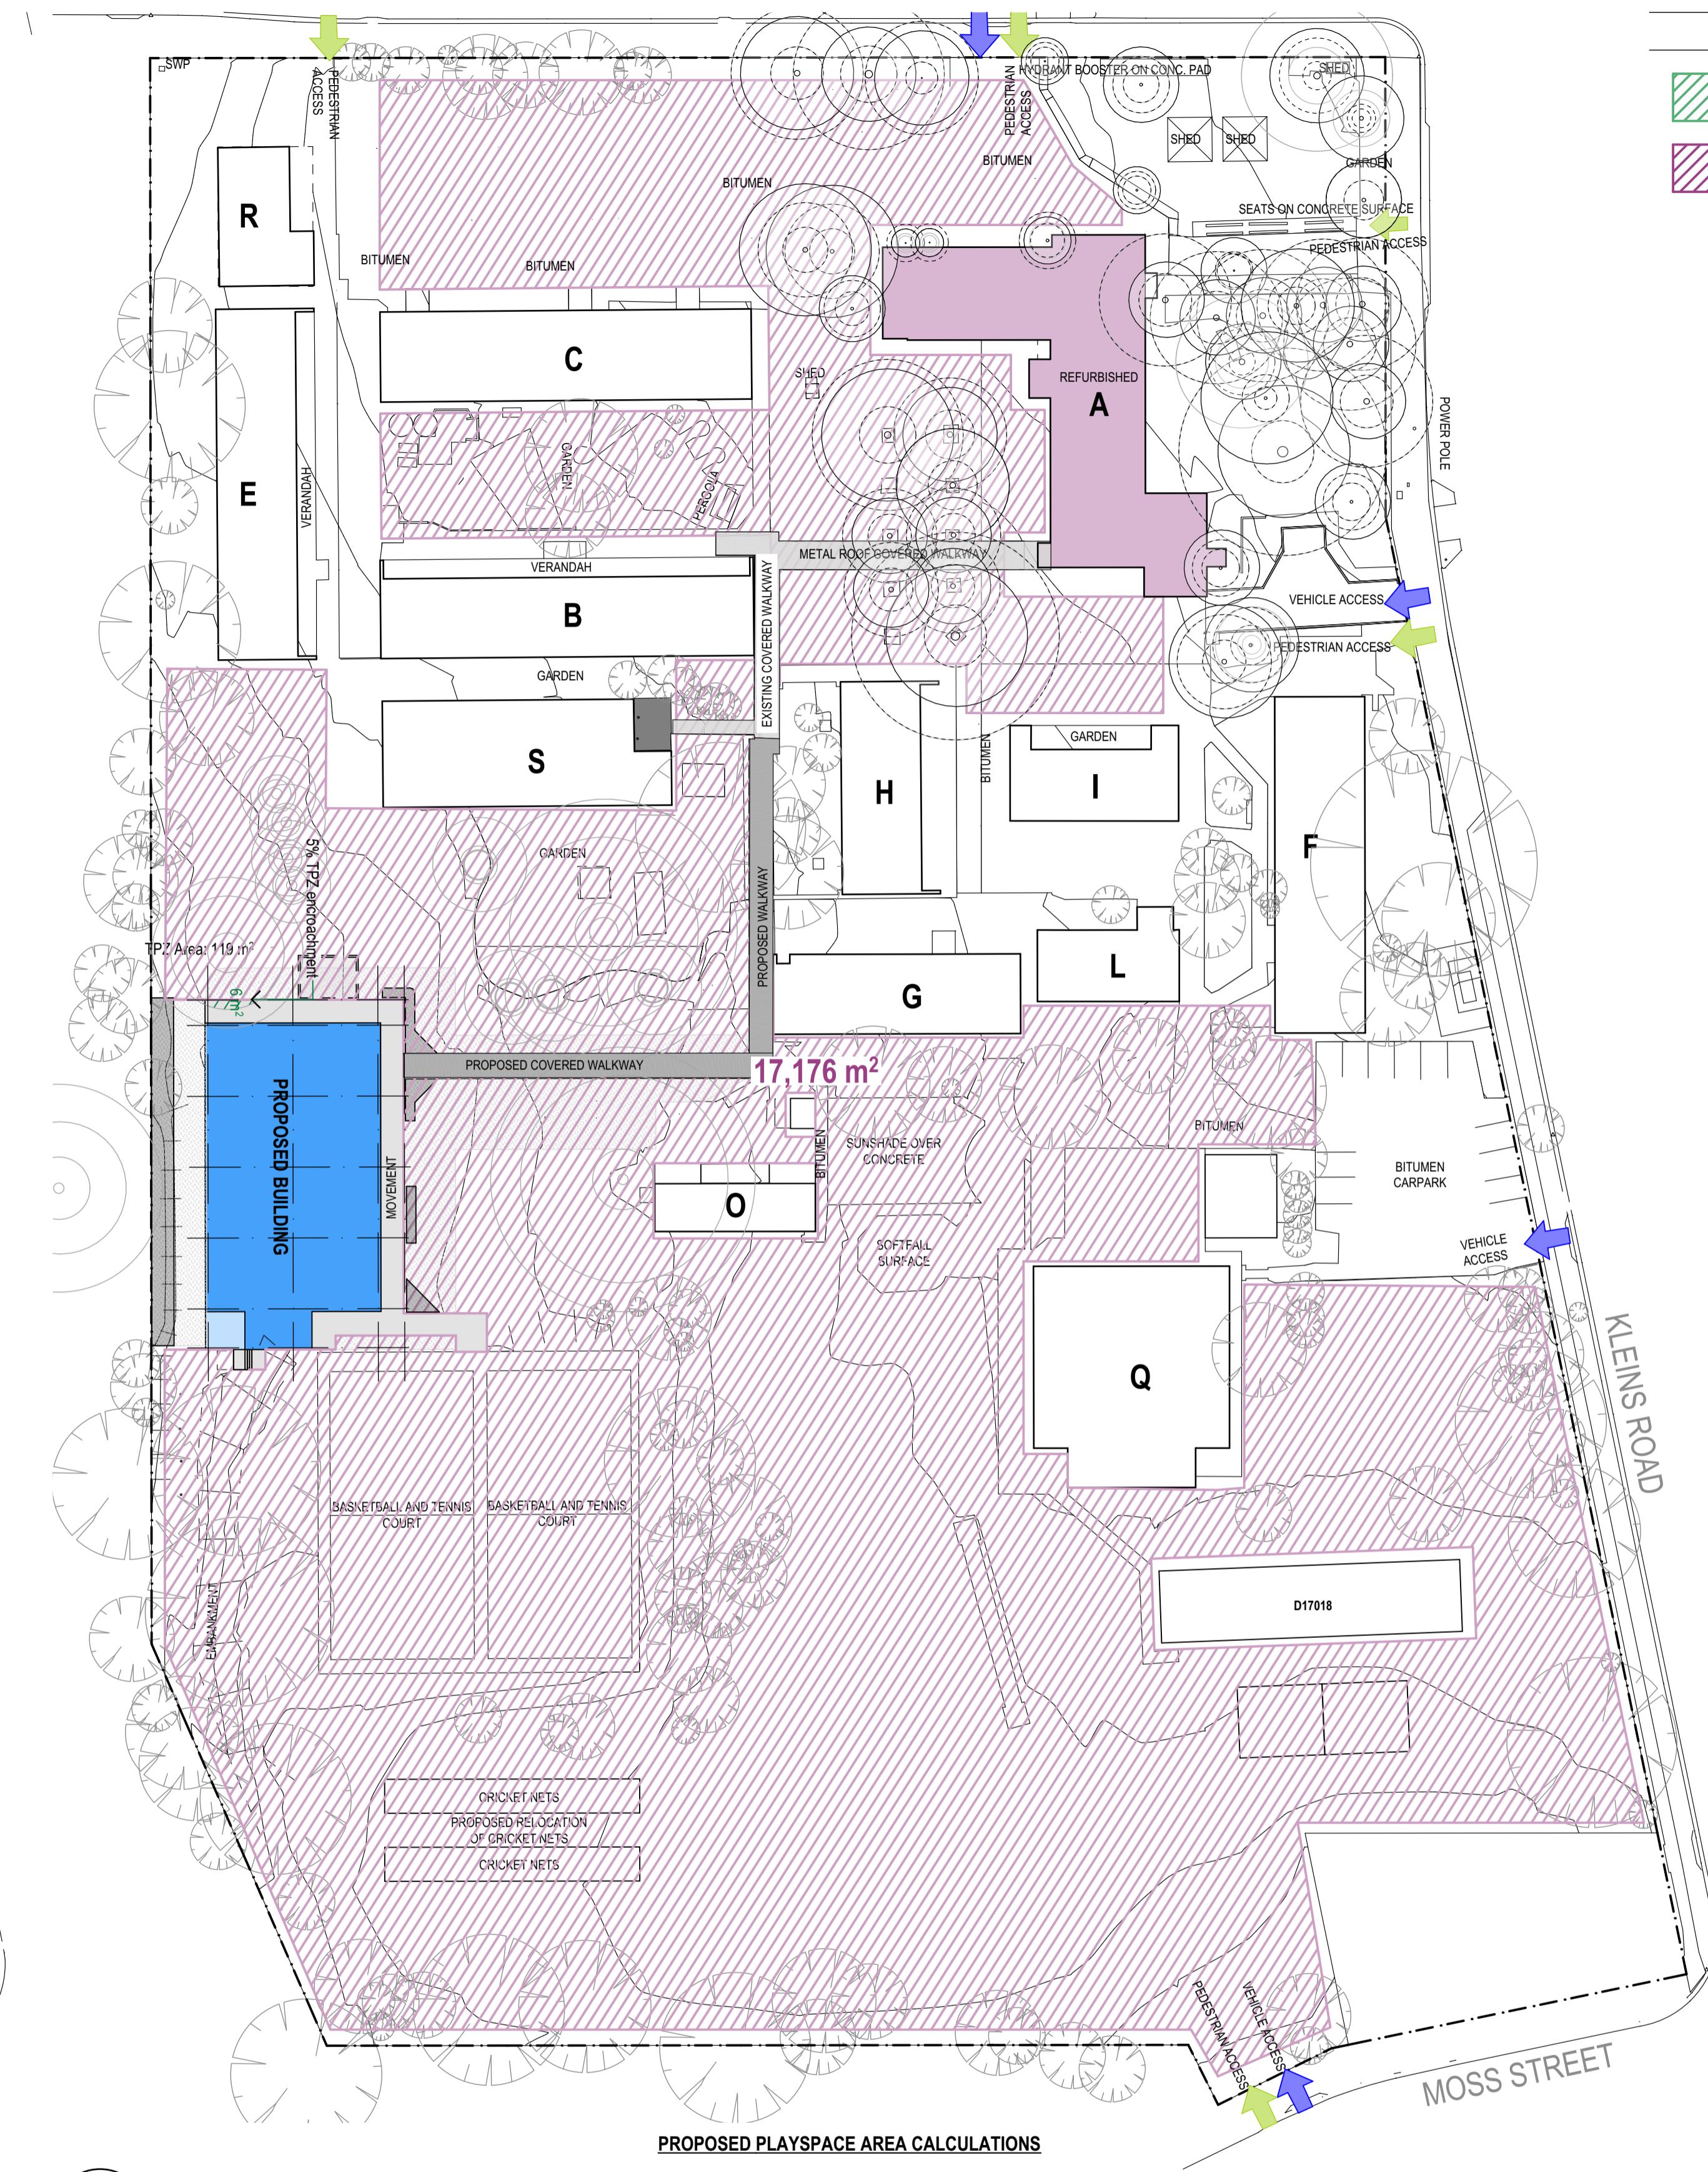

**2 PLAN PROPOSED PLAY SPACE**  
SCALE: 1:500

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QLD 4500

**PROJECT NUMBER** 7068ND01 **DIRECTOR** JW  
**DRAWING NUMBER** NPS-FTA-00-00-DR-A-1601 **REVISION** 02

**SCHEMATIC DESIGN**  
SCHOOL INFRASTRUCTURE  
NSW

**NORTHMEAD PUBLIC SCHOOL**

**ADDRESS** MOXHAMS ROAD,  
NORTHMEAD, NSW

**PLAYSPACE CALCULATION**

Figured dimensions take precedence over scale dimensions. Contractors must verify all dimensions on site before commencing any work or making shop drawings.



# 1 PLAN

## STAGE 2 - REFURB WORKS AND AFTER COMPLETION

SCALE: 1:500

SCALE: 1:500

REV.	DESCRIPTION	DATE	INIT.
03	100% SCHEMATIC DESIGN	19/12/2024	AK
02	95% SCHEMATIC DESIGN	10/12/2024	AK
01	80% SCHEMATIC DESIGN	26/11/2024	AK
P2	100% CONCEPT DESIGN	31/10/2024	NK
P1	80% CONCEPT DESIGN	18/10/2024	AK

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John Ward rai  
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QLD 3313  
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John Ward fraia VIC 18804 NSW 8571 QLD 5847  
Katerina Dracopoulos fraia NSW 7434 QLD 4529  
Paul Sekava fraia NSW 7180 QLD 3108

Ryan Loveday fraia QLD 4500

**PHASE**

---

# **SCHEMATIC DESIGN**

---

## SCHOOL INFRASTRUCTURE

---

### NOW

PROJEC  
NORTHMEAD PUBLIC SCHOOL

---

ADDRESS  
MOXHAMS ROAD,  
NORTHMEAD, NSW

<b>PROPOSED STAGING PLAN 03</b>			
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PROJECT NUMBER <b>7068ND01</b>	DIRECTOR <b>JW</b>	N 	CHECKED <b>NK</b>
RAWING NUMBER <b>NPS-FTA-00-00-DB-A-1503</b>			REVISION <b>03</b>

**1 PLAN**  
STAGE 1- MAIN WORKS  
SCALE: 1:500



150mm @ A1

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MOXHAMS ROAD

#### STAGING PLAN LEGEND

<span style="background-color: #4f81bd; border: 1px solid black; padding: 2px 5px;"></span>	NEW BUILD
<span style="border: 1px dashed blue; padding: 2px 5px;"></span>	CONSTRUCTION ZONE
<span style="background-color: #ff6347; border: 1px solid black; padding: 2px 5px;"></span>	WORKS TO BE UNDERTAKEN BY AMU TO BE REMOVED/RELOCATED
<span style="background-color: #ffcc00; border: 1px solid black; padding: 2px 5px;"></span>	TEMPORARY RELOCATION
<span style="background-color: #2e7131; border: 1px solid black; padding: 2px 5px;"></span>	NEW DEMOUNTABLES
<span style="background-color: #ff00ff; border: 1px solid black; padding: 2px 5px;"></span>	PROJECT MAIN UPGRADE WORKS RELOCATION TO BLOCK A UPON REFURBISHMENT
<span style="background-color: #800080; border: 1px solid black; padding: 2px 5px;"></span>	BLOCK-A REFURBISHMENT / BLOCK-R DESIGN SCOPE PART 1 - STAFF & PRINCIPAL ROOM
<span style="background-color: #d8b4fe; border: 1px solid black; padding: 2px 5px;"></span>	BLOCK-A REFURBISHMENT / BLOCK-R DESIGN SCOPE PART 2 - TECH HUB & OFFICES

#### STAGE 1- MAIN WORKS INCLUDING:

- CONSTRUCT THE NEW BUILDING
- PART OF REFURB WORK

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NSW 8371 QLD 3313

NSW 7434 QLD 3847

NSW 7780 QLD 4529

NSW 7788 QLD 4518

Ryan Lovelady r/a QLD 4500

VIC 18804

NSW 8371 QLD 3847

NSW 7434 QLD 4529

NSW 7780 QLD 4518

NSW 7788 QLD 4500

SCHEMATIC DESIGN  
SCHOOL INFRASTRUCTURE  
NSW

NORTHMEAD PUBLIC SCHOOL  
MOXHAMS ROAD,  
NORTHMEAD, NSW

PROJECT

CLIENT

PHASE

PROPOSED STAGING PLAN 02

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Project Number: 7068ND01 Director: JW


Drawing Number: NPS-FTA-00-00-DR-A-1502 Revision: 03

150mm @ A1

100

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**1 PLAN**  
PRIOR TO CONSTRUCTION STAGE  
SCALE: 1:500

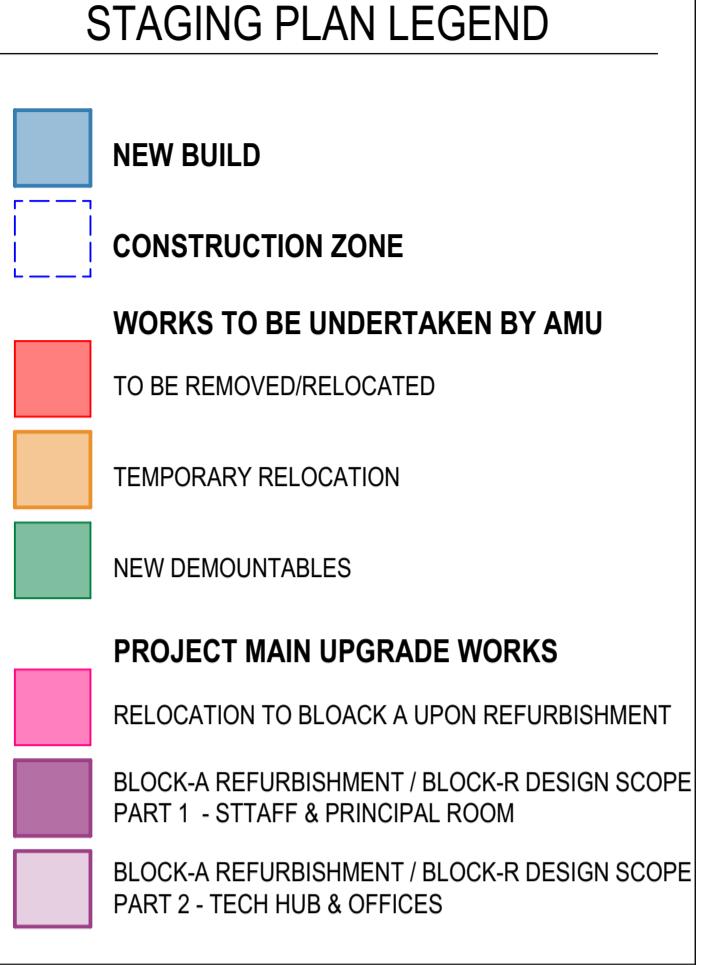


**PRIOR TO CONSTRUCTION WORKS INCLUDING:**

- EARLY WORKS BY OTHERS (AMU)
- DEMOUNTABLES / SITE ESTABLISHMENT

REV.	DESCRIPTION	DATE	INIT.
03	100% SCHEMATIC DESIGN	19/12/2024	AK
02	95% SCHEMATIC DESIGN	10/12/2024	AK
01	80% SCHEMATIC DESIGN	26/11/2024	AK
P3	100% CONCEPT DESIGN	31/11/2024	NK
P2	80% CONCEPT DESIGN	18/11/2024	AK
P1	FOR INFORMATION	11/11/2024	AK

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NSW 6855 VIC 18804 QLD 2950 QLD 5313 QLD 3847 NSW 7434 QLD 4529 QLD 4508 NSW 7780 QLD 4500	

PROJECT NUMBER	CLIENT	PHASE
7068ND01	JW	
DIRECTOR		
DRAWING NUMBER		
NPS-FTA-00-00-DR-A-1501		03

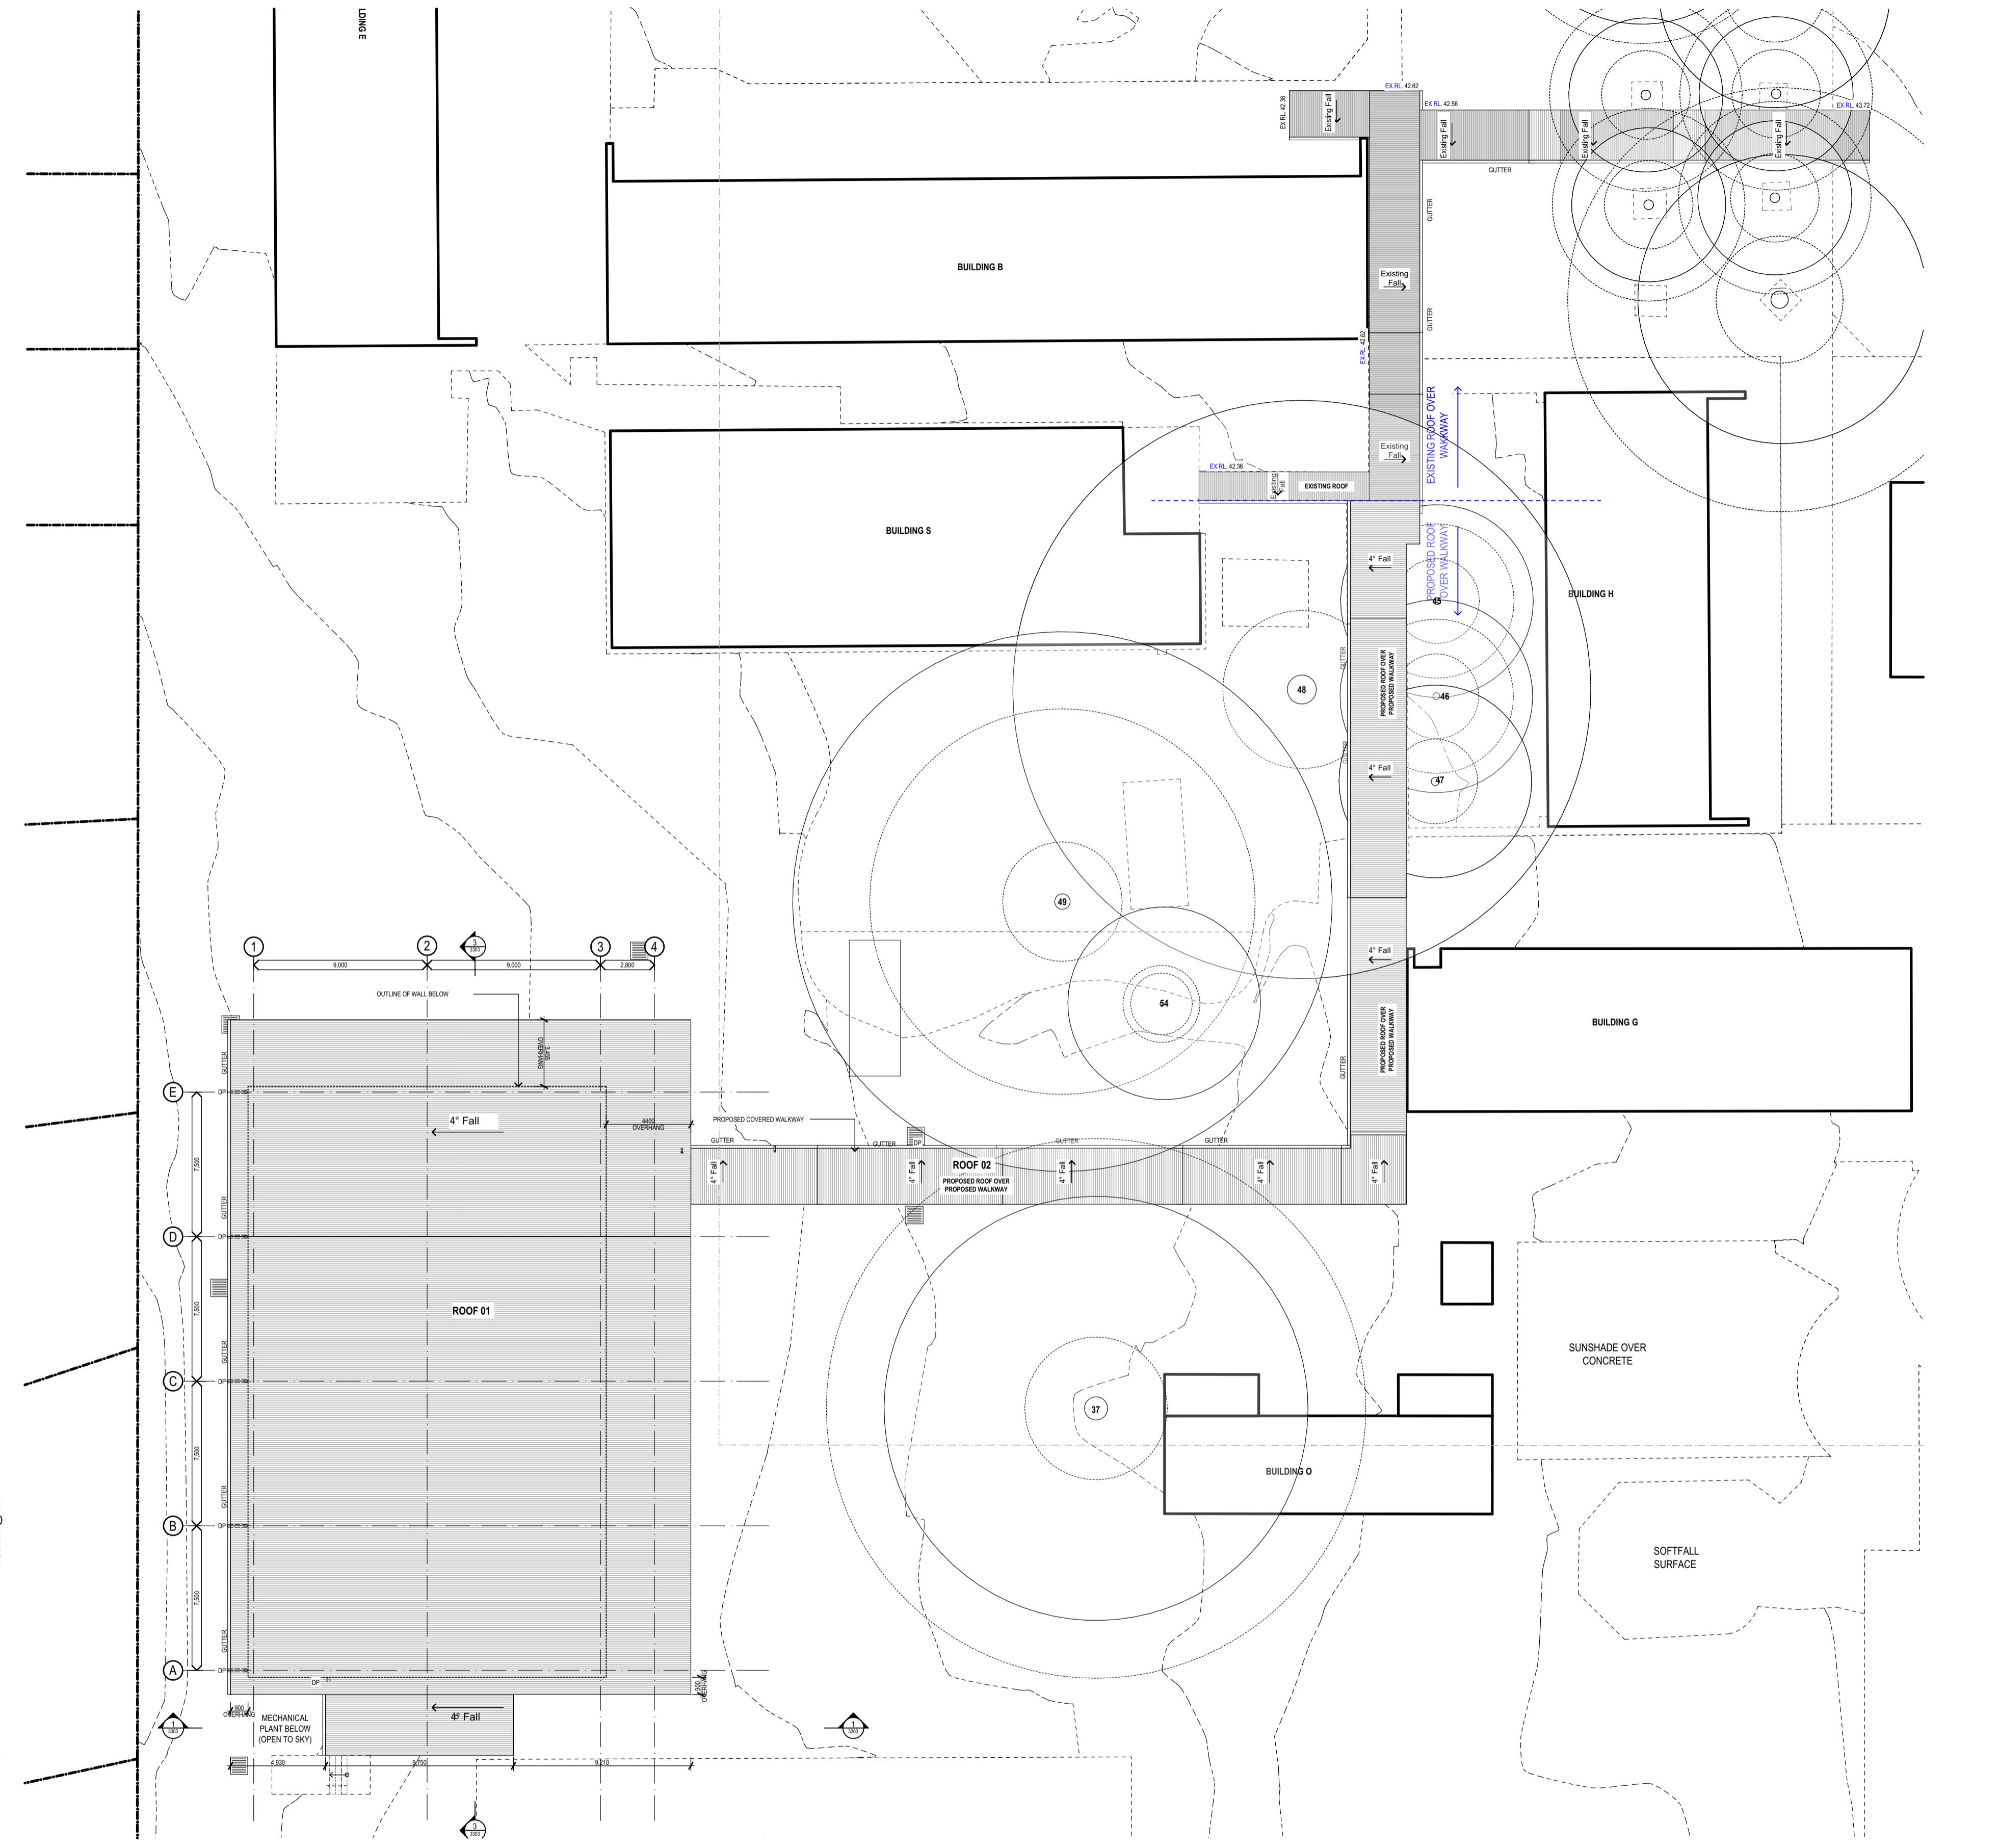

**1 PLAN  
COVERED WALKWAY ROOF PLAN  
SCALE: 1:200**

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Version History			
Rev.	Description	Date	Init.
02	100% SCHEMATIC DESIGN	19/12/2024	NK
01	FOR INFORMATION	13/12/2024	AK
REV.	DESCRIPTION	DATE	INIT.

**PHASE**

**SCHEMATIC DESIGN**

---

**SCHOOL INFRASTRUCTURE**

---

**NSW**

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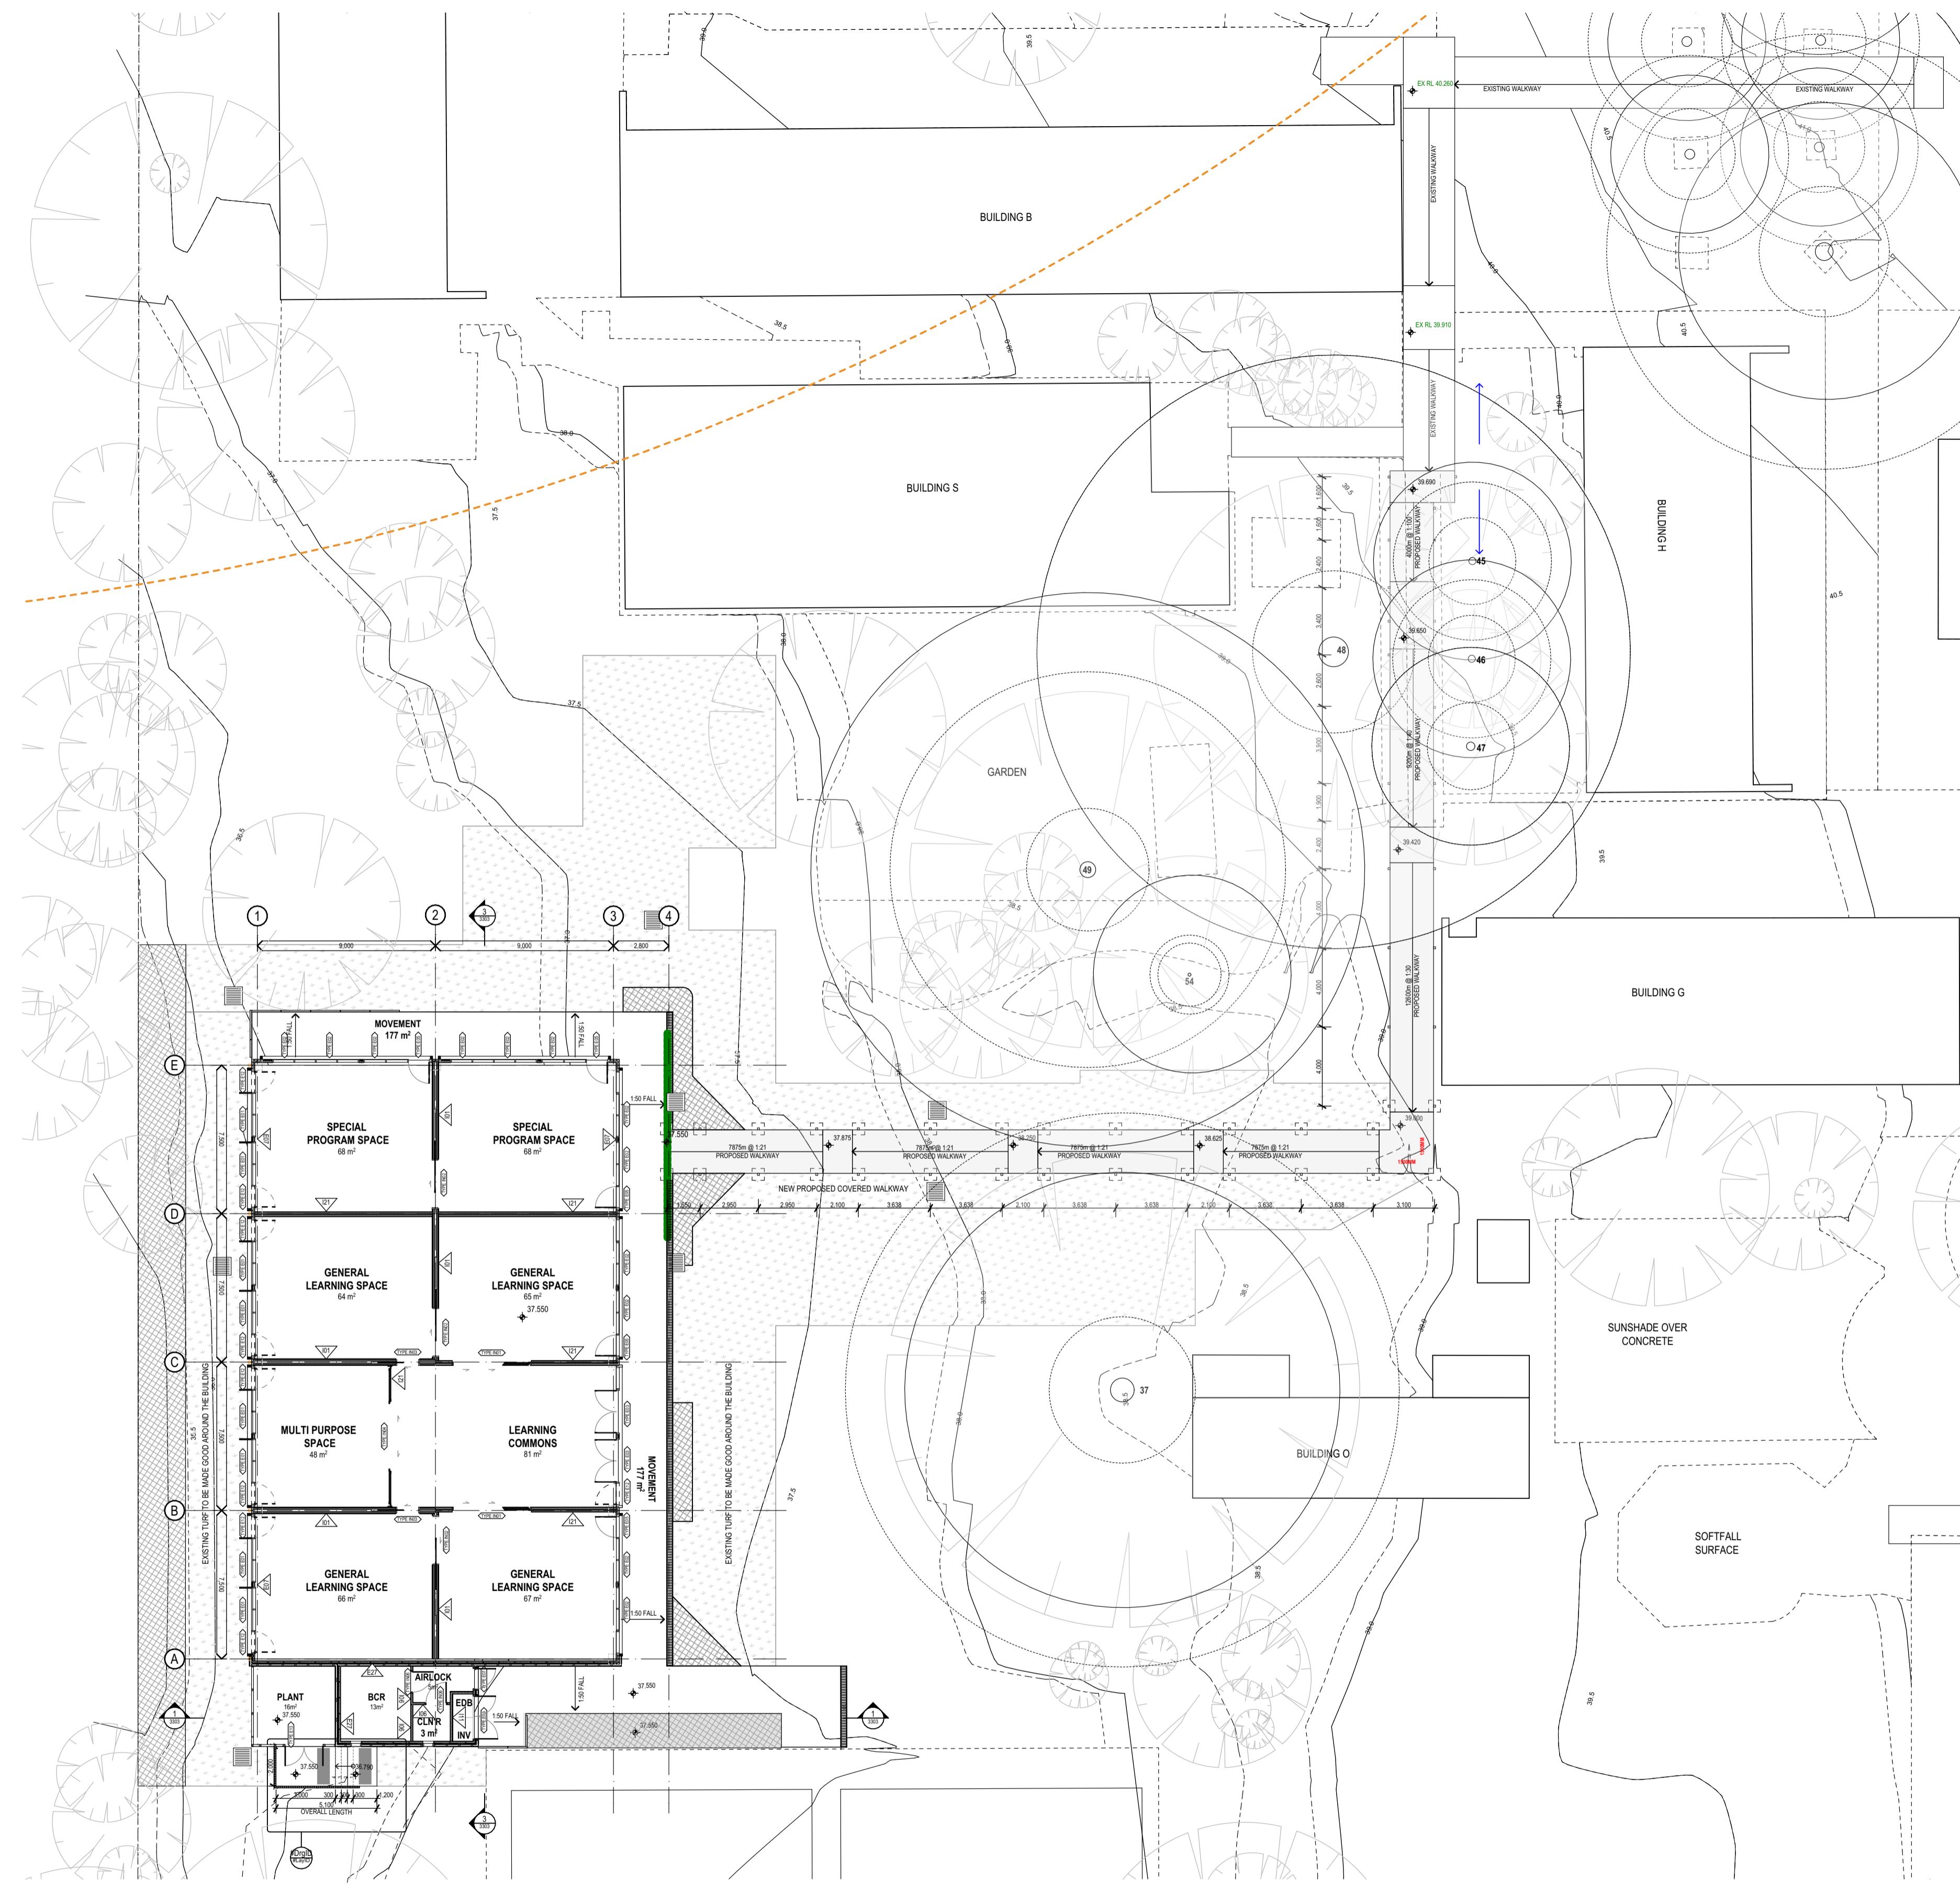
**NORTHMEAD PUBLIC SCHOOL**

---

## **PROPOSED COVERED WALKWAY - ROOF**

---

PROJECT NUMBER	DIRECTOR
<b>7068ND01</b>	<b>JW</b>
RANDOM NUMBER	
<b>NPS-ETA-00-00-DB-A-1403</b>	



**1 PLAN  
COVERED WALKWAY - GROUND PLAN**  
SCALE: 1:200

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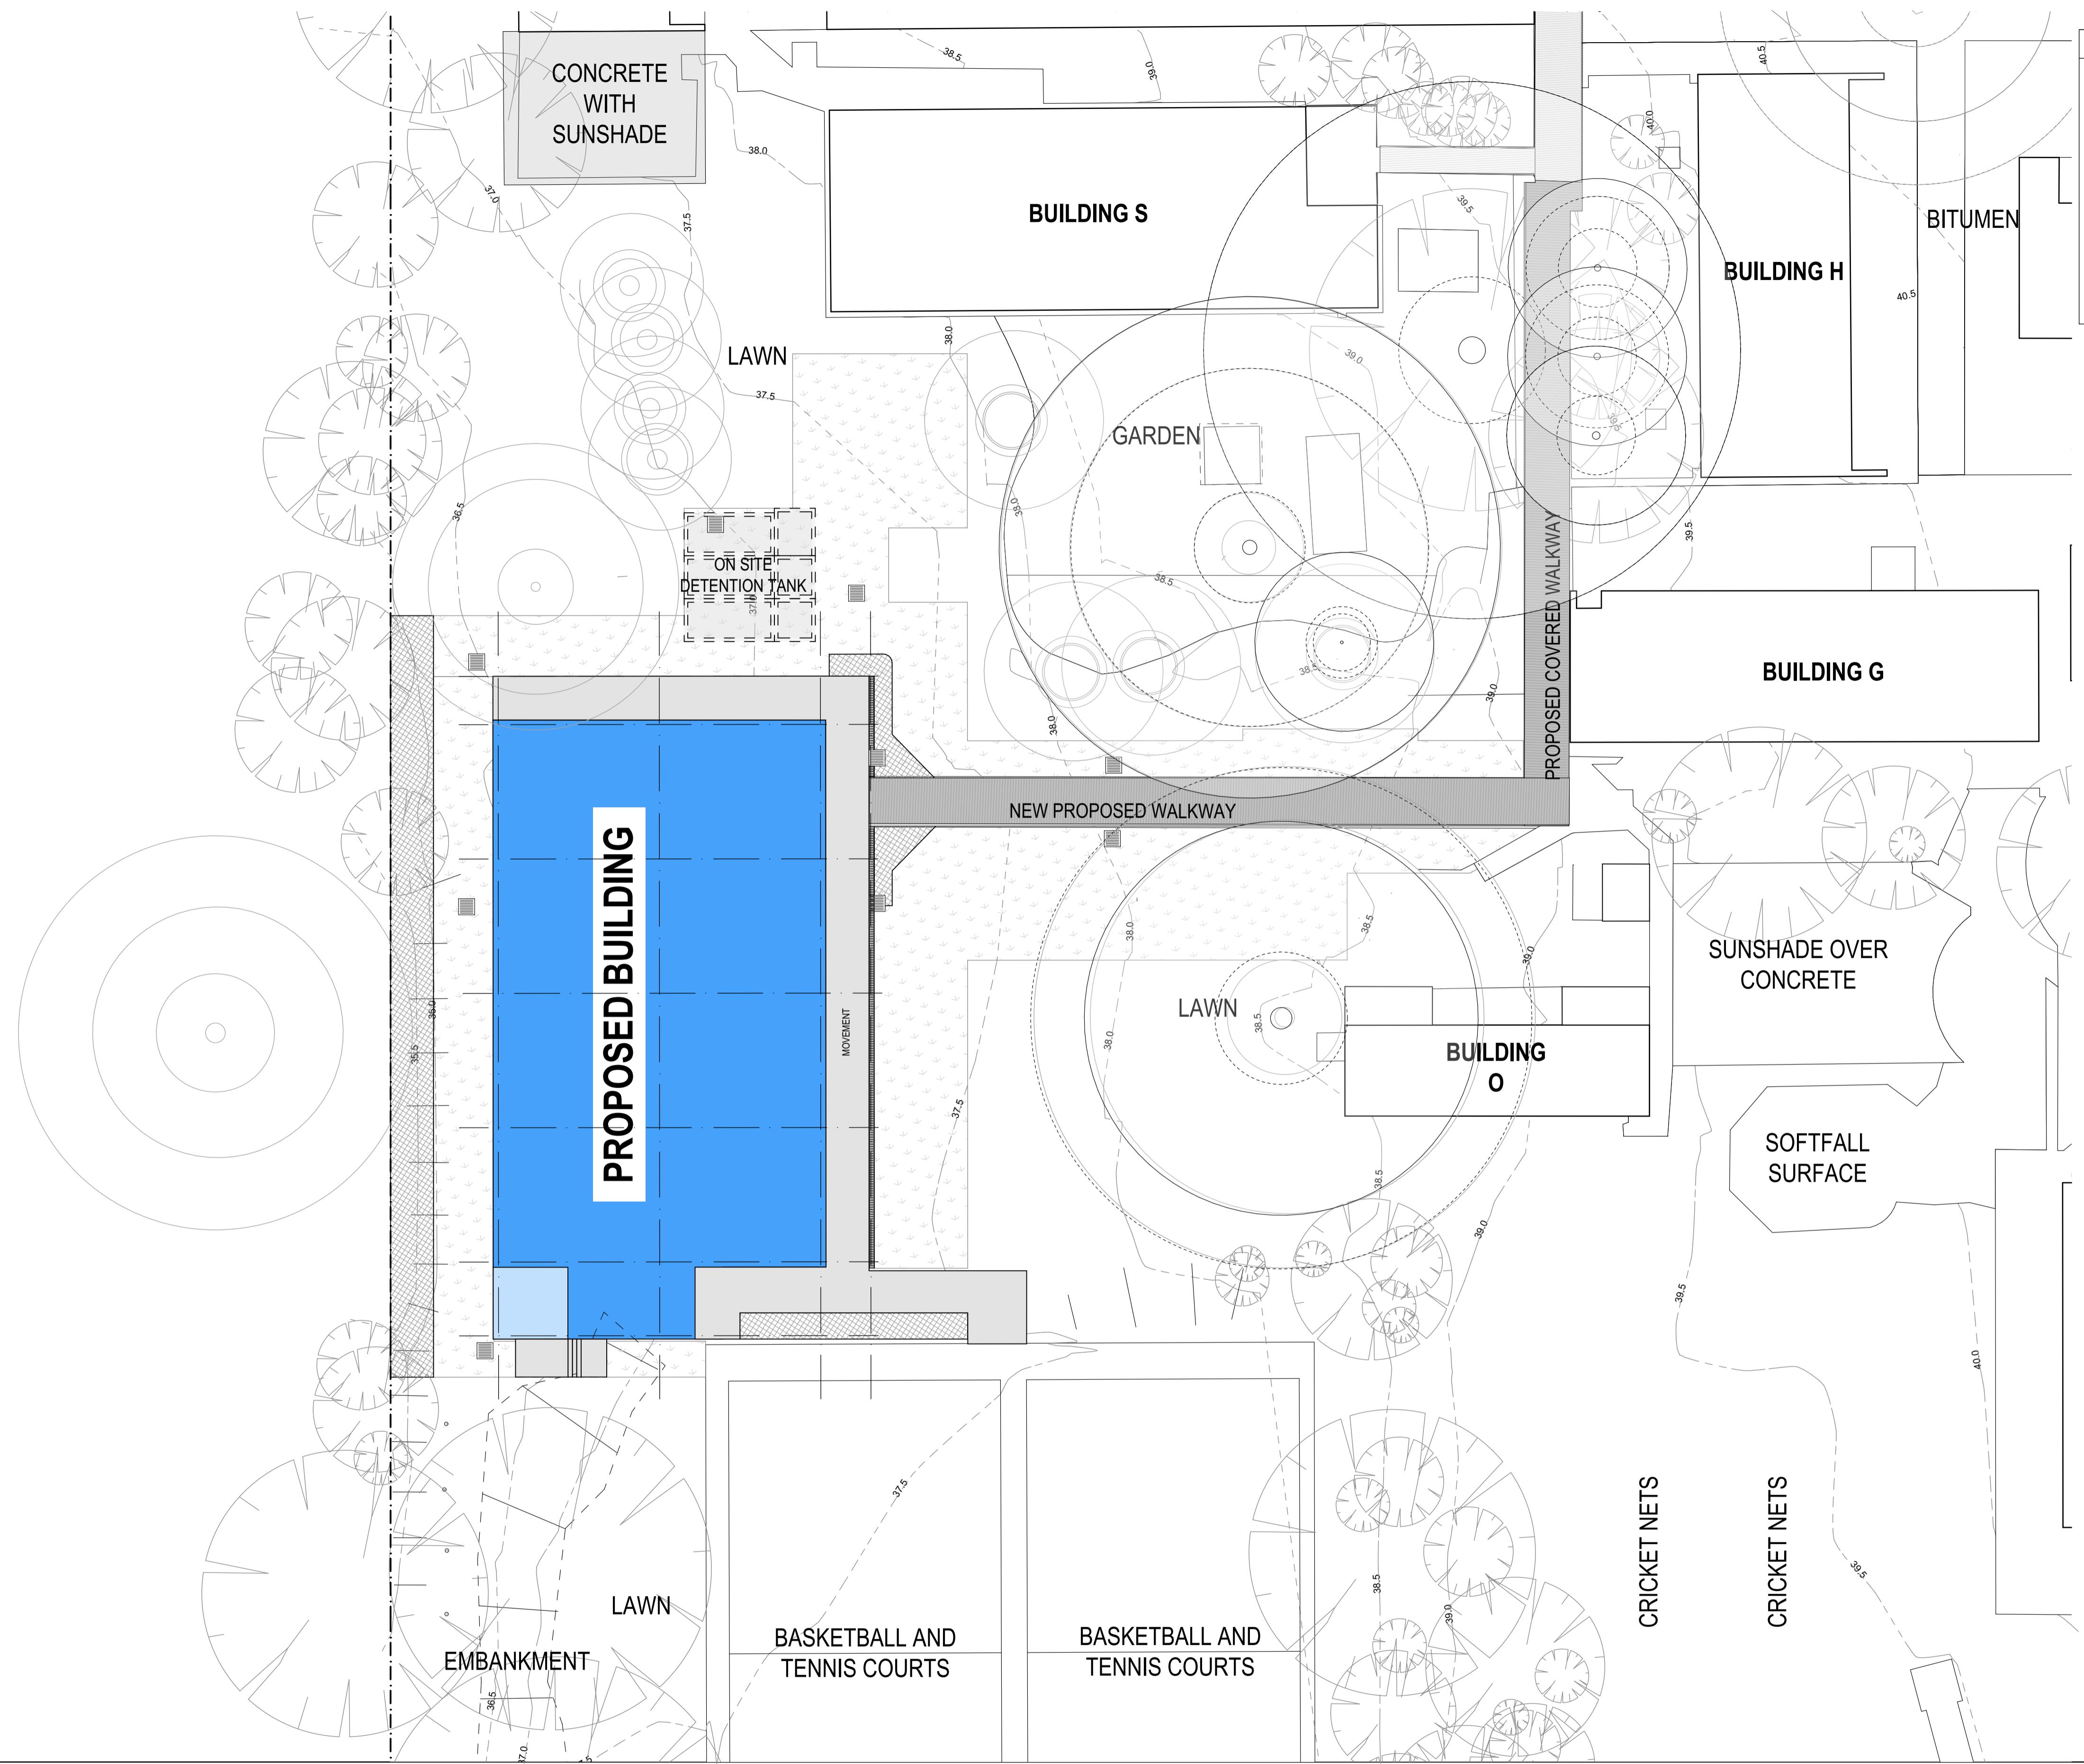
DIRECTORS Greg McRae, John Ebenezer Frais, John Ward, Karen D'Amato, Paul Sutcliffe, Ryan Lovelady Frais  
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VIC 18804 NSW 8371 QLD 3313  
NSW 7434 QLD 4250  
NSW 7780 QLD 4508  
Ryan Lovelady Frais QLD 4500

PROJECT NUMBER 7068ND01 DIRECTOR JW  
DRAWING NUMBER NPS-FTA-00-00-DR-A-1402  
REVISION 02

PROPOSED COVERED  
WALKWAY  
PHASE  
CLIENT  
SCHEMATIC DESIGN  
SCHOOL INFRASTRUCTURE  
NSW

NORTHMEAD PUBLIC SCHOOL  
MOXHAMS ROAD,  
NORTHMEAD, NSW

REV.	DESCRIPTION	DATE	INIT.
02	100% SCHEMATIC DESIGN	19/12/2024	NK
01	FOR INFORMATION	13/12/2024	AK





# **1 PLAN**

## **EXTERNAL WORKS PLAN**

SCALE: 1:200

REV.	DESCRIPTION	DATE	INIT.
03	100% SCHEMATIC DESIGN	19/12/2024	AK
02	95% SCHEMATIC DESIGN	10/12/2024	AK
01	80% SCHEMATIC DESIGN	26/11/2024	AK
P3	100% CONCEPT DESIGN	31/10/2024	NK
P2	80% CONCEPT DESIGN	18/10/2024	AK
P1	FOR INFORMATION	27/09/2024	AK

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**PHASE** | **SCHEMATIC DESIGN**

**CLIENT** | **SCHOOL INFRASTRUCTURE**

**NSW**

---


**PROJECT** | **NORTHMEAD PUBLIC SCHOOL**

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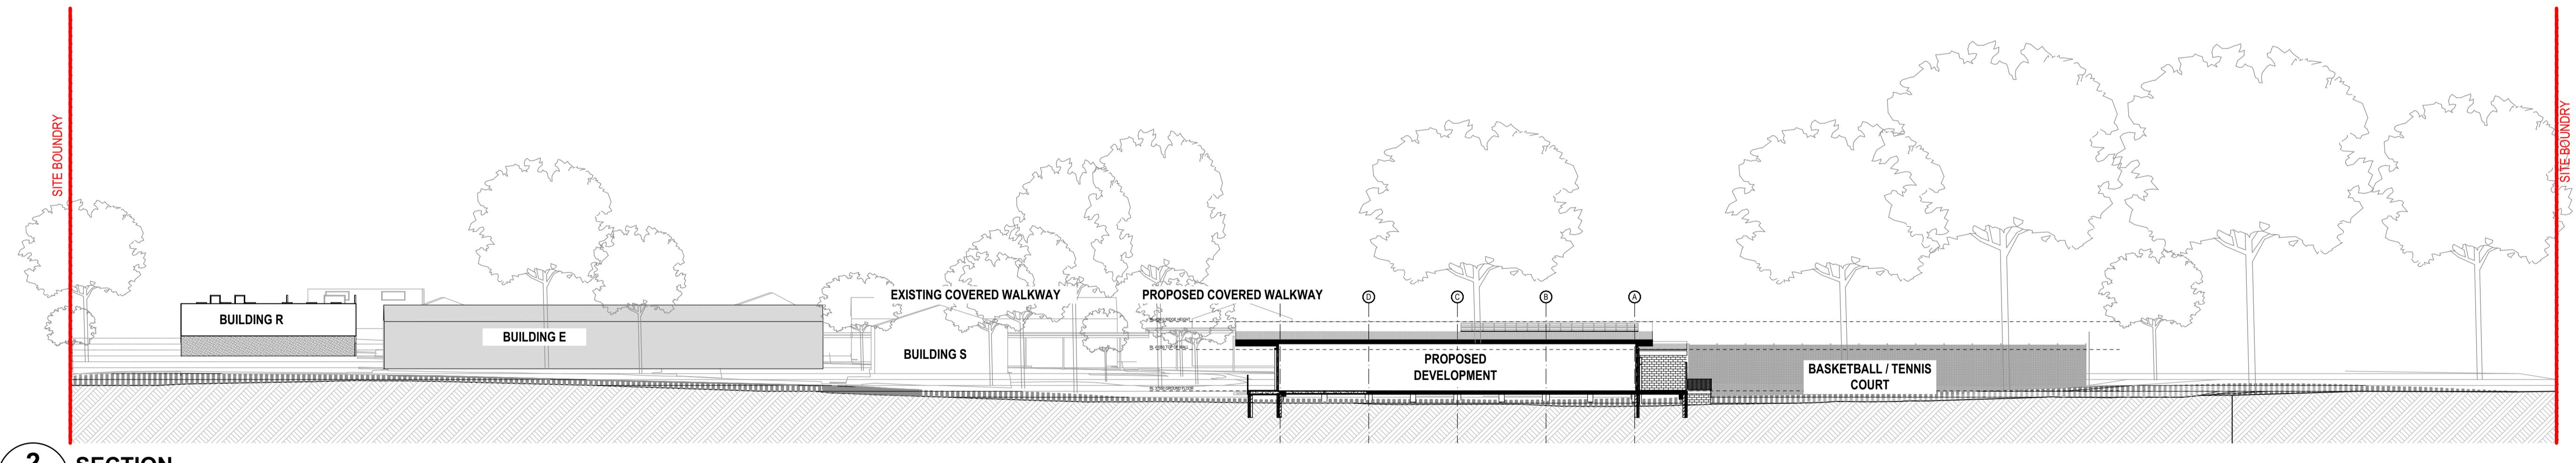
**ADDRESS** | **MOXHAMS ROAD,  
NORTHMEAD, NSW**

---

<b>EXTERNAL WORKS PLAN</b>	
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PROJECT NUMBER	DIRECTOR
<b>7068ND01</b>	JW
RAWING NUMBER	
<b>NPS-FTA-00-00-DR-A-1401</b>	

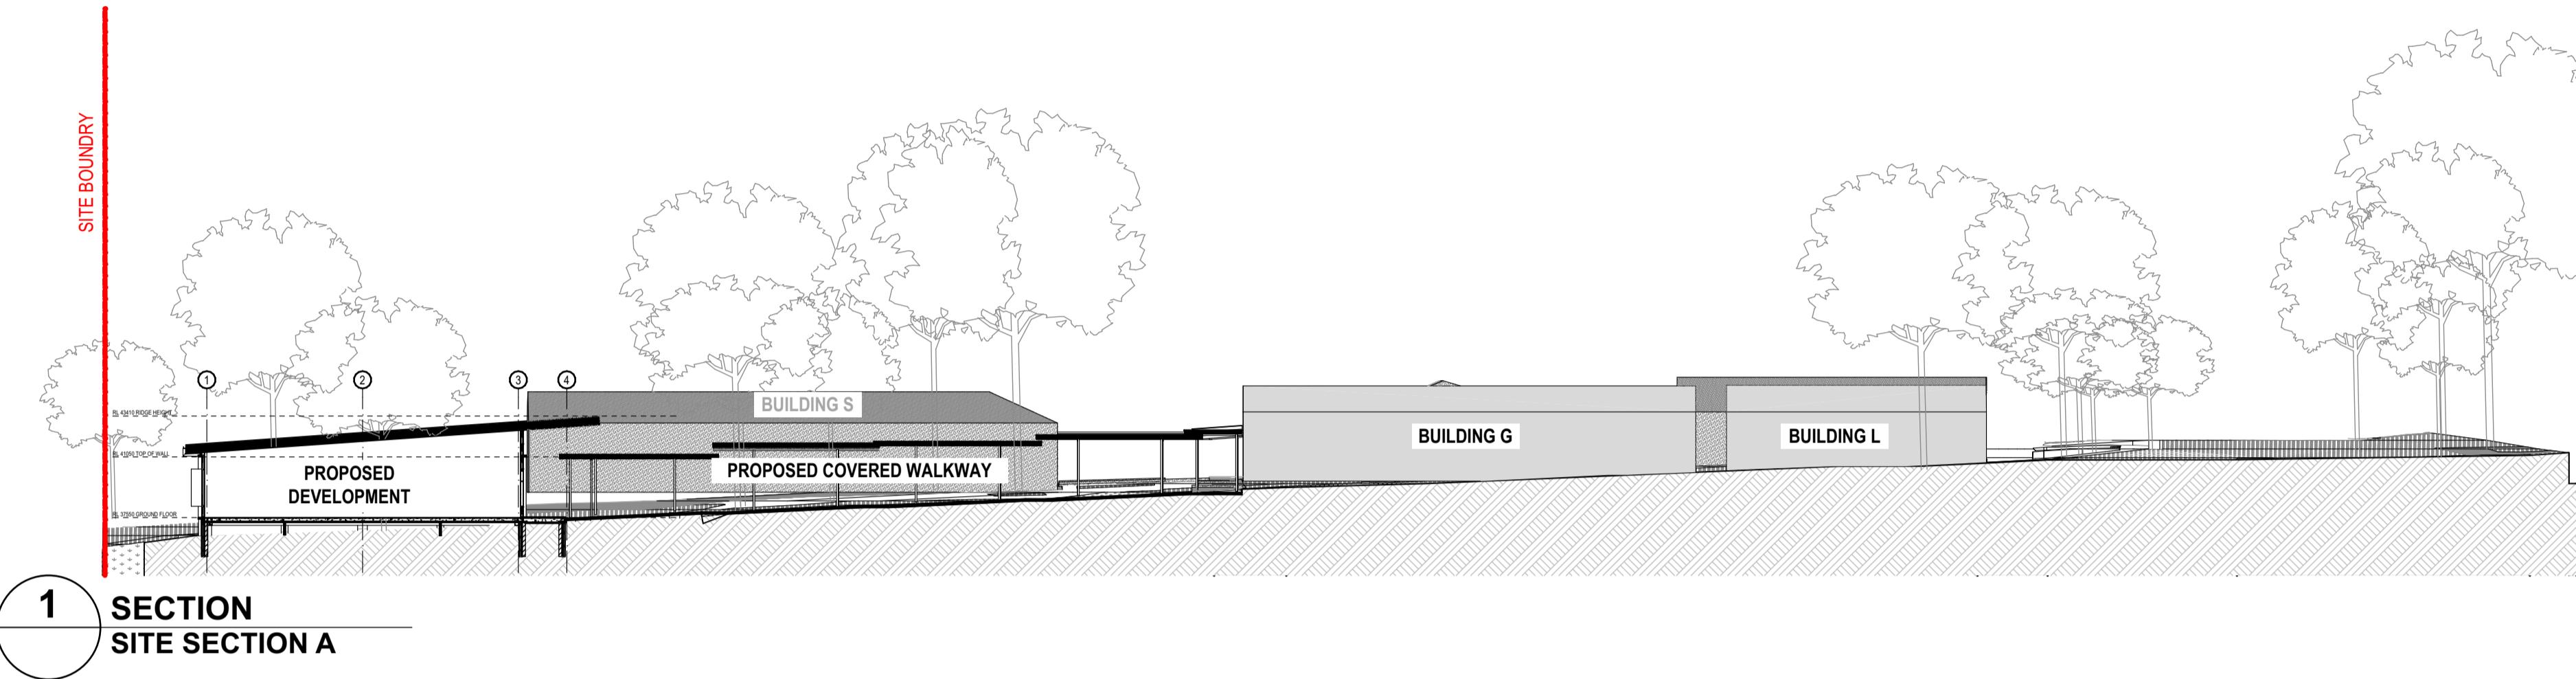

**1 SECTION  
SITE SECTION A**



**2 SECTION  
SITE SECTION B**

150mm @ A1

REV.	DESCRIPTION	DATE	INIT.
02	100% SCHEMATIC DESIGN	19/12/2024	AK
01	95% SCHEMATIC DESIGN	10/12/2024	AK

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VIC 18804		

PROJECT NUMBER	CLIENT	PHASE	SITE SECTIONS
7068ND01	JW		
DRAWING NUMBER			

REVISION	02
NPS-FTA-00-00-DR-A-1201	



REV.	DESCRIPTION	DATE	INIT.
04	100% SCHEMATIC DESIGN	19/12/2024	AK
03	95% SCHEMATIC DESIGN	10/12/2024	AK
02	80% SCHEMATIC DESIGN	26/11/2024	AK
01	SD-01 - 50% SCHEMATIC DESIGN	15/11/2024	AK
P4	100% CONCEPT DESIGN	31/10/2024	NK
P3	80% CONCEPT DESIGN	18/10/2024	AK
P2	FOR INFORMATION	27/09/2024	AK
P1	FOR INFORMATION	20/09/2024	AK

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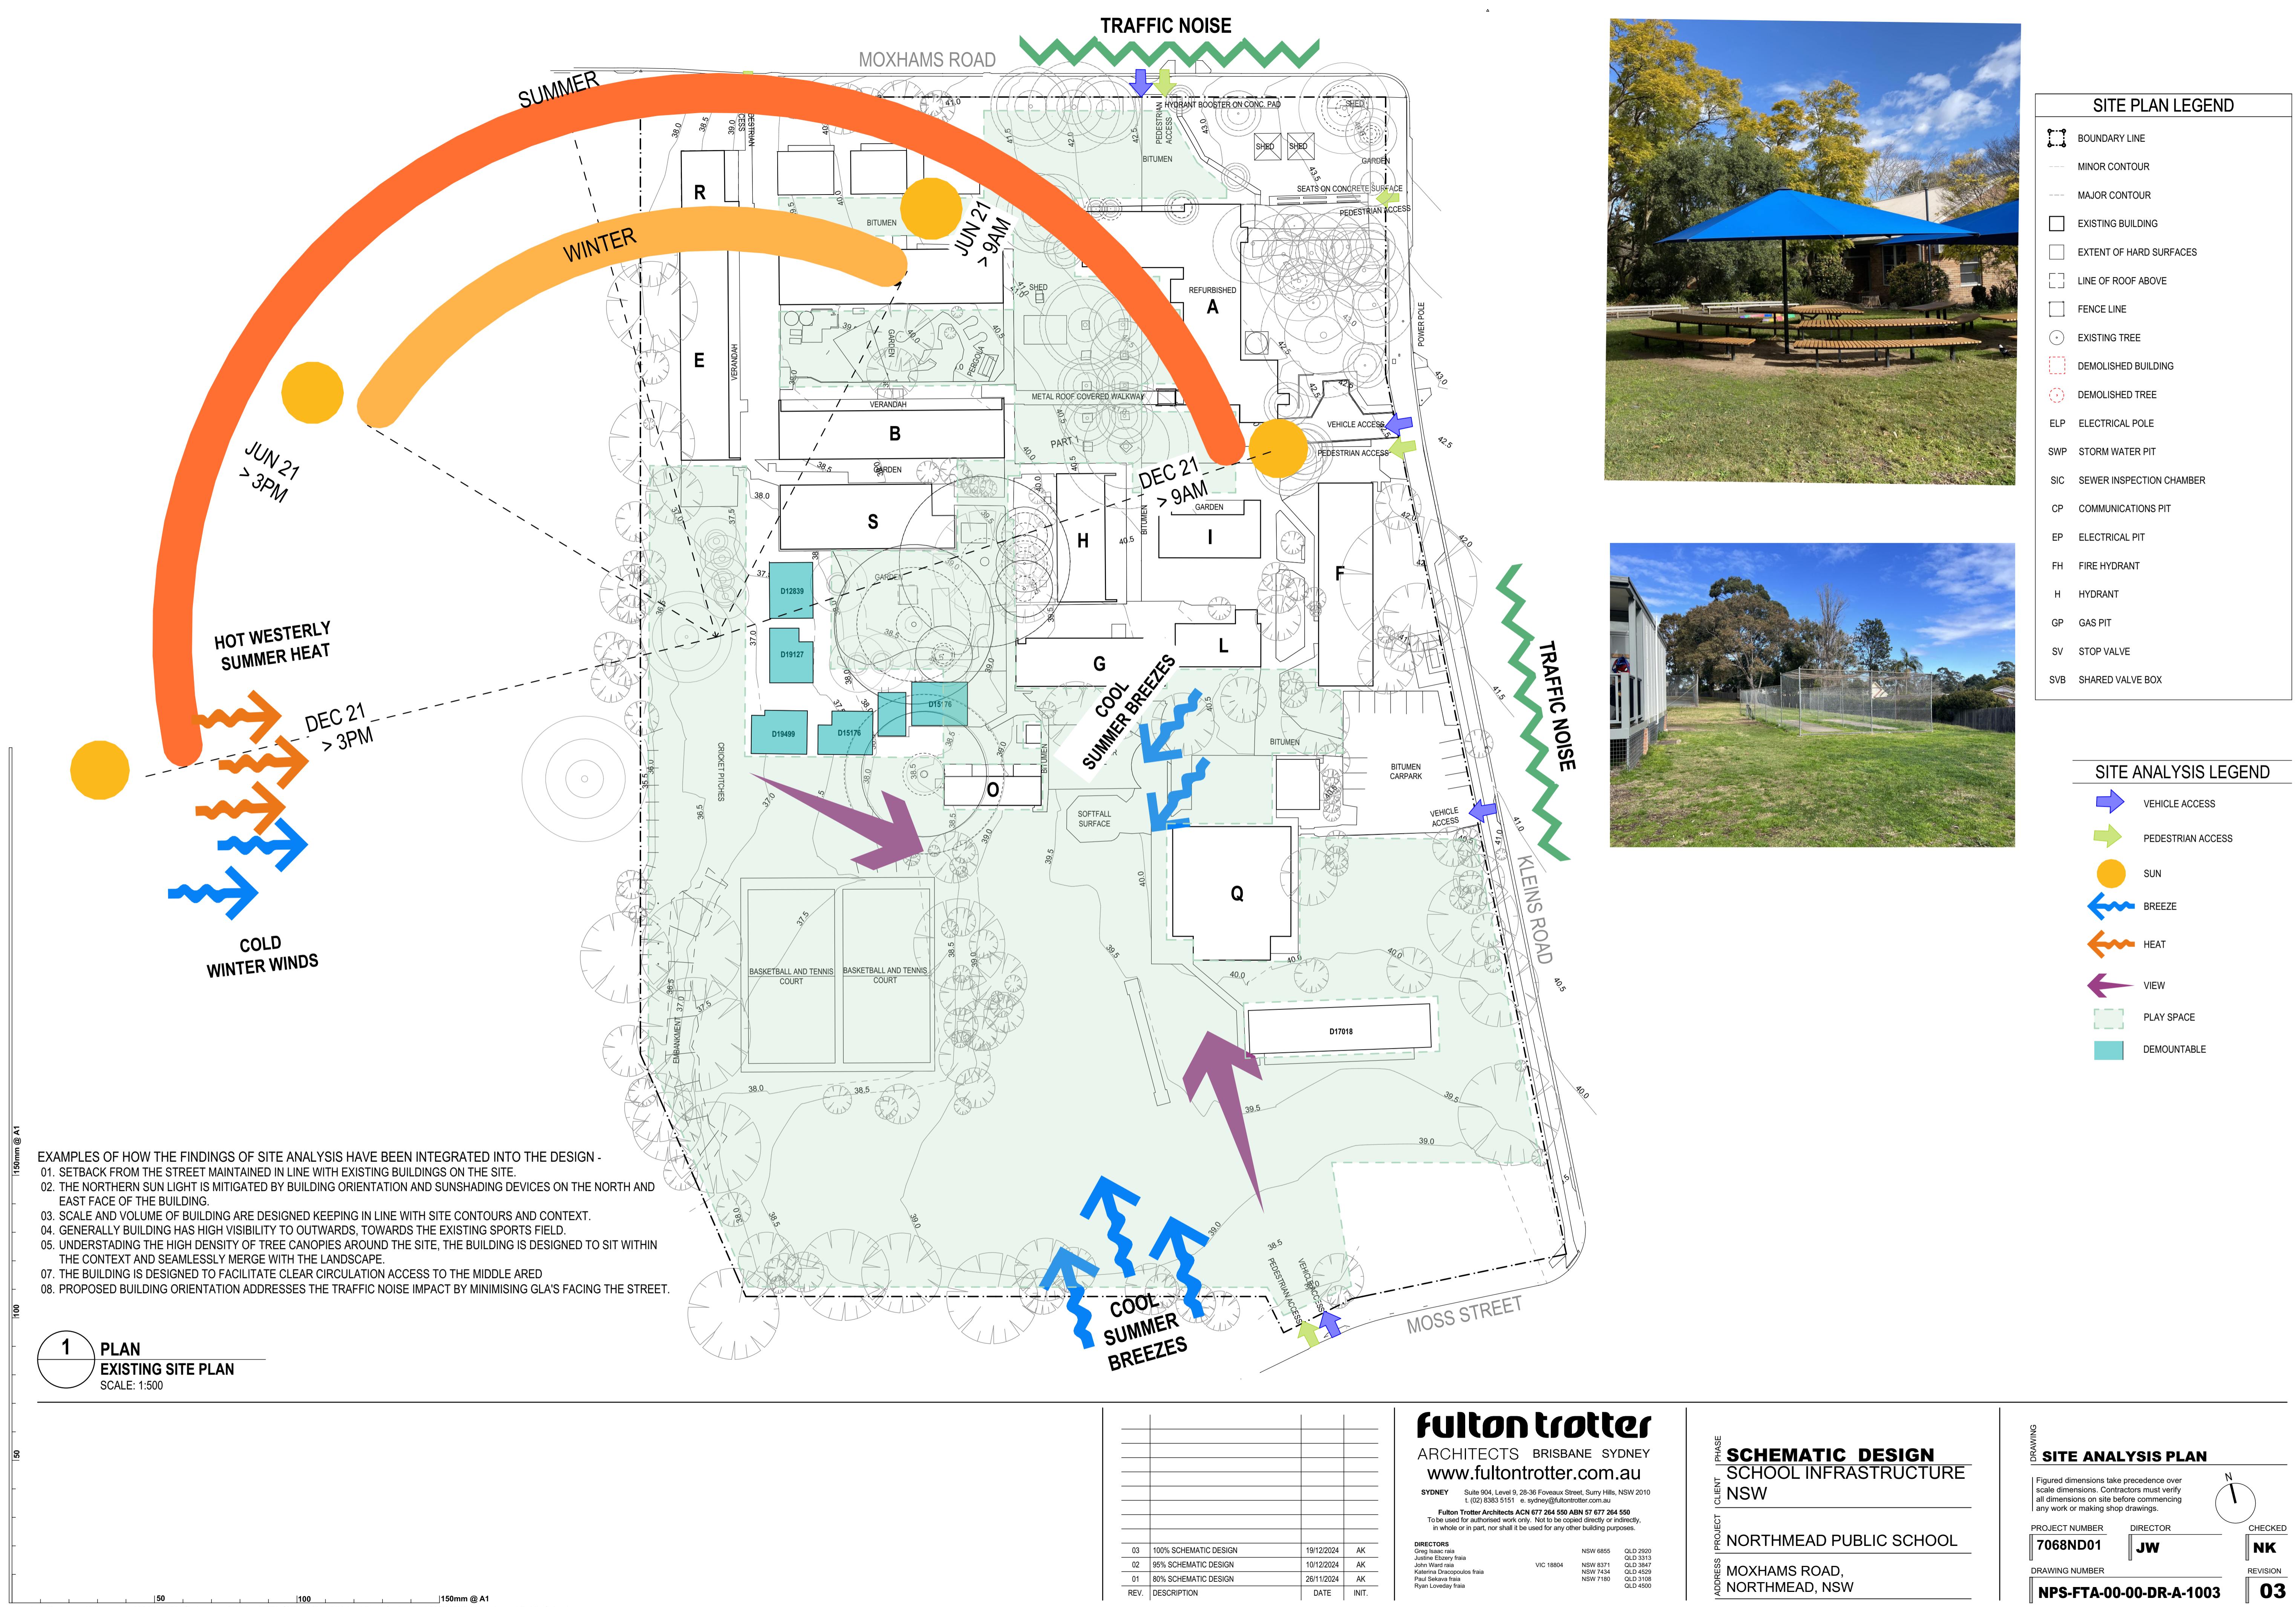
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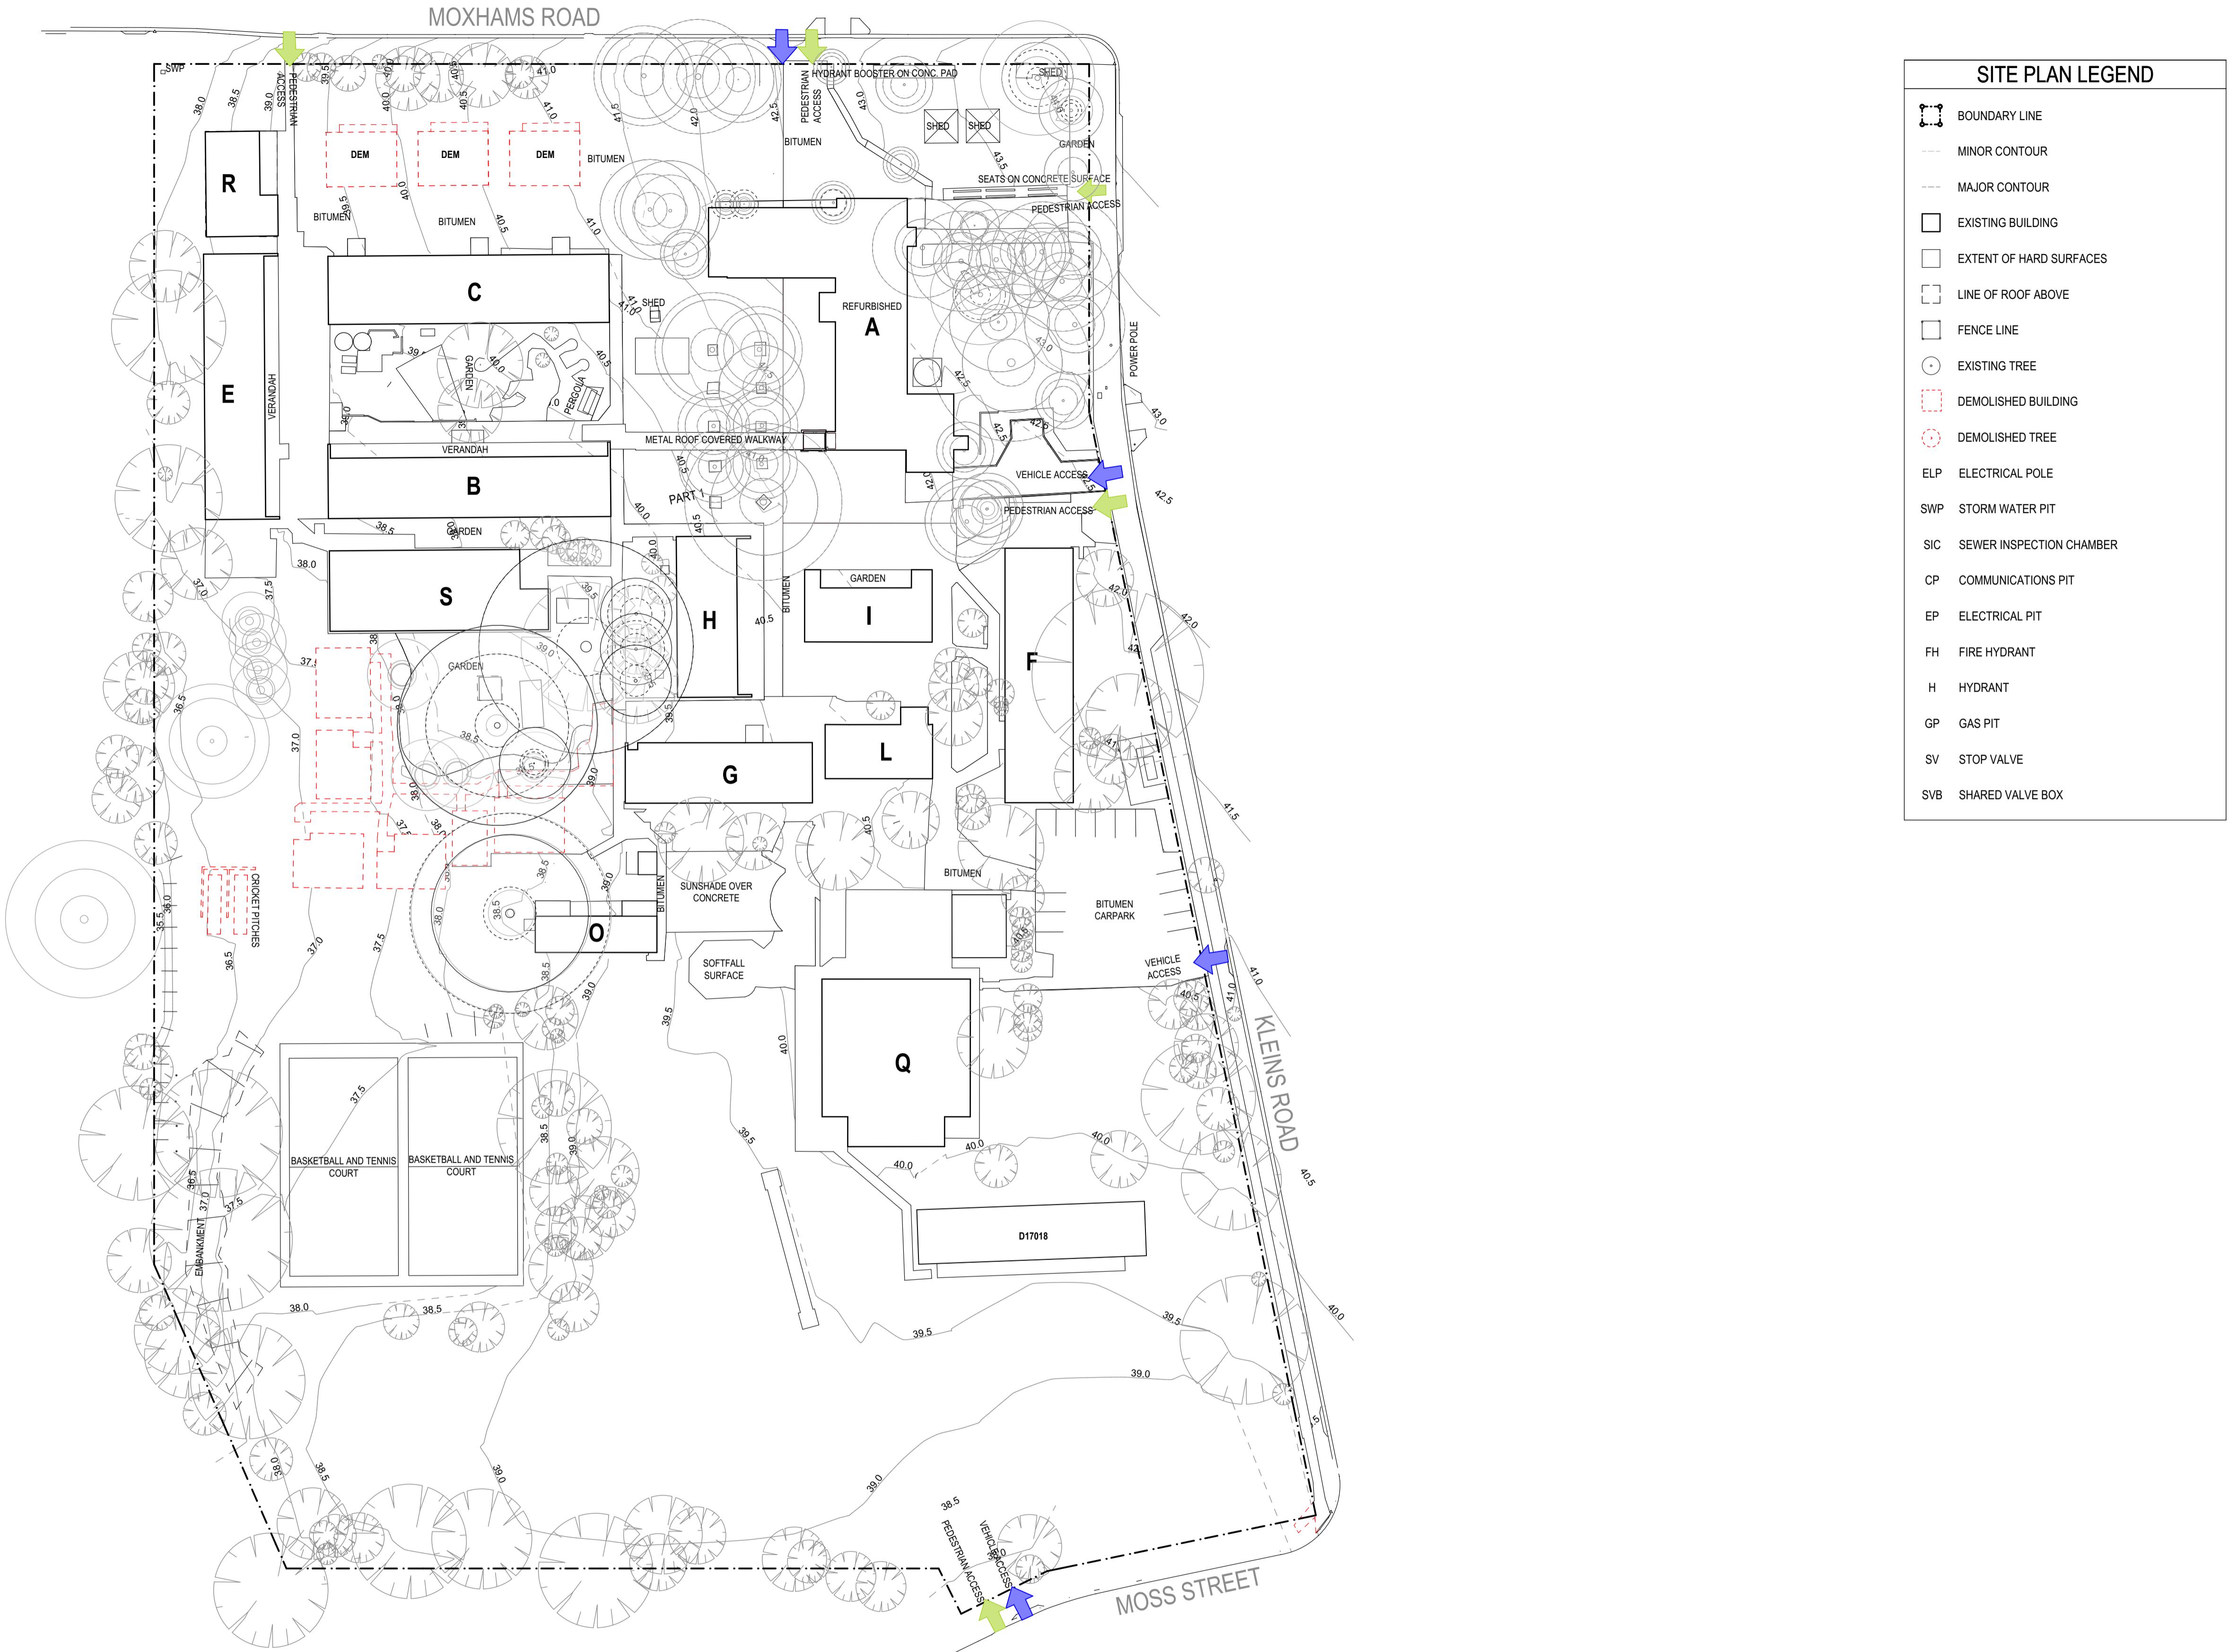
NSW 6855	QLD 2950
John Wardraia	QLD 5313
John Wardraia	NSW 8371
Karen Dimmickraia	QLD 3847
Paul Senebraia	NSW 7434
Ryan Loveladyraia	QLD 4529
	NSW 7780
	QLD 4508

VIC 18804


**SCHEMATIC DESIGN**  
SCHOOL INFRASTRUCTURE  
NSW  
NORTHMEAD PUBLIC SCHOOL  
MOXHAMS ROAD,  
NORTHMEAD, NSW

PROJECT NUMBER: NPS-FTA-00-00-DR-A-1101  
DRAWING NUMBER: NPS-FTA-00-00-DR-A-1101  
REVISION: 04  
PHASE: PROPOSED SITE PLAN  
CLIENT: fulton trotter  
DIRECTOR: NK  
CHECKED: NK





**1 PLAN**  
**DEMOLITION PLAN**  
SCALE: 1:500

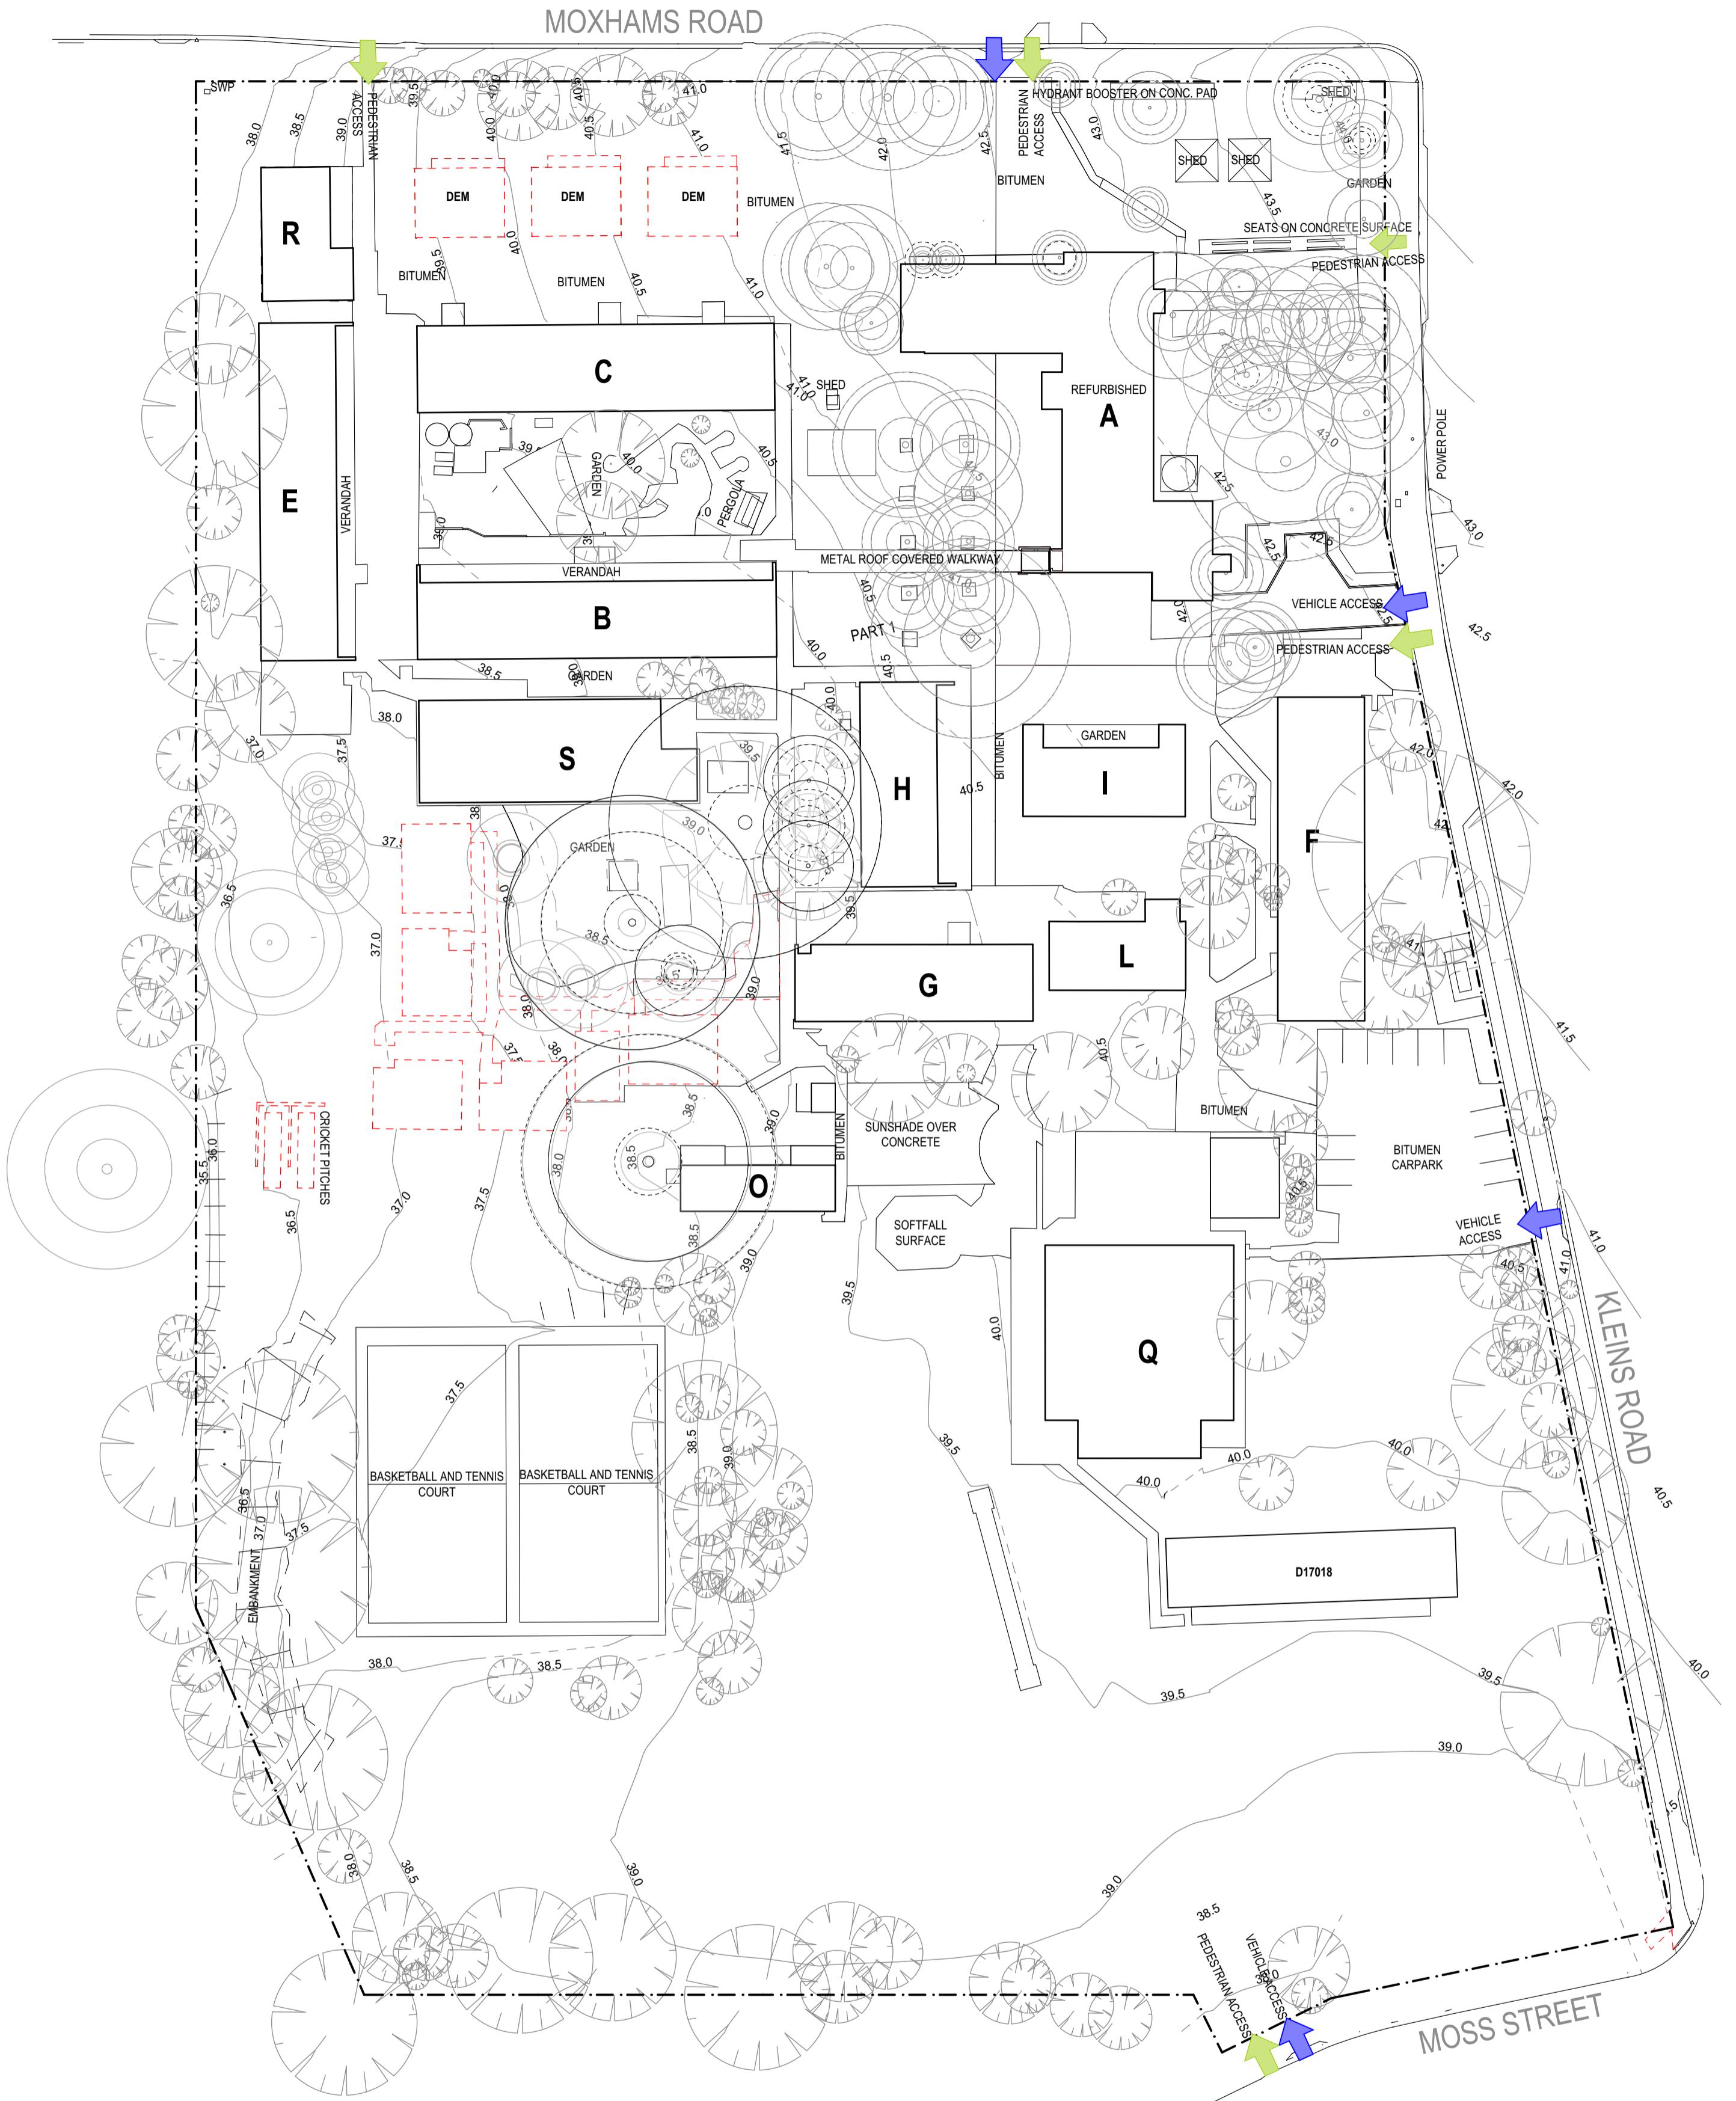

REV.	DESCRIPTION	DATE	INIT.
03	100% SCHEMATIC DESIGN	19/12/2024	AK
02	95% SCHEMATIC DESIGN	19/12/2024	AK
01	80% SCHEMATIC DESIGN	26/11/2024	AK

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DIRECTORS	Greg Ward ria John Ward ria Kieren Dimmick ria Paul Suttor ria Ryan Lovelady ria
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NSW 8371	QLD 5313
NSW 7434	QLD 3847
NSW 7780	QLD 4528
VIC 18804	QLD 4508

PROJECT NUMBER	CLIENT	PHASE	DRAWING NUMBER	REVISION
7068ND01	JW			NK
NPS-FTA-00-00-DR-A-1002				03

**1 PLAN**  
**EXISTING SITE PLAN**

SCALE: 1:500



SITE PLAN LEGEND	
	BOUNDARY LINE
	MINOR CONTOUR
	MAJOR CONTOUR
	EXISTING BUILDING
	EXTENT OF HARD SURFACES
	LINE OF ROOF ABOVE
	FENCE LINE
	EXISTING TREE
	DEMOLISHED BUILDING
	DEMOLISHED TREE
	ELP ELECTRICAL POLE
	SWP STORM WATER PIT
	SIC SEWER INSPECTION CHAMBER
	CP COMMUNICATIONS PIT
	EP ELECTRICAL PIT
	FH FIRE HYDRANT
	H HYDRANT
	GP GAS PIT
	SV STOP VALVE
	SVB SHARED VALVE BOX

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DIRECTORS	Greg Ward ria	NSW 6855	QLD 2950
	John Ward ria	QLD 5313	
	Karen Dimmick ria	NSW 8371	QLD 3847
	Paul Suttor ria	NSW 7434	QLD 4529
	Ryan Lovelady ria	NSW 7780	QLD 4508

REV. DESCRIPTION DATE INIT.

**SCHEMATIC DESIGN**  
**SCHOOL INFRASTRUCTURE**  
**NSW**

PROJECT NUMBER: **NPS-FTA-00-00-DR-A-1001**

PHASE: **EXISTING SITE PLAN**

ADRESS: **NORTHMEAD PUBLIC SCHOOL**  
**MOXHAMS ROAD,**  
**NORTHMEAD, NSW**


Figured dimensions take precedence over scale dimensions. Contractors must verify all dimensions on site before commencing any work or making shop drawings.

PROJECT NUMBER: **7068ND01** DIRECTOR: **JW**

DRAWING NUMBER: **NK**

REVISION: **04**

## Appendix C – Catchment Plan

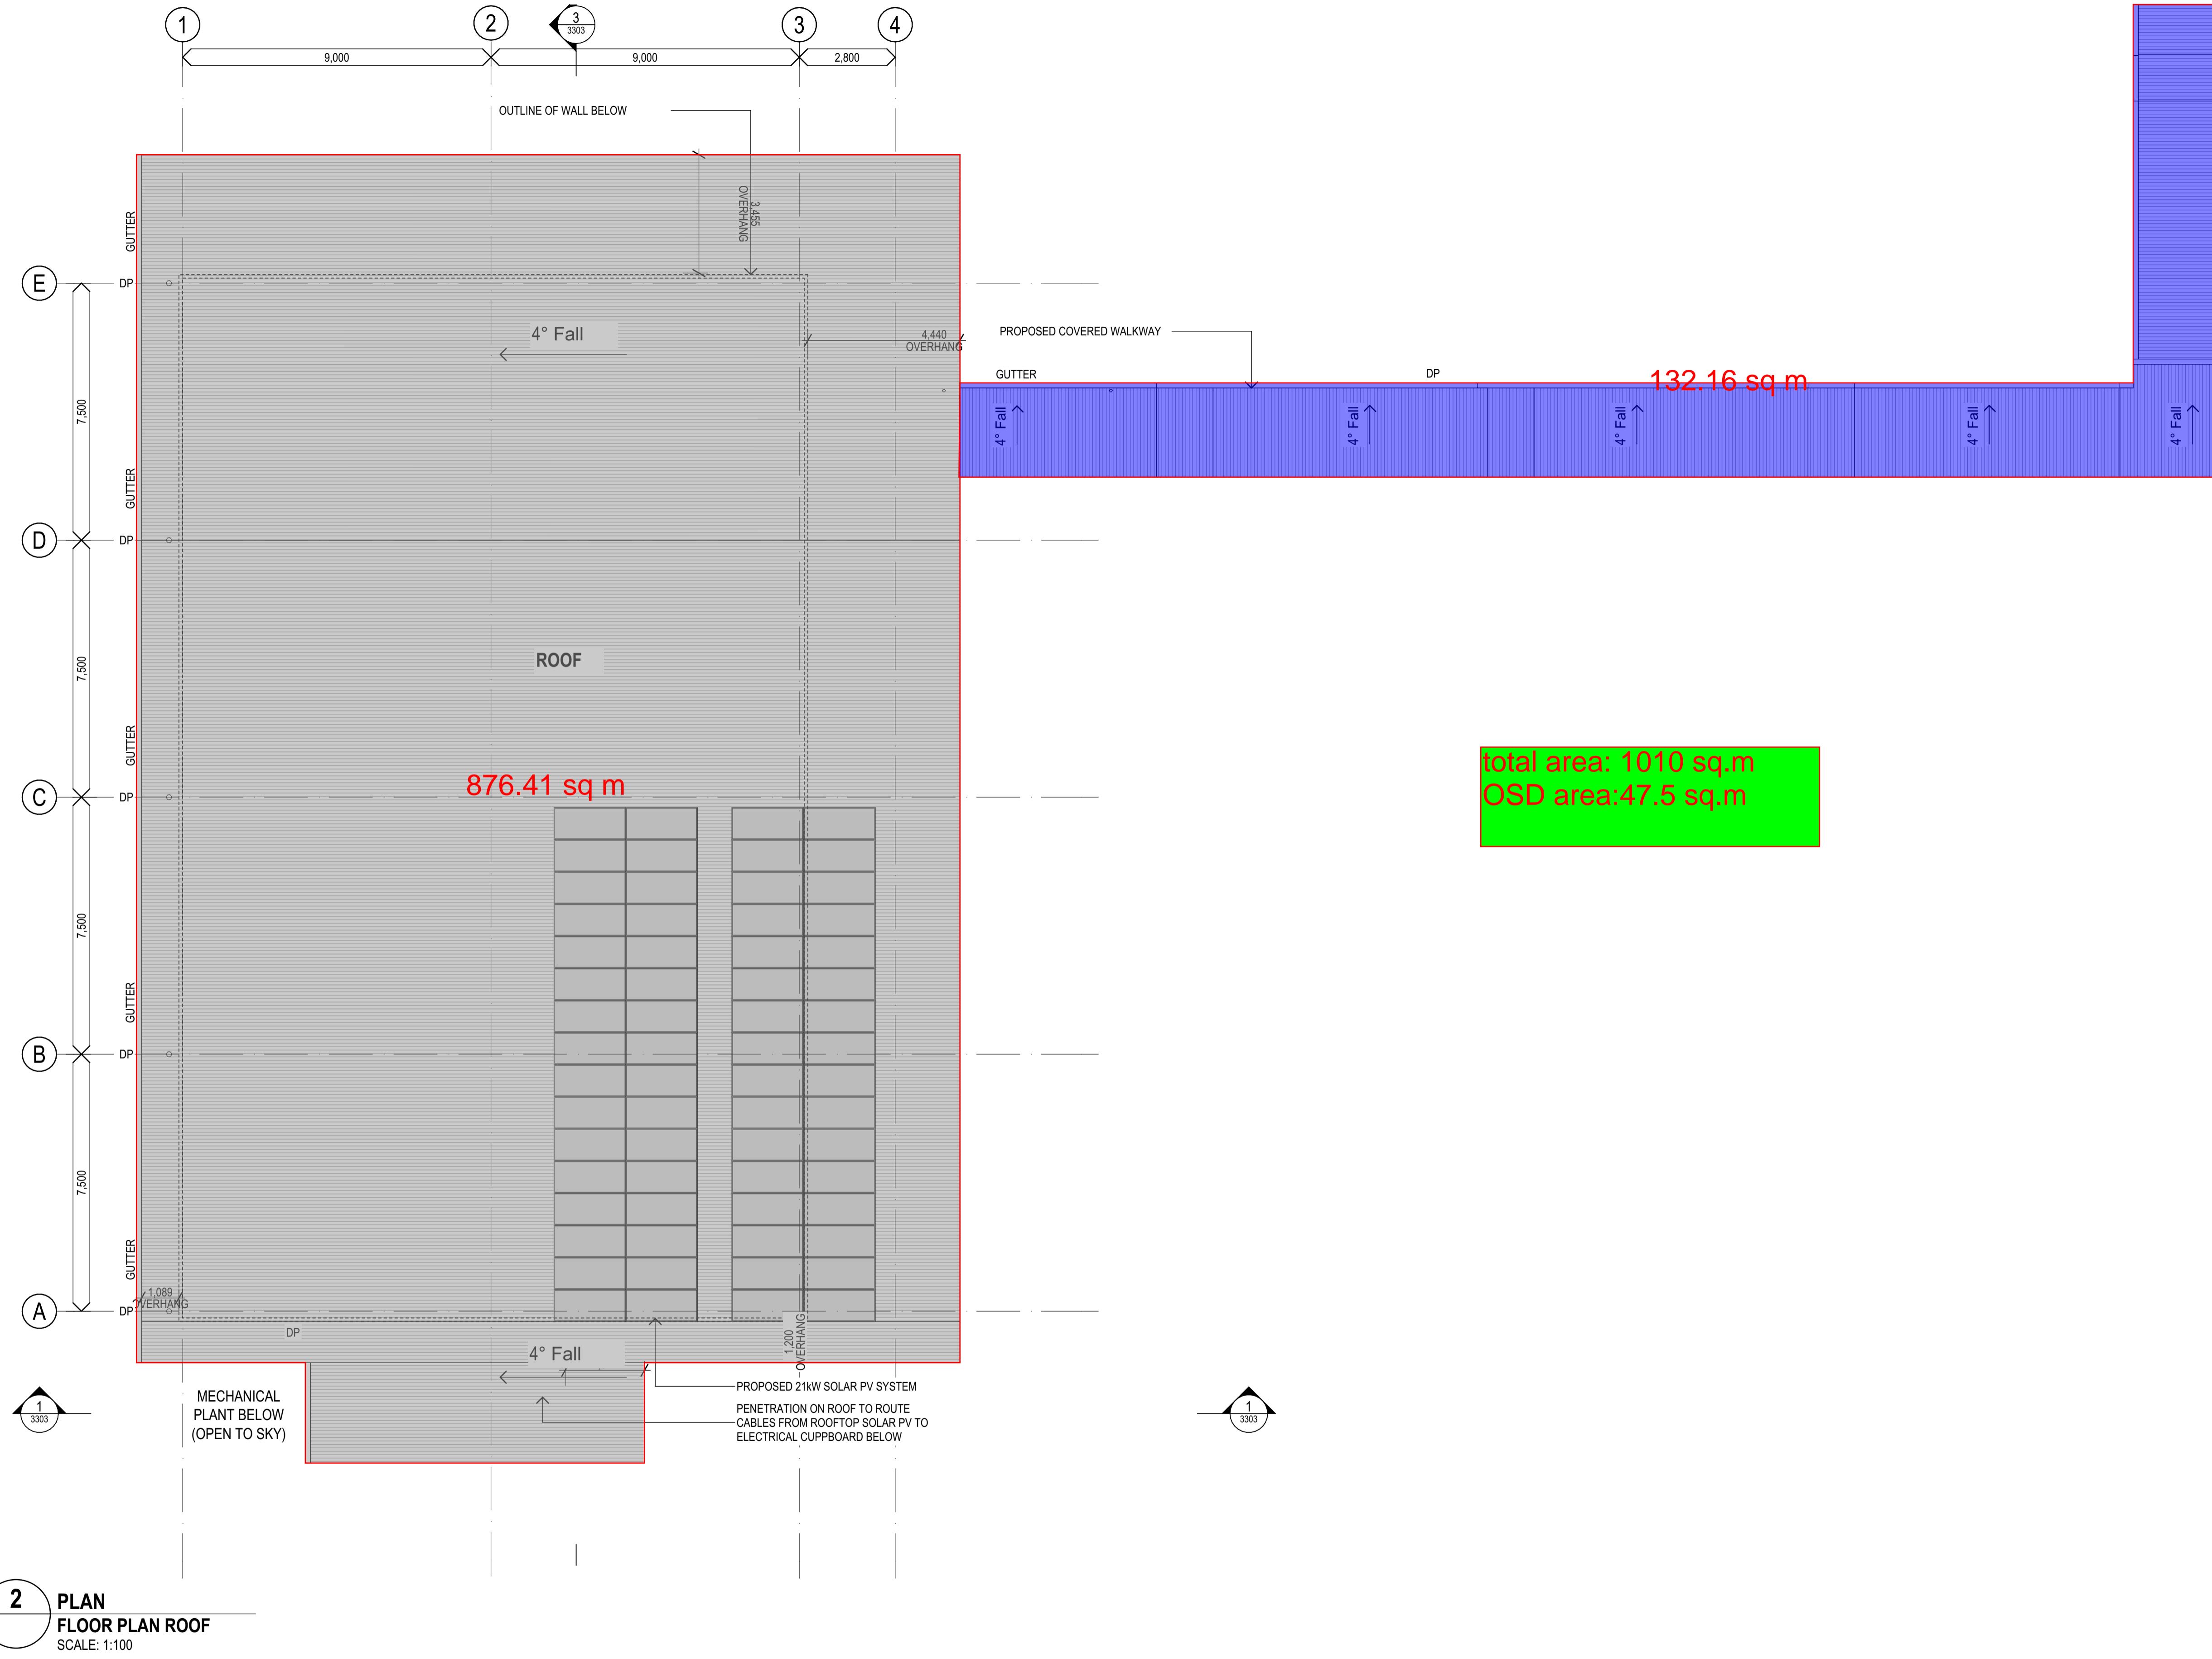

date: Tuesday, 10 December 2024 4:55 PM file location: BIMcloud: FTA-SYD-BIM26 - BIMcloud Basic for Archicad 26/7068ND01 Northmead Public Sch

REV.	DESCRIPTION	DATE	INIT.
03	95% SCHEMATIC DESIGN	10/12/2024	AK
02	80% SCHEMATIC DESIGN	26/11/2024	AK
01	SD-01 - 50% SCHEMATIC DESIGN	15/11/2024	AK
P4	100% CONCEPT DESIGN	31/10/2024	NK
P3	80% CONCEPT DESIGN	18/10/2024	AK
P2	FOR INFORMATION	27/09/2024	AK
P1	FOR INFORMATION	20/09/2024	AK

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Justine Ebzery fraia VIC 18804 NSW 8371 QLD 3  
John Ward raia

Katerina Dracopoulos fraia NSW 7434 QLD 4  
Paul Sekava fraia NSW 7180 QLD 3

Ryan Loveday fraia QLD 4

PHASE | SCHEMATIC DESIGN

CLIENT | SCHOOL INFRASTRUCTURE


NSW

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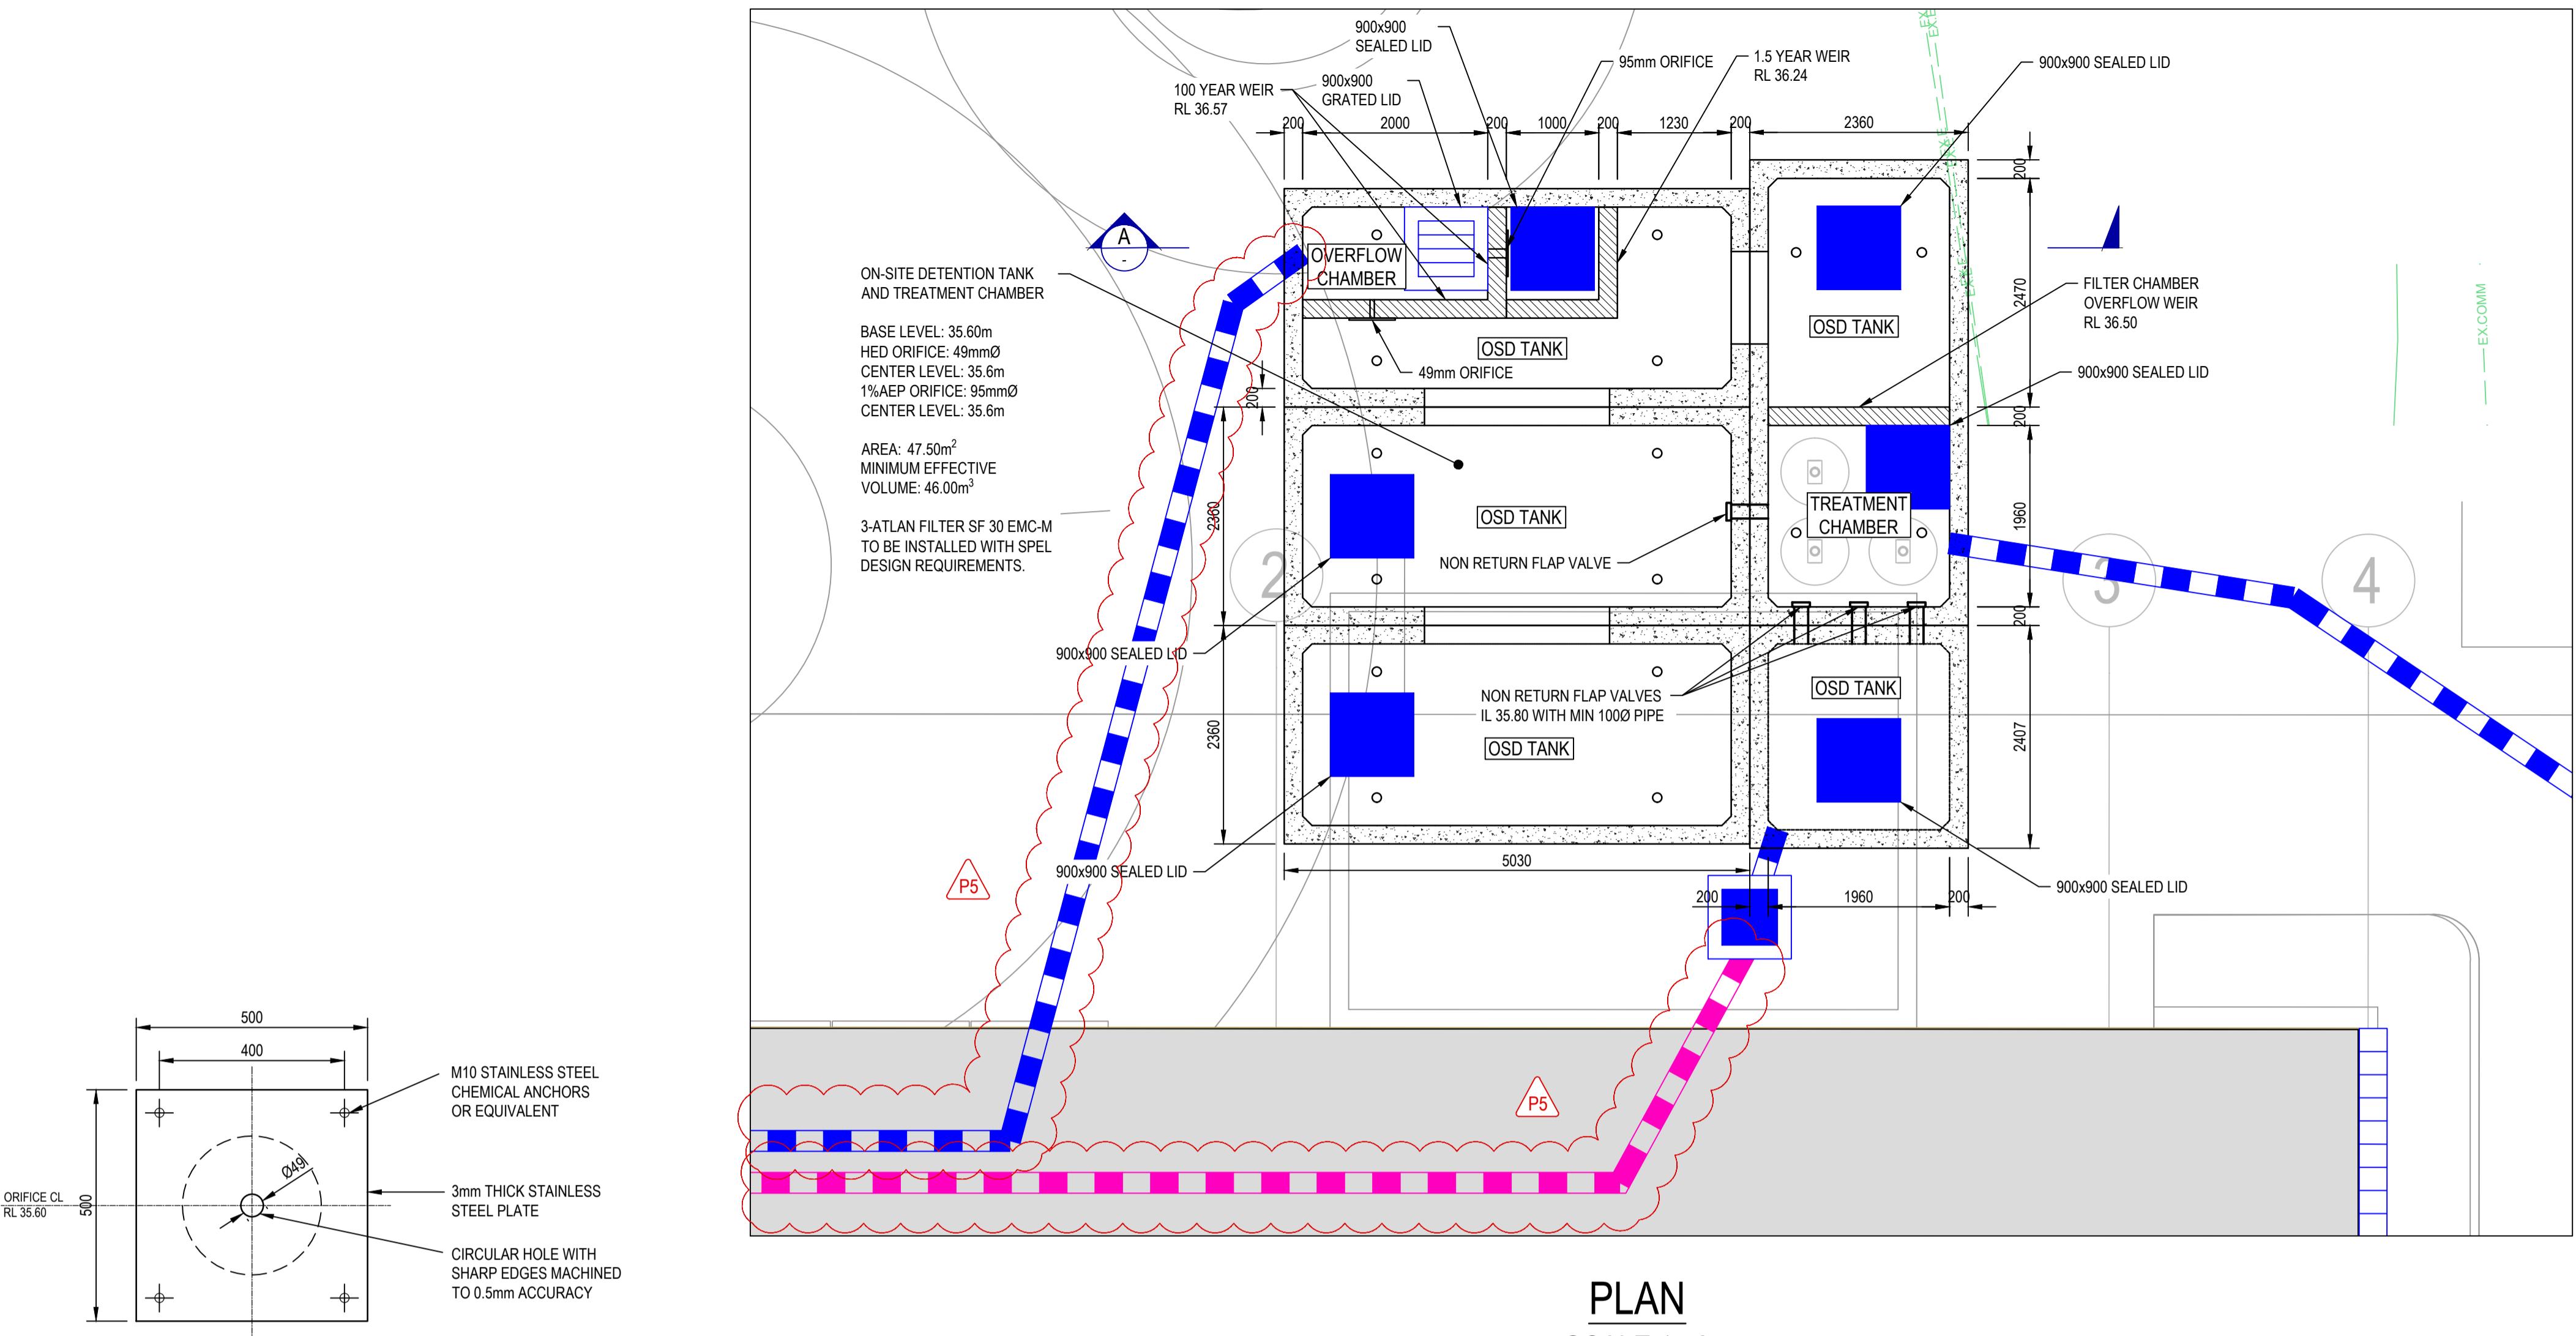
PROJECT | NORTHMEAD PUBLIC SCHOOL

---

ADDRESS | MOXHAMS ROAD,  
NORTHMEAD, NSW

<p><b>DRAWING</b></p> <h1 style="text-align: center;"><b>BUILDING T - ROOF PLAN</b></h1> <hr/> <p>Figured dimensions take precedence over scale dimensions. Contractors must verify all dimensions on site before commencing any work or making shop drawings.</p>		
<p><b>PROJECT NUMBER</b></p> <hr/> <p><b>7068ND01</b></p>	<p><b>DIRECTOR</b></p> <hr/> <p><b>JW</b></p>	<p><b>CHECKED</b></p> <hr/> <p><b>NK</b></p>
<p><b>DRAWING NUMBER</b></p> <hr/> <p><b>NPS-FTA-B00T-LR-DR-A-2102</b></p>		<p><b>REVISION</b></p> <hr/> <p><b>03</b></p>

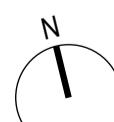
## Appendix D – Stormwater Drainage and OSD Tank Plan and Detail



**PLAN**  
SCALE 1:50


**ORIFICE PLATE DETAIL (HED)**

SCALE 1:10

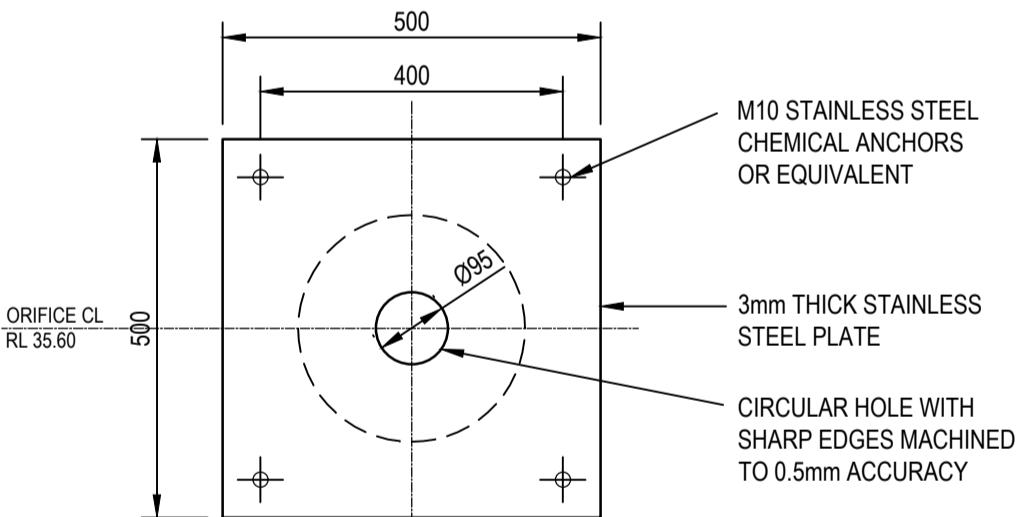

**ORIFICE PLATE DETAIL (1%AEP)**


SCALE 1:10

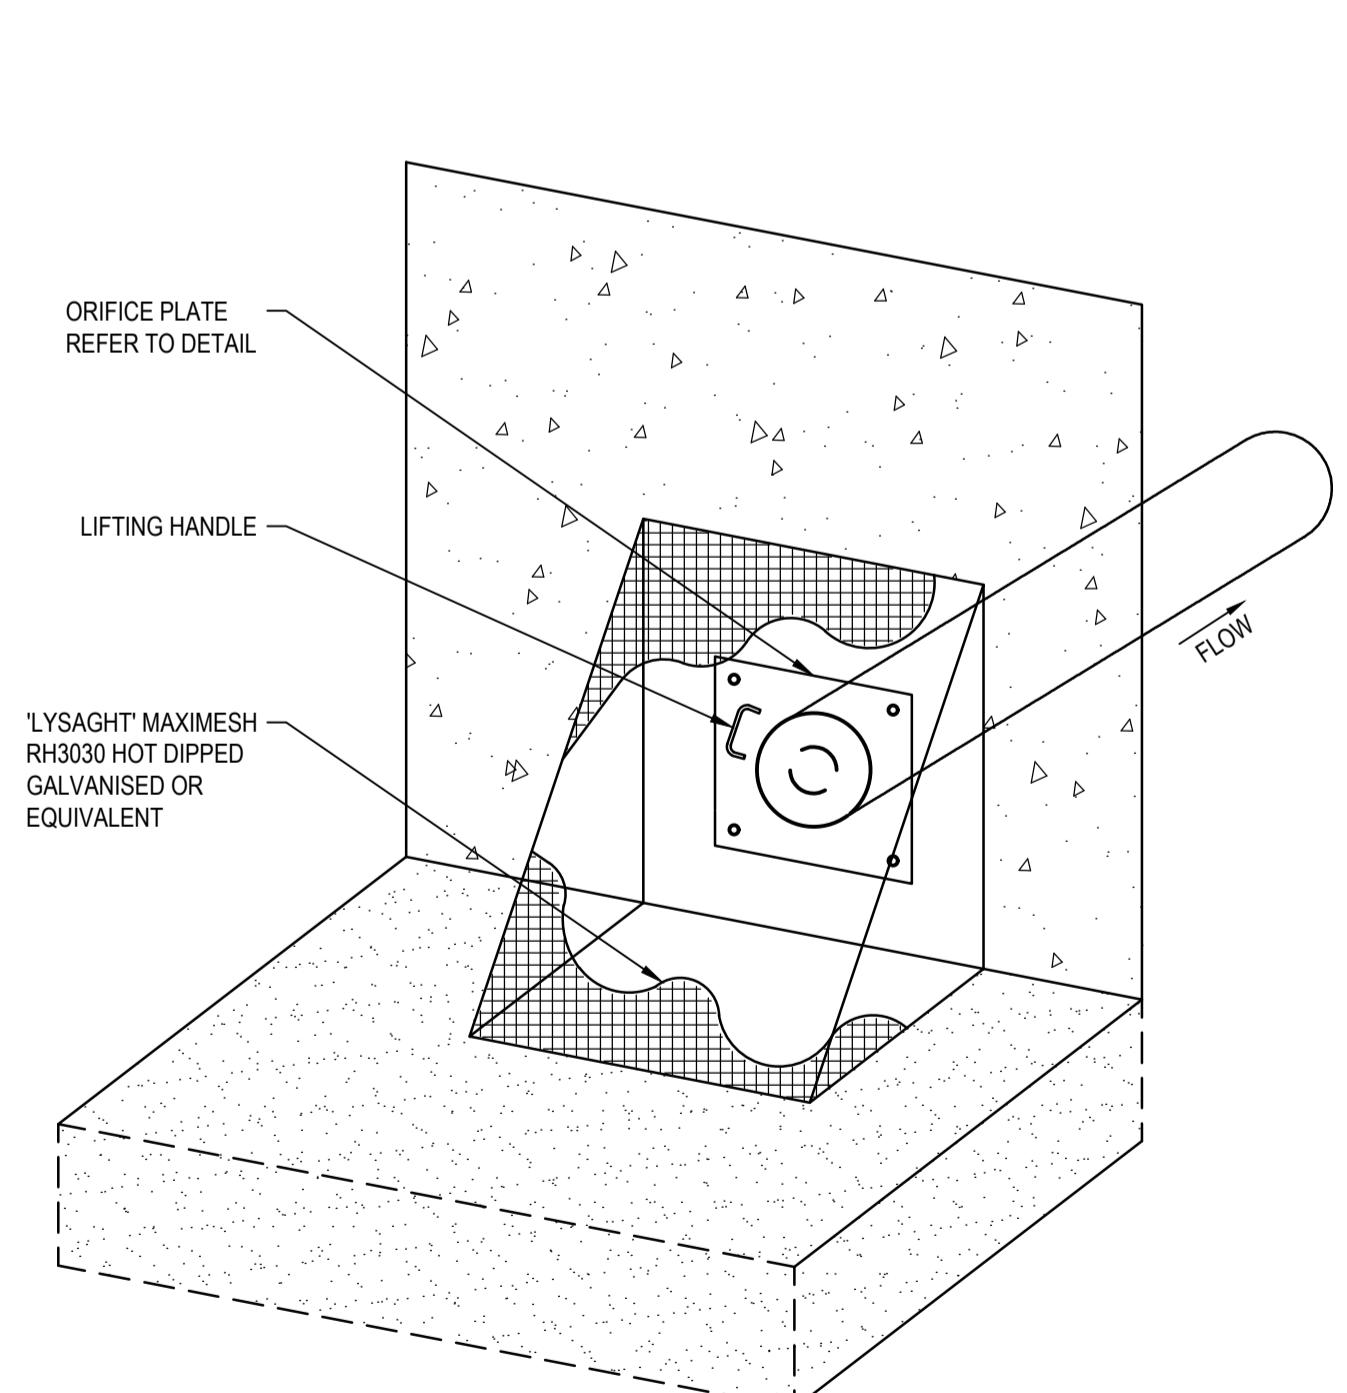

MESH TYPE	MESH SCREEN AREA
LYSAGHT RH3030 FOR ORIFICE 150Ø OR LESS	>50X ORIFICE DIAMETER
'WELDLOK' F40/203 FOR ORIFICE GREATER THAN 150Ø	>50X ORIFICE DIAMETER
NOTE: SCREEN AREA INCLUDES SIDES WHERE APPLICABLE	

**TRASH SCREEN DETAIL**

SCALE N.T.S.

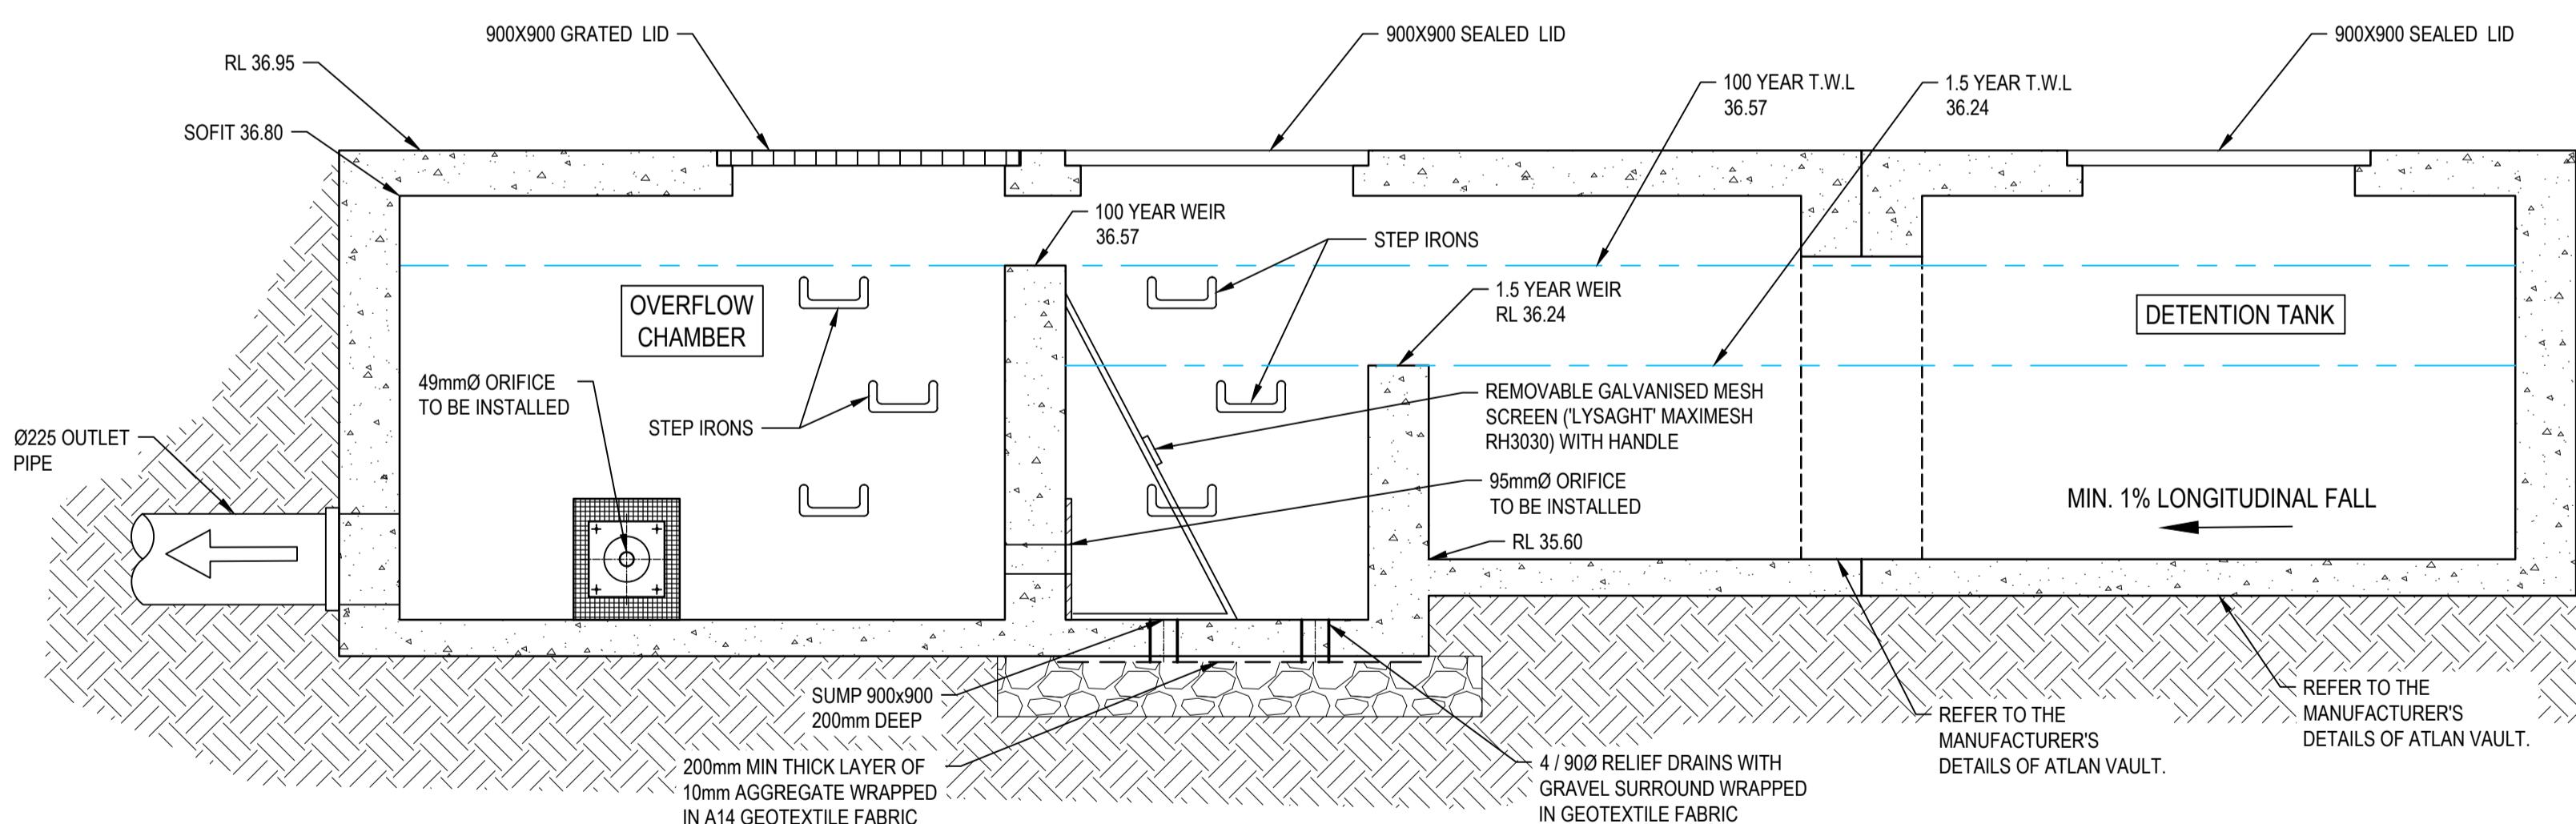

**SECTION**  
SCALE AS SHOWN

REV	DESCRIPTION	BY	DES	CHKD	DATE
P1	75% SCHEMATIC DESIGN ISSUE	J.G	A.N.	B.K.	28.11.24
P2	95% SCHEMATIC DESIGN ISSUE	J.G	A.N.	B.K.	13.12.24
P3	100% SCHEMATIC DESIGN ISSUE	J.G	A.M.	B.K.	20.12.24
P4	100% SCHEMATIC DESIGN ISSUE	J.G	A.M.	B.K.	04.02.25
P5	100% SCHEMATIC DESIGN ISSUE	J.G	A.M.	B.K.	14.02.25

0 0.1 0.2 0.3 0.4 0.5m  
SCALE 1:10 @ A1 ; SCALE 1:20 @ A3

0 0.5 1.0 1.5 2.0 2.5m  
SCALE 1:50 @ A1 ; SCALE 1:100 @ A3

## Appendix E – UPRCT Calculation Sheet

Project:	UPRCT Handbook Demonstration Example				
Site Address	Northmead				
Job No:	W4574-2				
Designer:					
Telephone:	(02) 9891 4633				
<b>Site Data</b>					
OSD Area:	Upper Parramatta River Catchment				
L.G.A	Parramatta City Council				
Site Area	0.101	ha	1,010	m <sup>2</sup>	
Total Roof Area	0.0876	ha	876	m <sup>2</sup>	
Area of Site draining to OSD Storage	0.101	ha	1,010	m <sup>2</sup>	Satisfactory
Residual Site Area (Lot Area - Roof Area)	0.013	ha			
Area Bypassing Storage	0	ha			
Area Bypassing / Residual Site Area	0.0%				
No. of Dwellings on Site	1				Satisfactory
Site Area per Dwelling	0.101	ha			
Roof Area per Dwelling	0.088	ha			
<b>Basic OSD Parameters</b>					
Extended Detention					
Basic SSR Vols	Ext Detention Storage	300	m <sup>3</sup> /ha	Total Storage	455 m <sup>3</sup> /ha
Basic SRDs	Primary Outlet	40	L/s/ha	Secondary Outlet	150 L/s/ha
<b>OSD Tank Bypass</b>					
Residual Lot Capture in OSD Tank	100%				
Adjusted SRDs	40	L/s/ha		150	L/s/ha
<b>OSD Calculations</b>					
Extended Detention					
Basic SSR Volume	Ext Detention Storage	30.30	m <sup>3</sup>	Total Storage	45.96 m <sup>3</sup>
Total Rainwater Tank Credits		0.00	m <sup>3</sup>		0.00 m <sup>3</sup>
Storage Volume				Total	45.96 m <sup>3</sup>
Storage Volume	Ext Detention Storage	30.30	m <sup>3</sup>	Flood Detention Storage	15.66 m <sup>3</sup>
OSD Discharges	Primary Outlet	4.04	L/s	Secondary Outlet	15.15 L/s
RL of Top Water Level of Storage	36.240	m		36.570	m
RL of Orifice Centre-line	35.600	m		35.600	m
Number of Orifices	1			1	
Estimated Downstream Flood Level	35.00	1.5 yr ARI		35.00	100 yr ARI
Downstream FL - RL of Orifice Cente-line	-0.60	Satisfactory	Satisfactory	-0.60	m
Design Head to Orifice Centre	0.640	m	TWL Ext Detn Storage - RL Orifice	0.640	m
Calculated Orifice Diameter	49	mm	Satisfactory	Satisfactory	95 mm
<b>Overflow Weir &amp; Freeboard Calculation</b>					
RL of Minimum Habitable Floor Level				37.500	m
RL of Minimum Garage Floor Level				37.400	m
Length of Overflow Weir				3.60	m
Site Runoff Coefficient	Parramatta City Council				
Storm Intensity (5 min 100 yr ARI)				0.95	
Peak Flow over Weir				215	mm/h
Depth of Flow over Weir				57.3	L/s
				45	mm

Freeboard to Habitable Floor  
Freeboard to Garage Floor

Satisfactory      885      mm  
Satisfactory      785      mm